


NOTE:

NOTES:


- This drawing to be read in conjunction with all relevant Architects and Engineers drawings.
- Do not scale drawing.
- All dimensions in millimeters unless otherwise stated.
- All building works to comply with current building regulations.
- All Foul & Surface Water Drainage To B.S. 4514 / I.S. EN 1329-1
- All levels to OD Malin Head

LEGEND:


- Denotes new surface water manhole
- Denotes new surface water access junction
- Denotes new surface water line
- Denotes RWP + BIGT
- Denotes permeable paving Type B interception storage
- Denotes road gully
- Denotes new foul water manhole
- Denotes new foul water inspection chamber in accordance with Irish Water STD-WW-13
- Denotes new foul water line
- Denotes BIGT
- Denotes new 100Ø P.E. watermain
- Denotes existing uPVC watermain
- Denotes new boundary box water meter
- Denotes sluice valve
- Denotes fire hydrant
- Denotes air valve
- Denotes washout

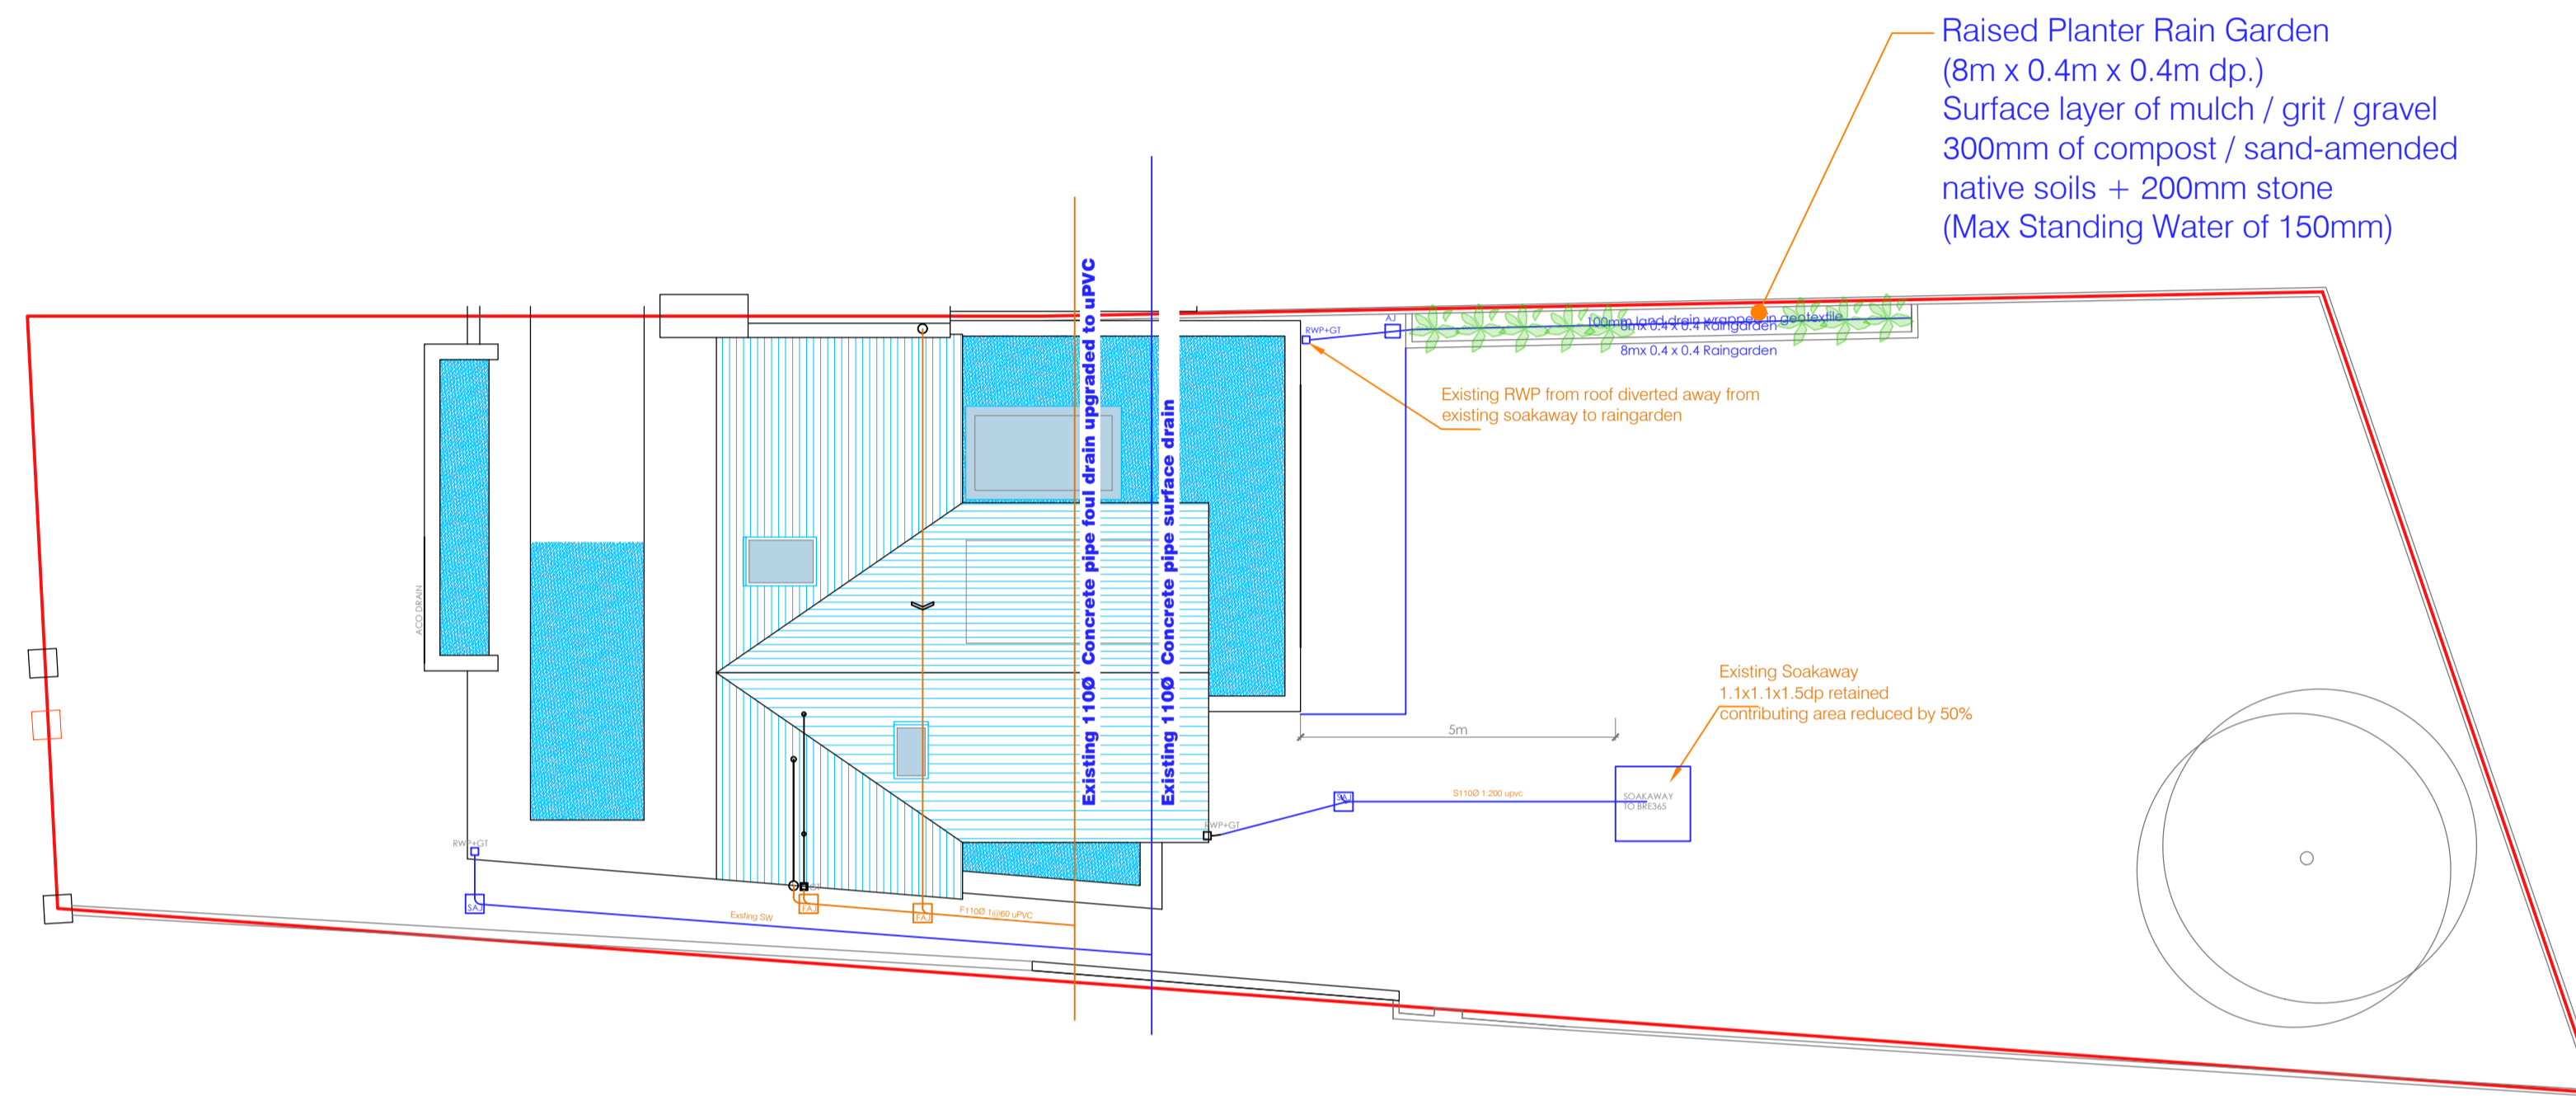


SURFACE DRAINAGE LAYOUT
Scale 1:100

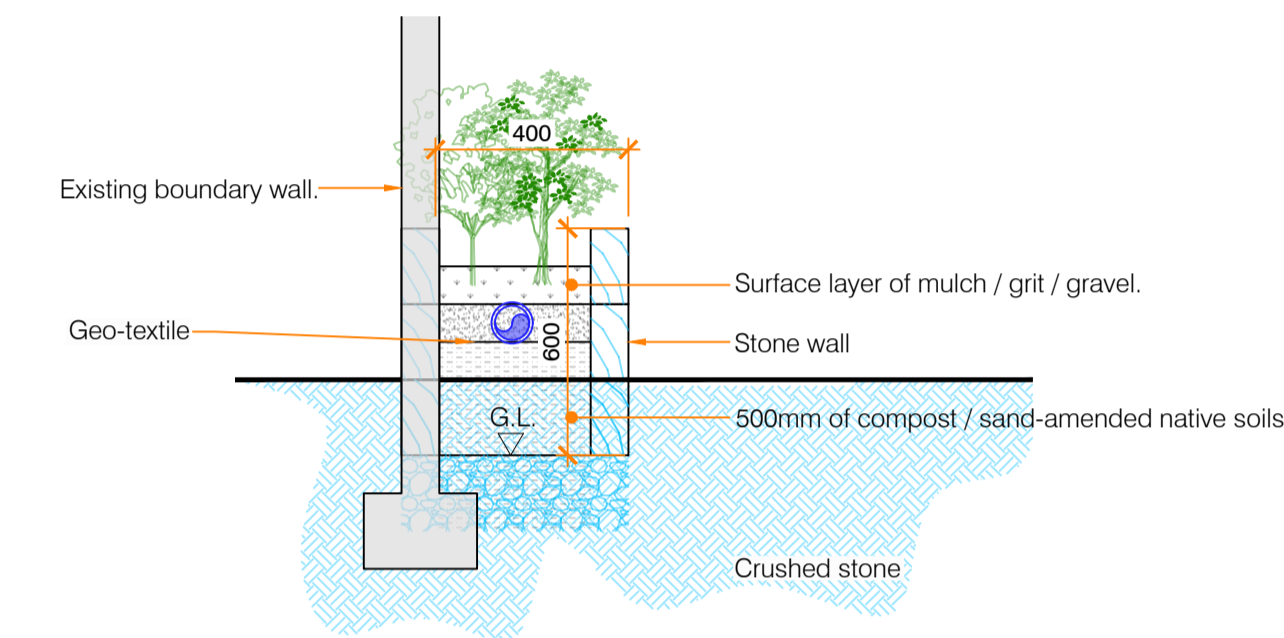

SECTION Y-Y
Scale 1:20

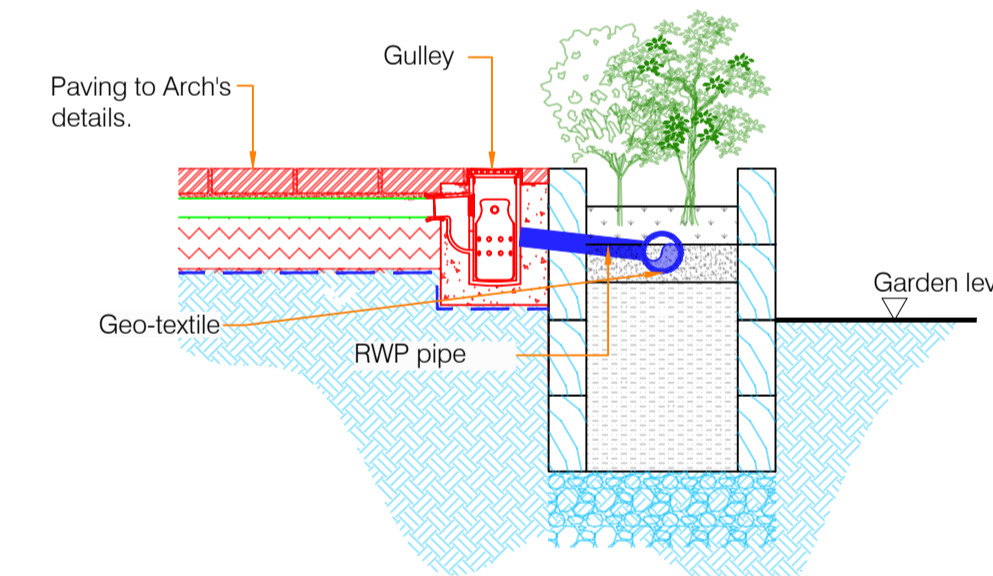

DETAIL A (Cross Section)
Scale 1:20

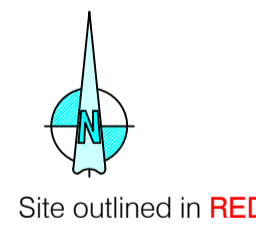

NOTES:

- This drawing to be read in conjunction with all relevant Architects and Engineers drawings.
- All concrete to be grade 35n/20 with a crushing strength of 35n/mm² after 28 days.
- Minimum of 150mm bearing on all precast elements.
- Reinforcement to have a minimum of 40mm clear cover of concrete unless otherwise noted.
- Do not scale drawing.
- All dimensions in millimeters unless otherwise stated.
- Foundations to be formed atleast equal depth to existing foundations on suitable bearing strata with capacity of 100 kn/sq.m. to be inspected by engineers office.

- Engineers office to be notified 24 hours before concrete pour.
- Foundation design subject to no presence of water. Engineers office to be notified if soil conditions differ.
- D.P.C., D.P.M. and Radon Barrier to Architects specification
- Refer to Architects drawings for setting dimensions and finishing details.
- All dimensions and setting out to be confirmed and checked with Architects drawings. Any discrepancies to be disclosed to architects and Engineers office.
- All building works to comply with current building regulations.

LEGEND:

- Denotes new blockwork
- Denotes new brickwork
- Denotes new stud walls
- Denotes existing structure
- Denotes support steel under
- Denotes support walls under
- Denotes direction of span of new floor joists
- Denotes slope direction of roof

Rev	Revision description	Date	Drawn	Design	Check
B	Issued for Construction	Mch 2024	TON		
A	Issued for Tender	AUG 2022	KD	RC	TON

Job Title:
13 Wainsfort Avenue, Terenure Dublin 6 D6W X974
Drawing Title:
DRAINAGE LAYOUT

Client:
Breda Kearney
Drawing number:
5859/S104

Scale:
A1 @ 1:50 1:20 & 1:10
Date:
OCT22

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