


**PROPOSED SITE BOUNDARY TREATMENT - EAST ELEVATION**  
Scale 1:200

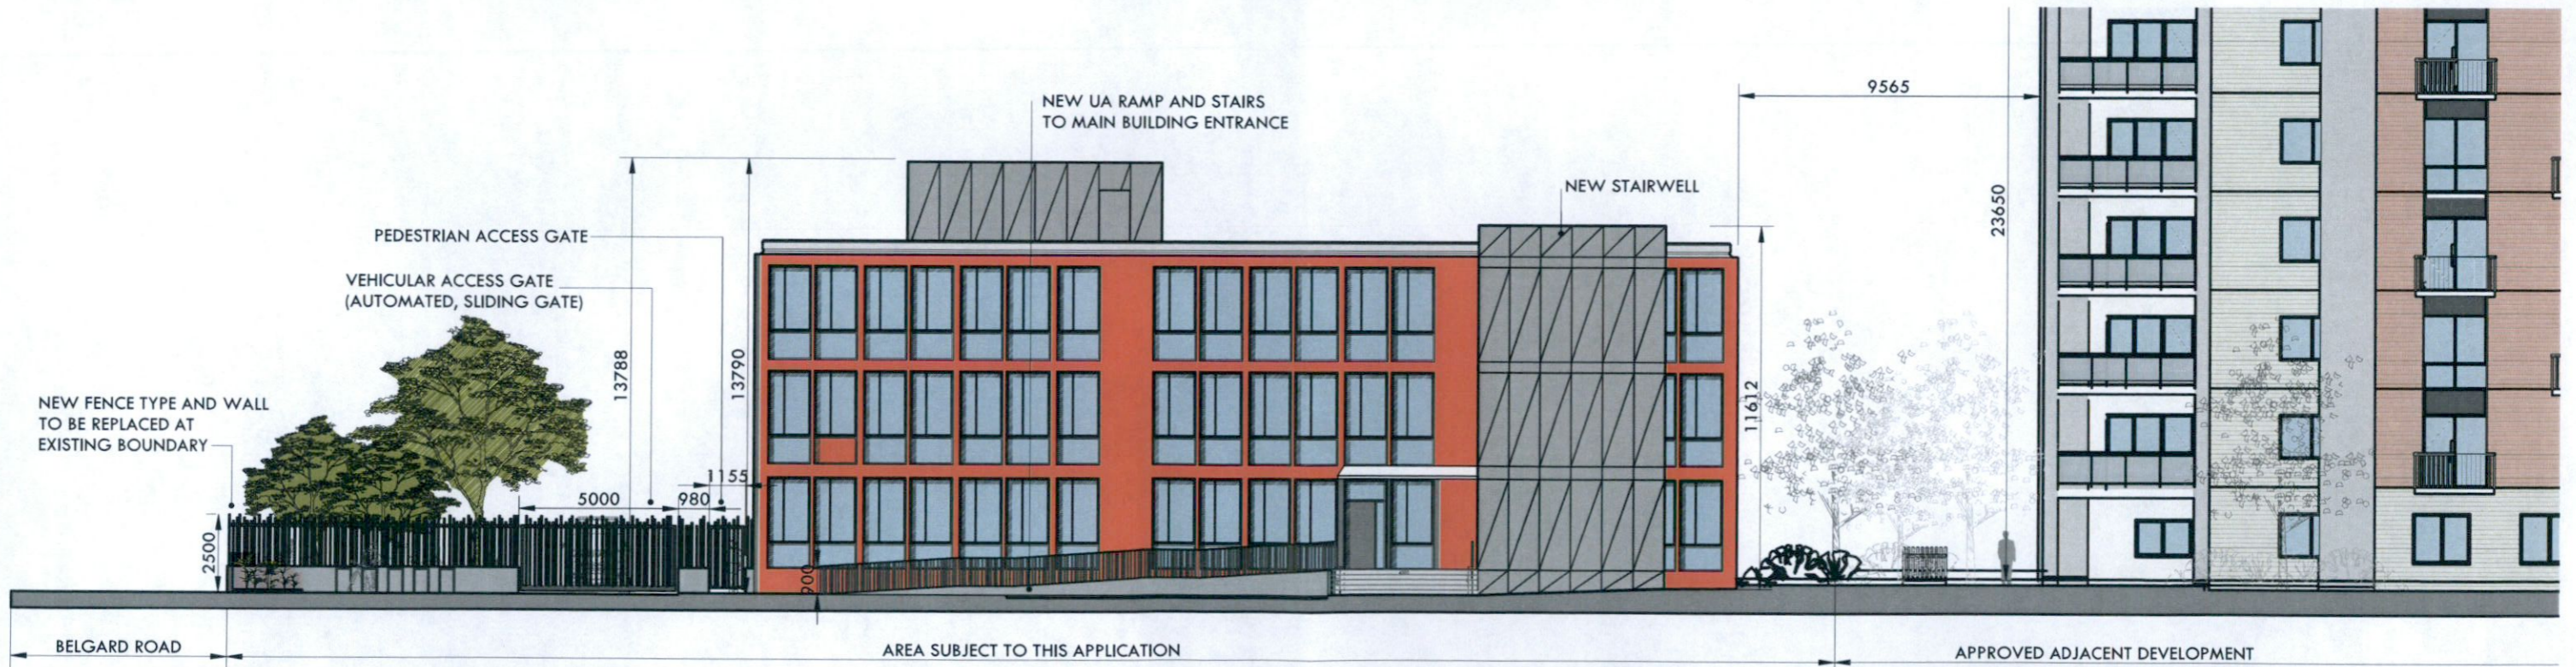

**PROPOSED SITE BOUNDARY TREATMENT - NORTH ELEVATION**  
Scale 1:200


NOTE: WHERE NEW FENCE TYPE IS PROPOSED AS MARKED IN DRAWINGS, FENCE THORUGHTOUT SHALL BE:  
50mm x 50mm x 5mm GALVANISED AND PAINTED MILD STEEL SQUARE BOX SECTION WELDED TO 75mm x 75mm STEEL PLATE CAST INTO TO CONCRETE CAPPING. SPACING VARIES BETWEEN 25 mm AND 100mm. HEIGHT VARIES BETWEEN 1500mm AND 2400mm.

Rev.	Date	Description	Drawn By	Checked By

Project	REDEVELOPMENT OF GLEN ABBEY, TALLAGHT, DUBLIN 24	Drawing No.	L(80)07
Client	HSE ESTATES	Revision	
Drawing title	PROPOSED SITE BOUNDARY TREATMENT		
Job No.	44007	Date	MARCH 2021
Scale	1:200	Drawn By	LM
Checked By	JN	Released	



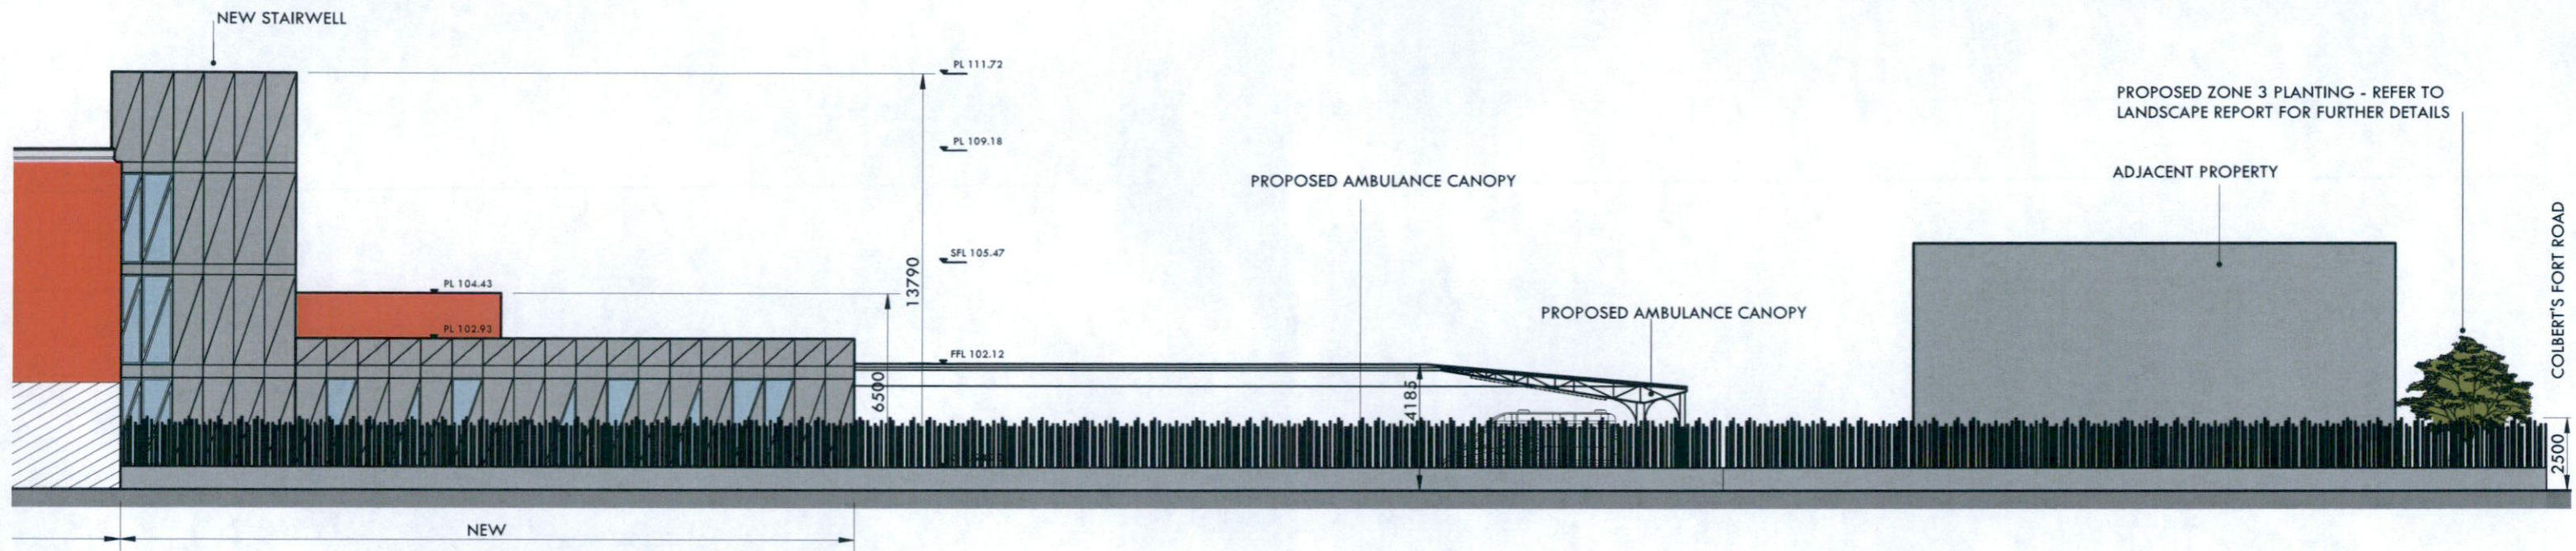

**PROPOSED SITE BOUNDARY TREATMENT - WEST ELEVATION**  
 Scale 1:200

NOTE: WHERE NEW FENCE TYPE IS PROPOSED AS MARKED IN DRAWINGS, FENCE THOROUGHOUT SHALL BE:  
 50mm x 50mm x 5mm GALVANISED AND PAINTED MILD STEEL SQUARE BOX SECTION WELDED TO 75mm x 75mm STEEL PLATE CAST INTO TO CONCRETE CAPPING. SPACING VARIES BETWEEN 25 mm AND 100mm. HEIGHT VARIES BETWEEN 1500mm AND 2400mm.

Rev	Date	Description	Drawn By	Checked By

Project	REDEVELOPMENT OF GLEN ABBEY, TALLAGHT, DUBLIN 24	Drawing No.	L(80)08
Client	HSE ESTATES	Revision	
Drawing Title	PROPOSED SITE BOUNDARY TREATMENT	Released	
Job No.	44007	Date	MARCH 2023
Scale	1:200	Drawn By	LAM
Checked By	JH	Released	