




01 ESB Substation Typical Plan
705 1:20@A1

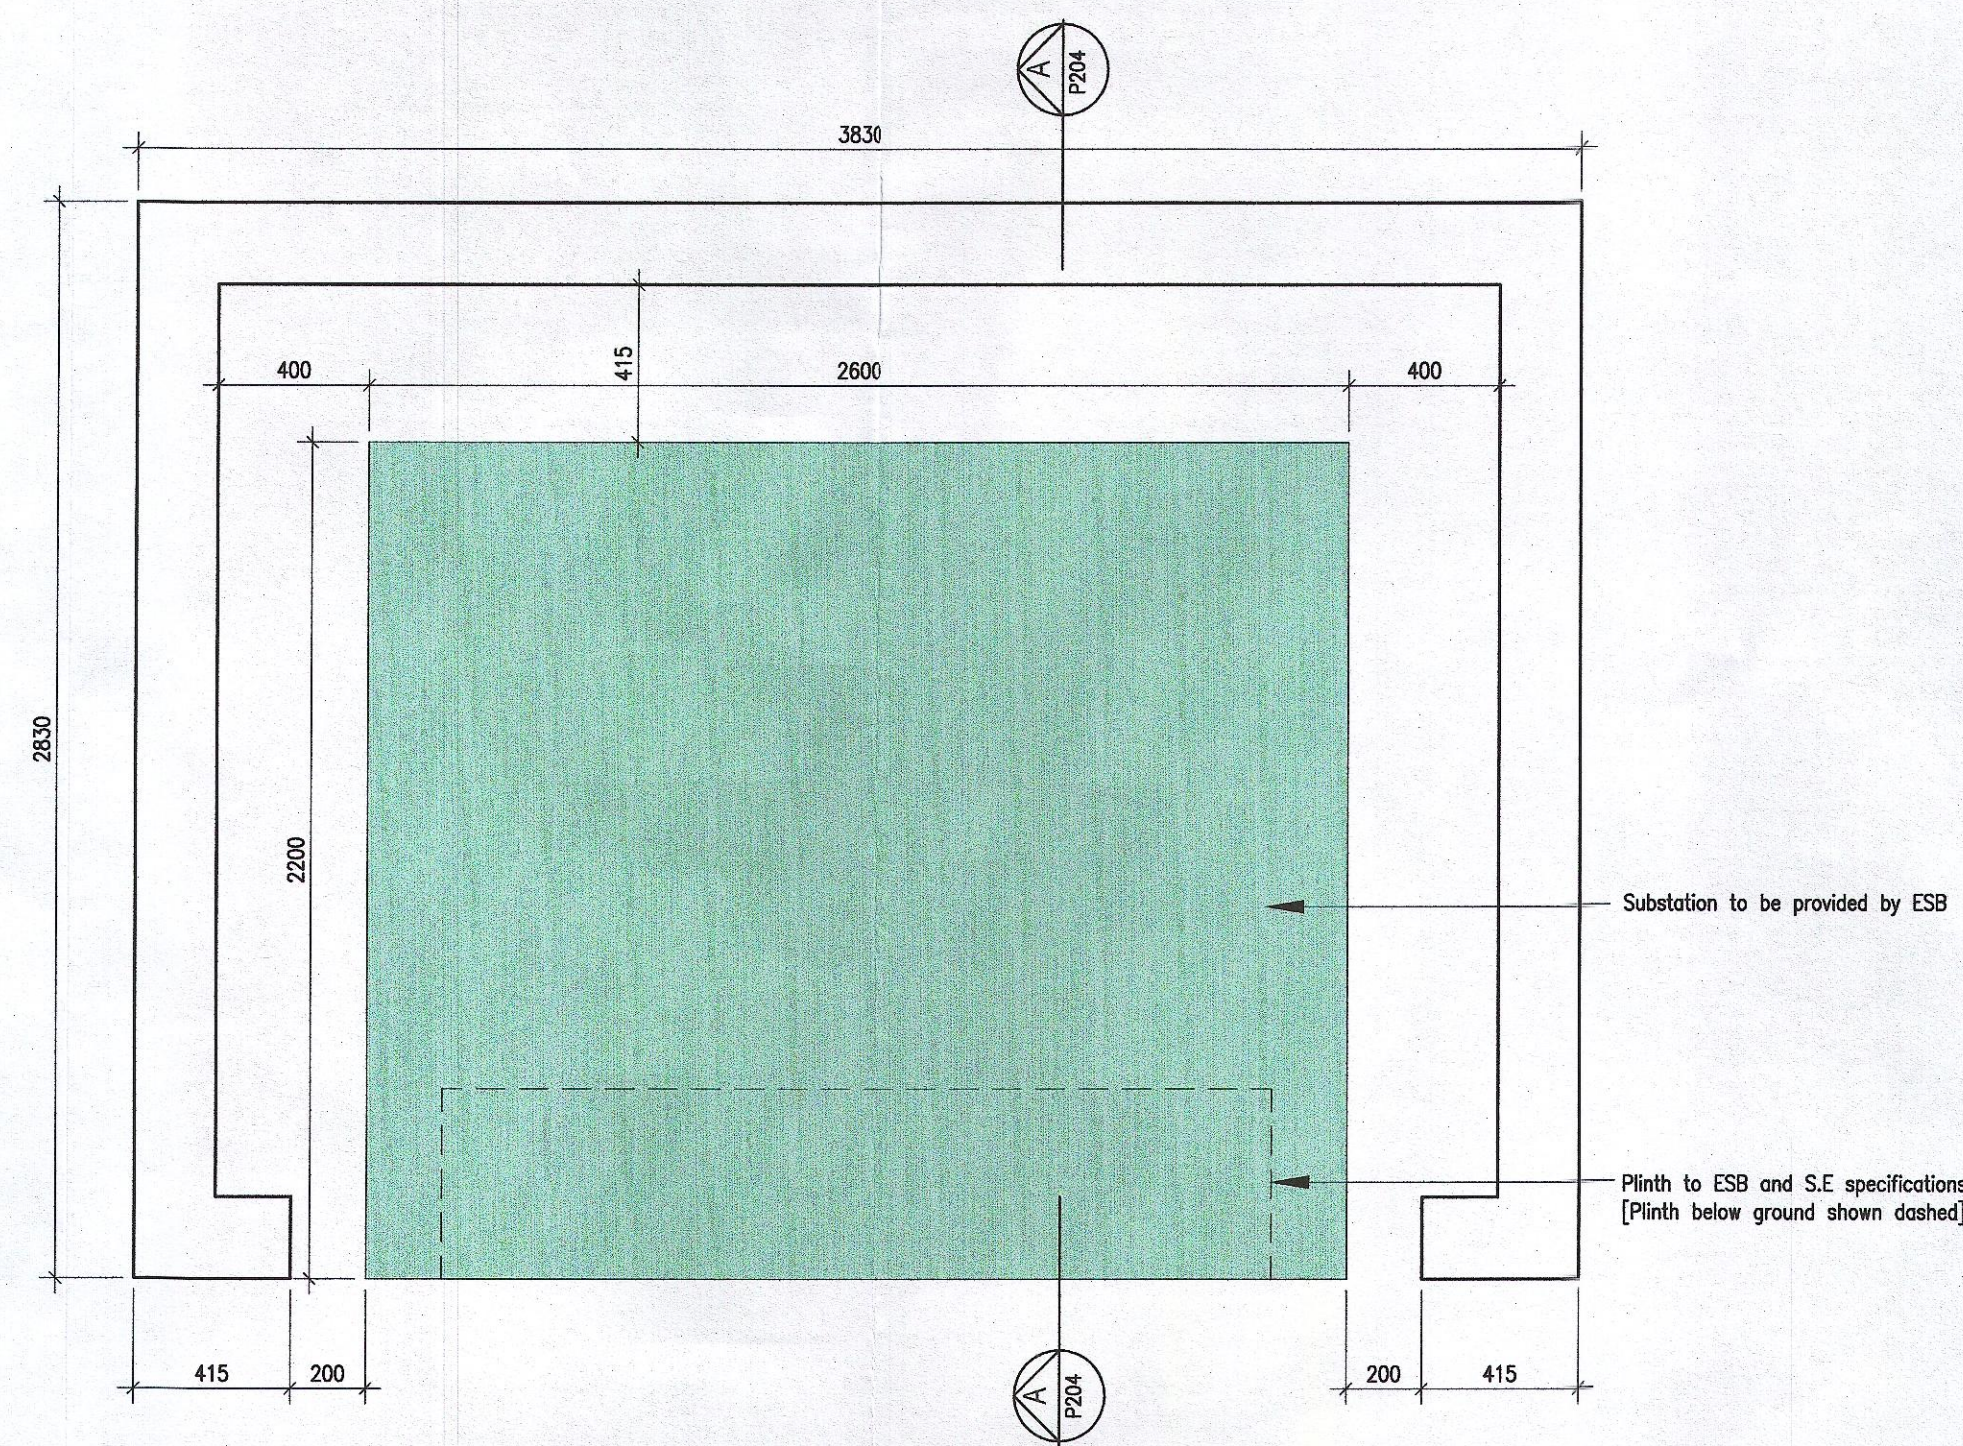


02 ESB Substation Typical Roof Plan
705 1:20@A1

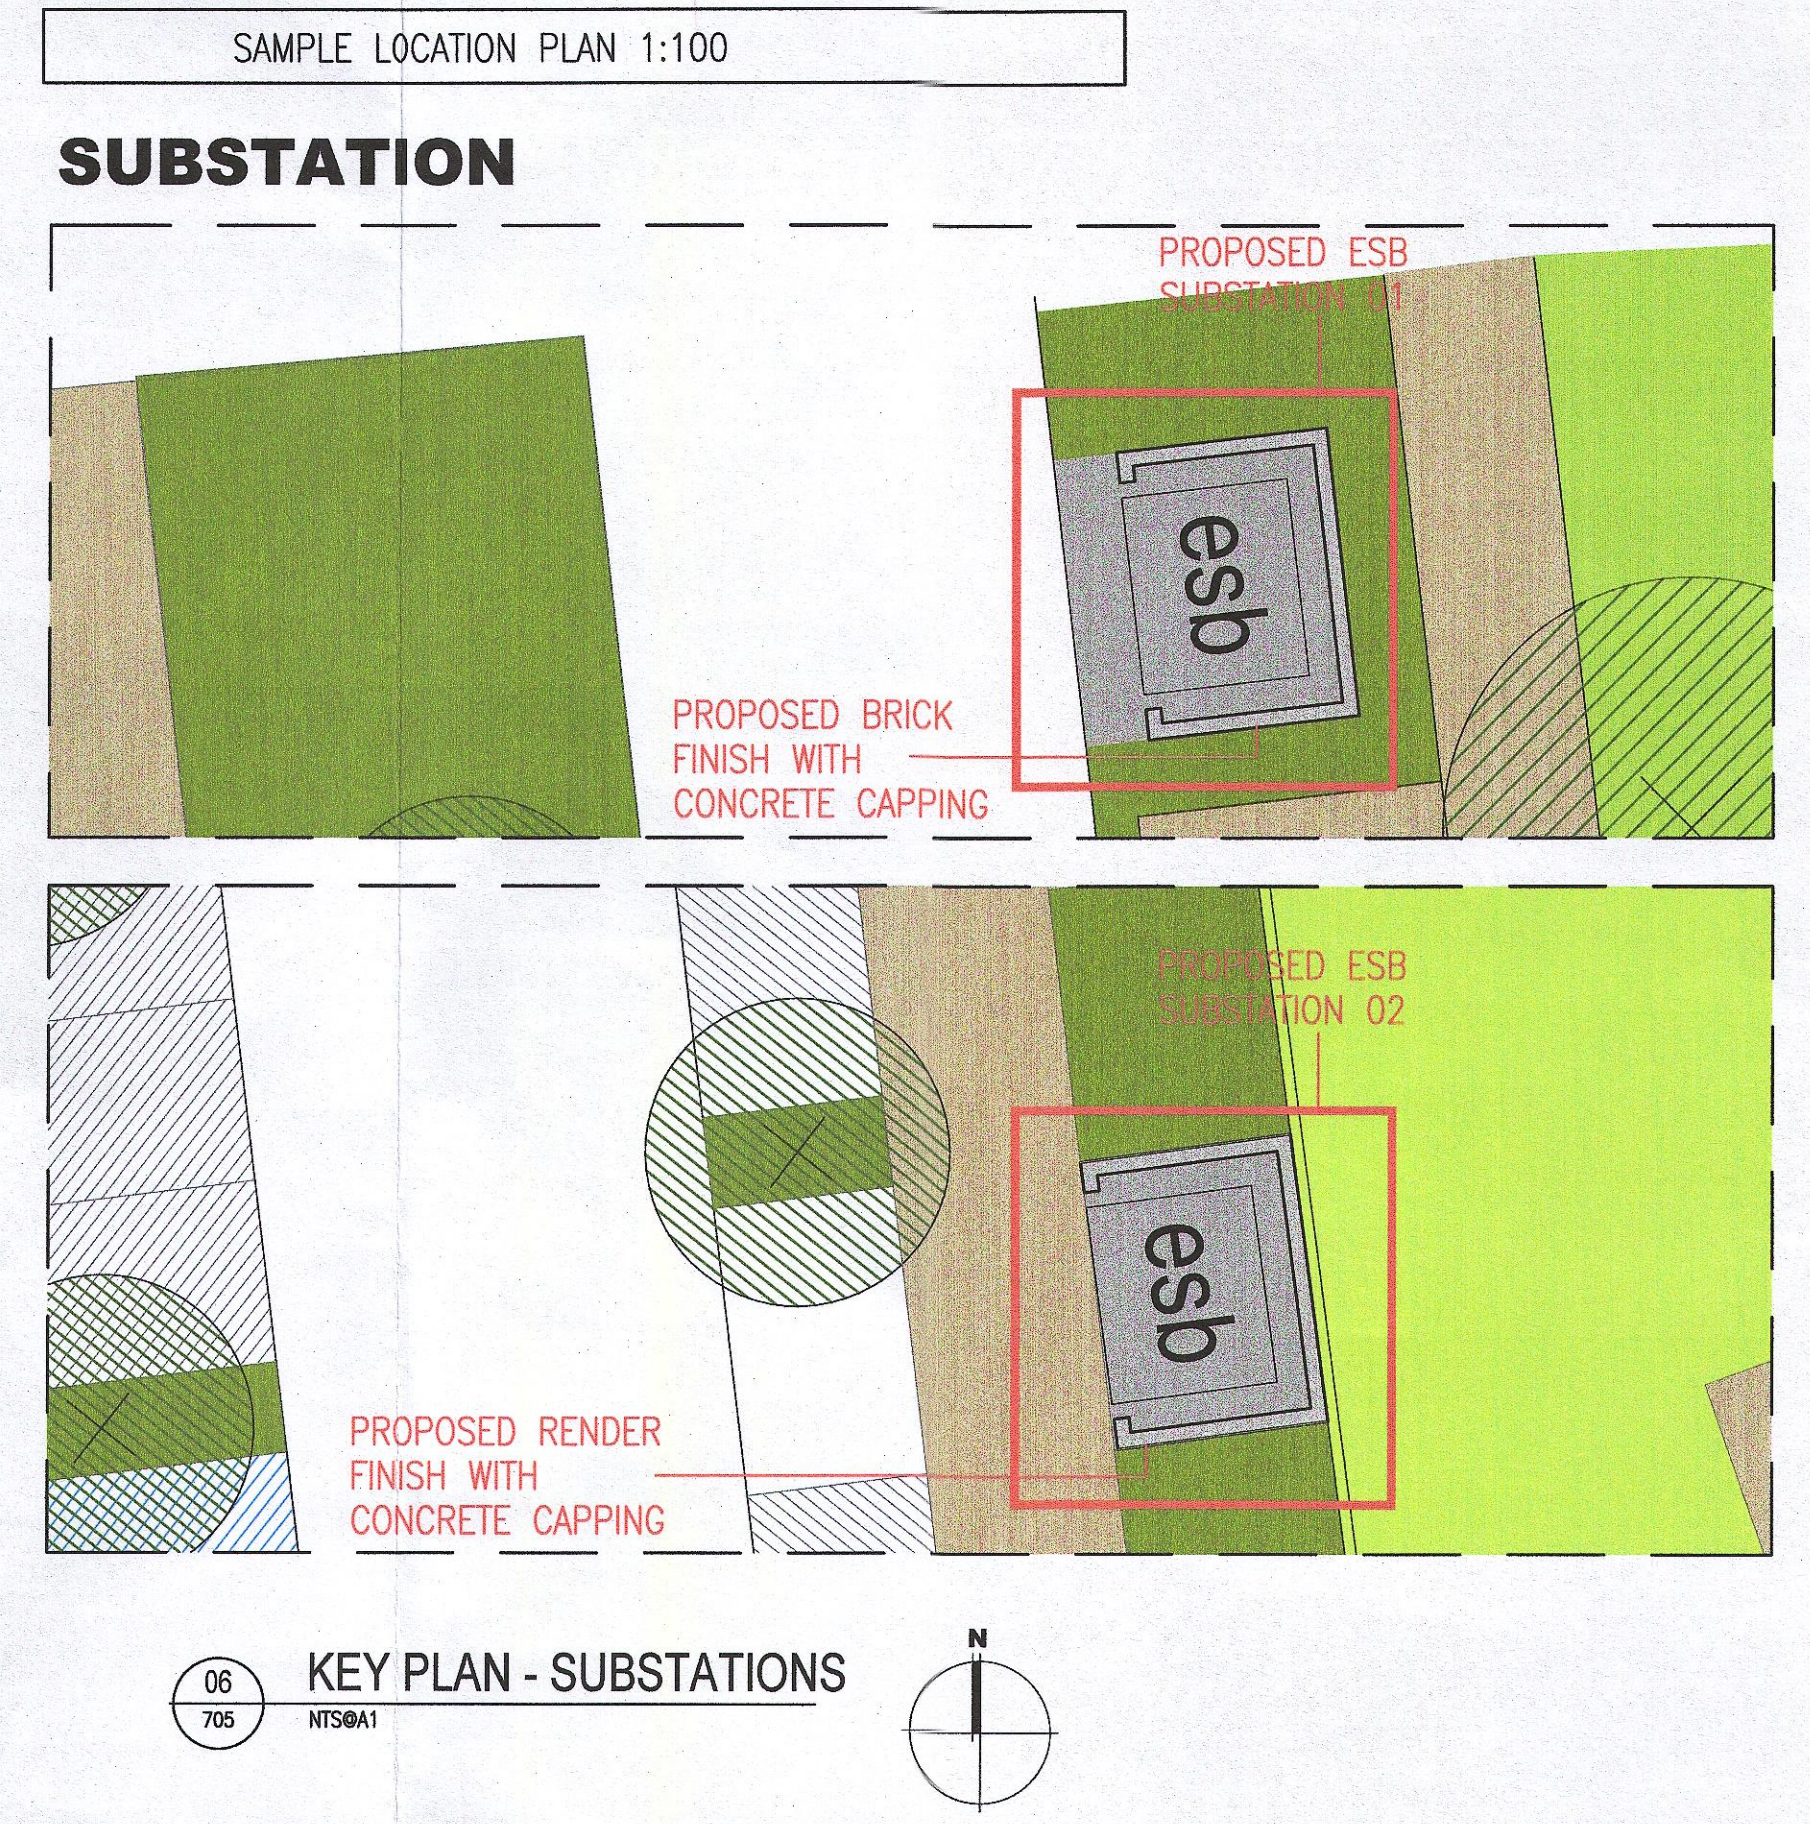


06 KEY PLAN - SUBSTATIONS
705 NTS@A1

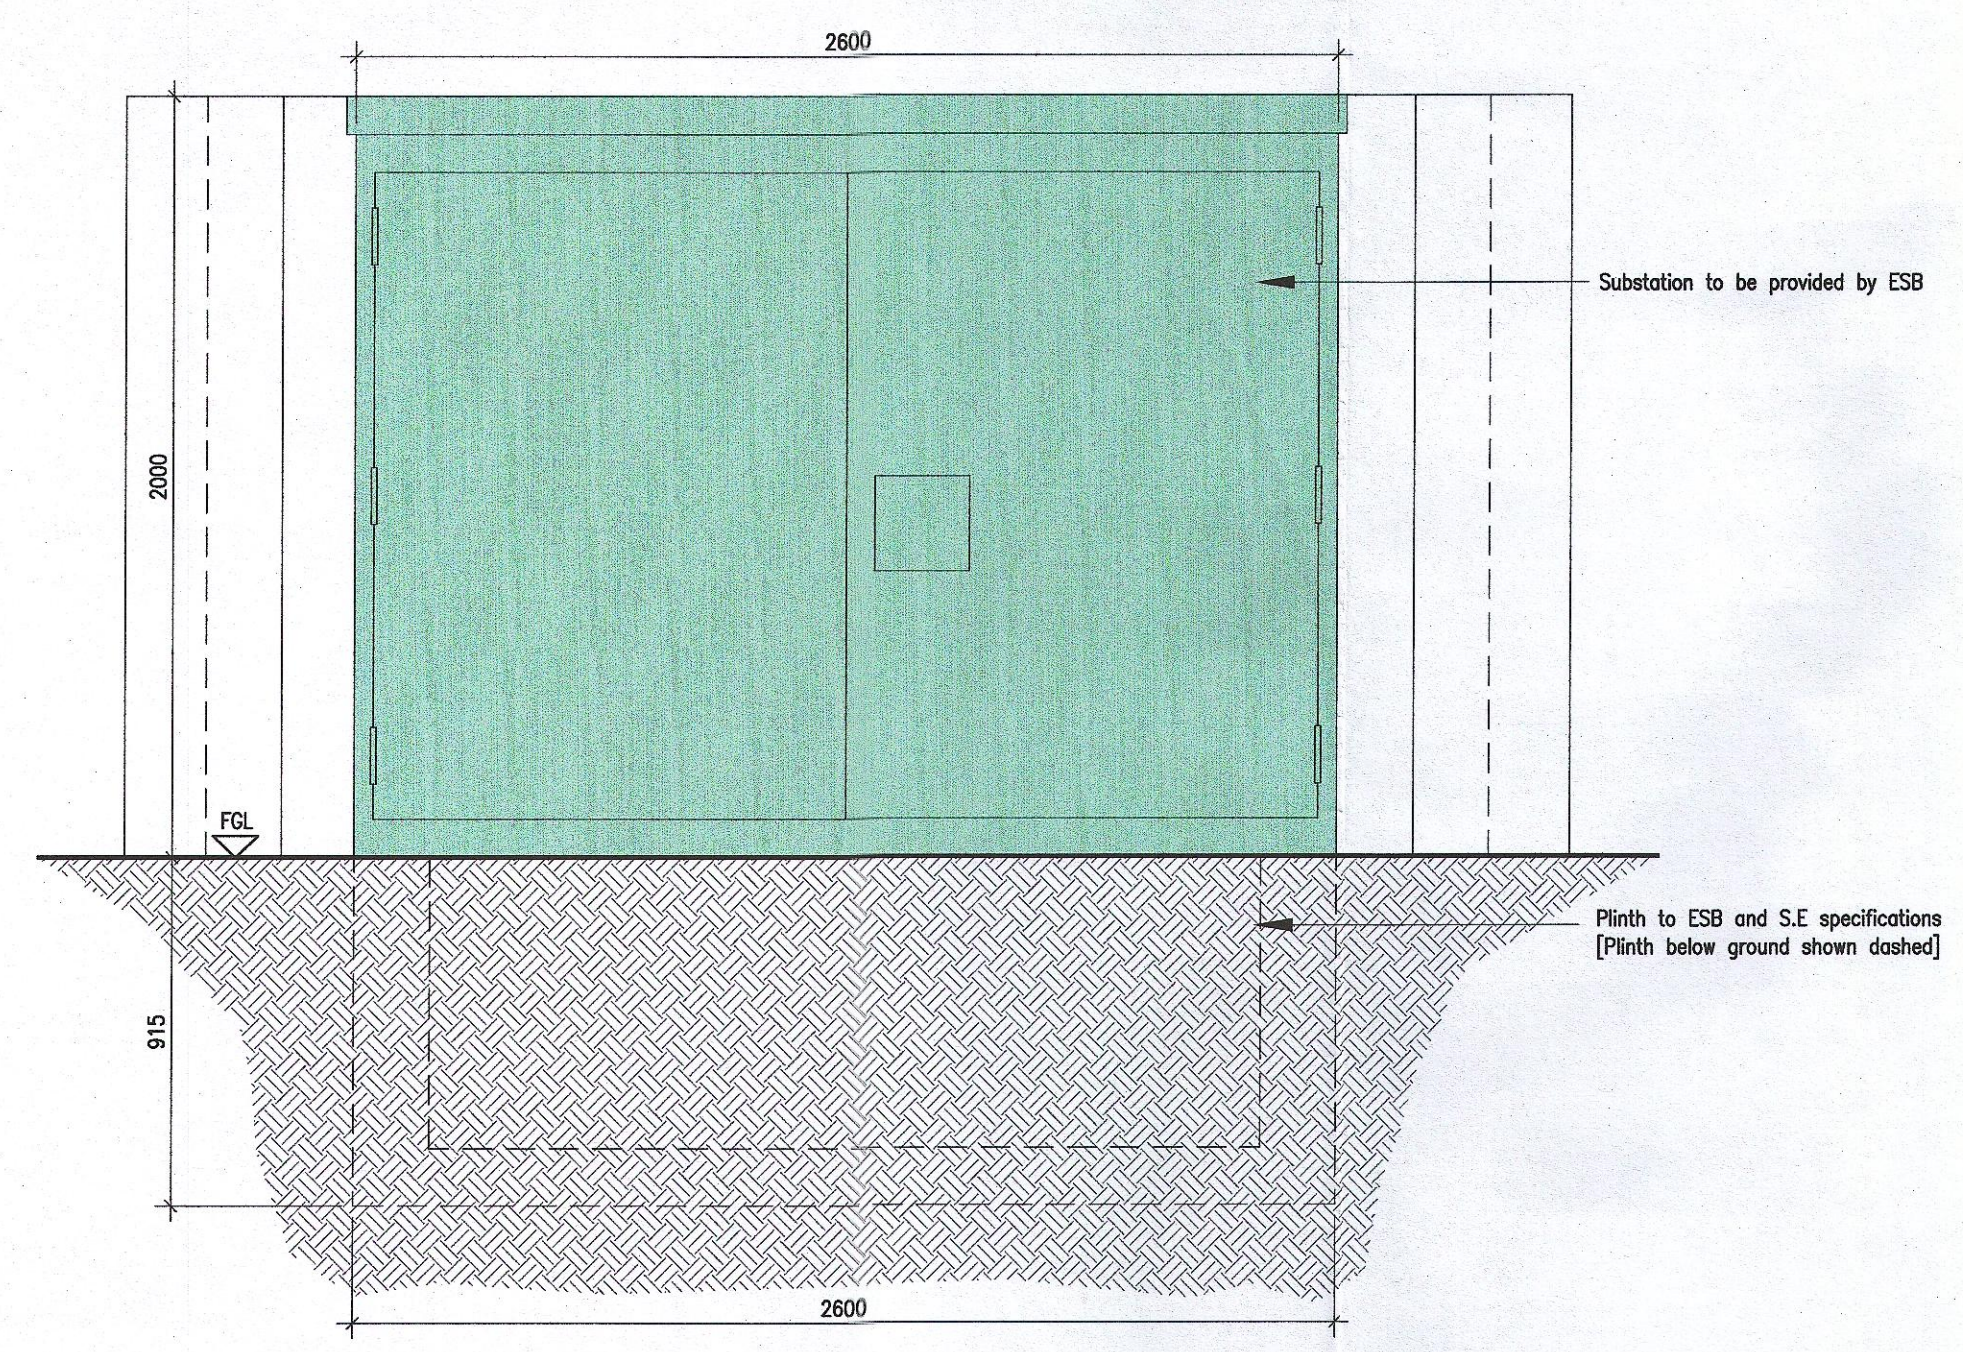

03 ESB Substation Typical Front Elevation
705 1:20@A1

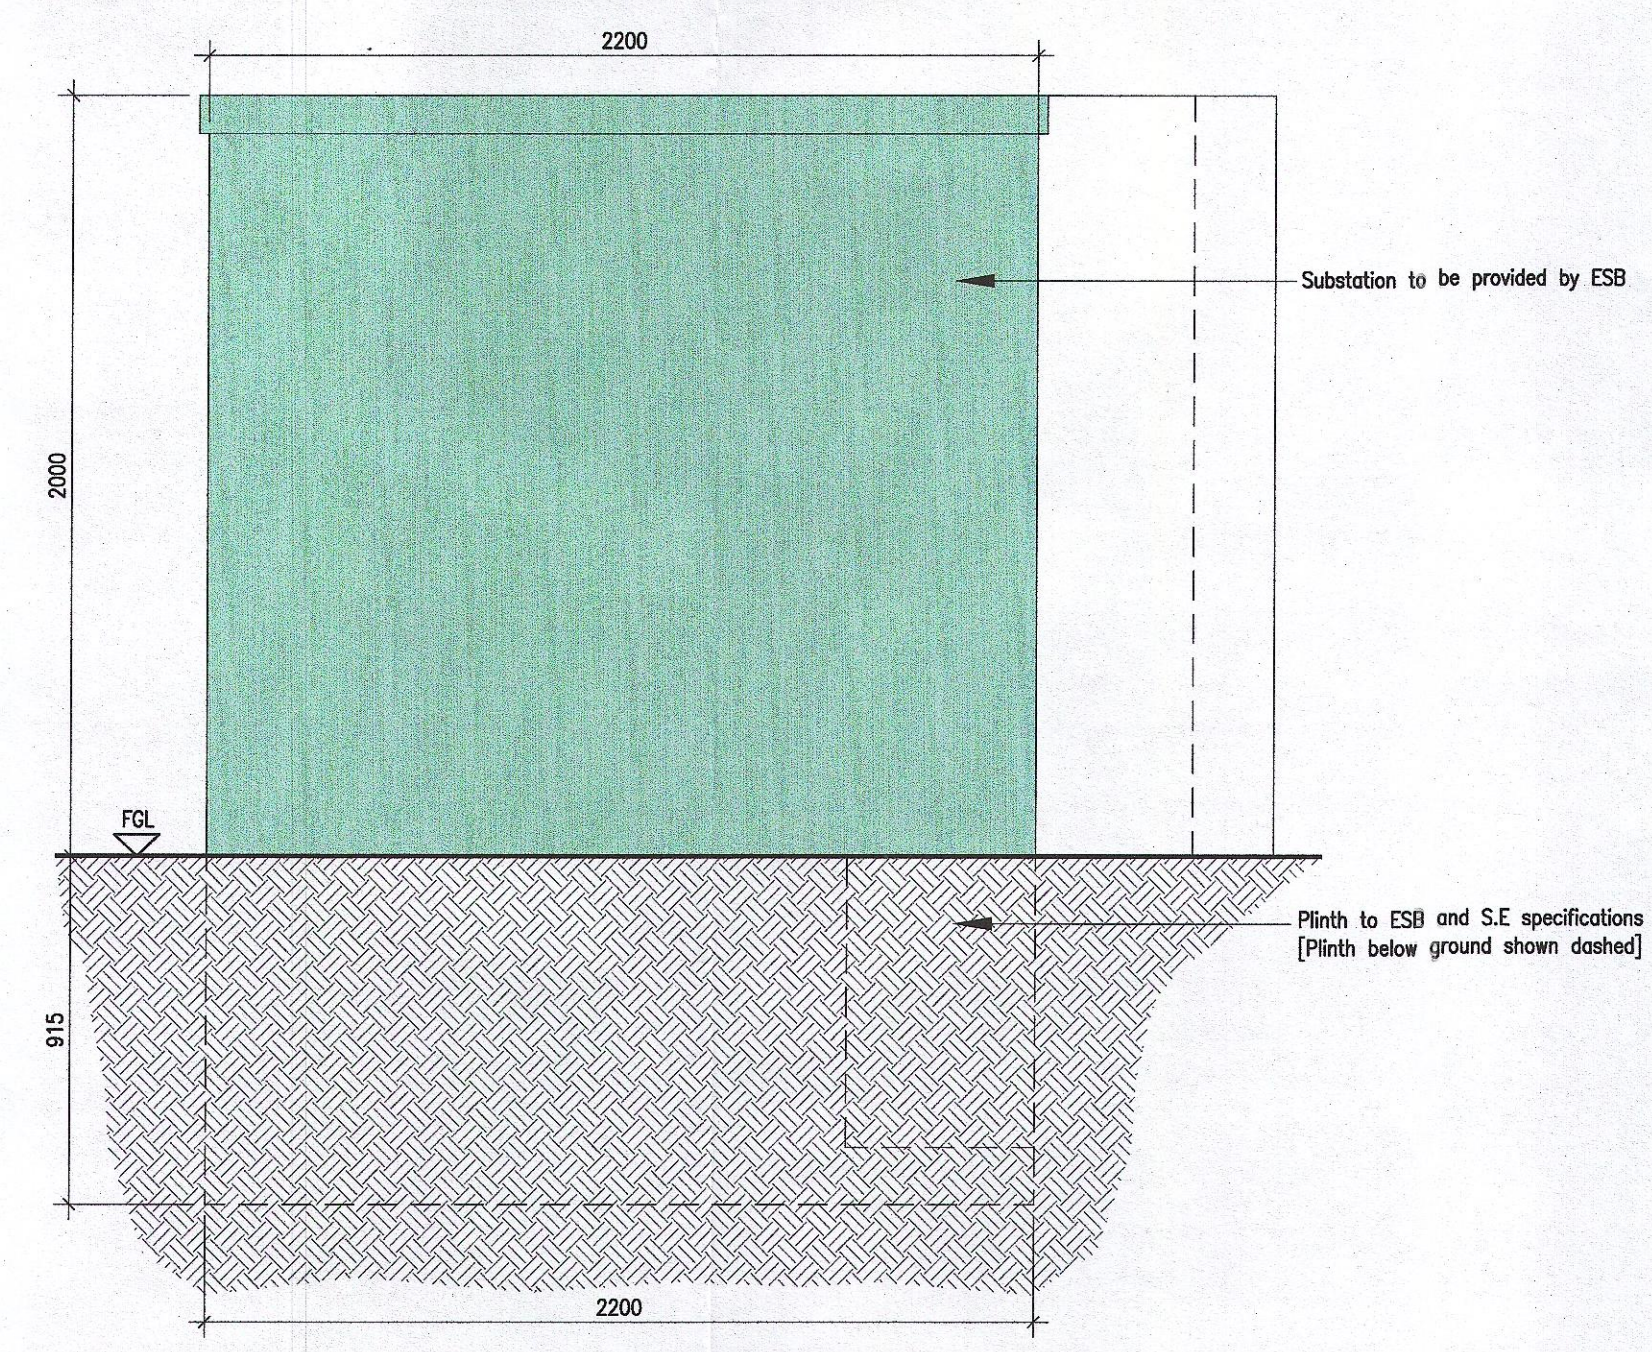

04 ESB Substation Typical Side Elevation
705 1:20@A1

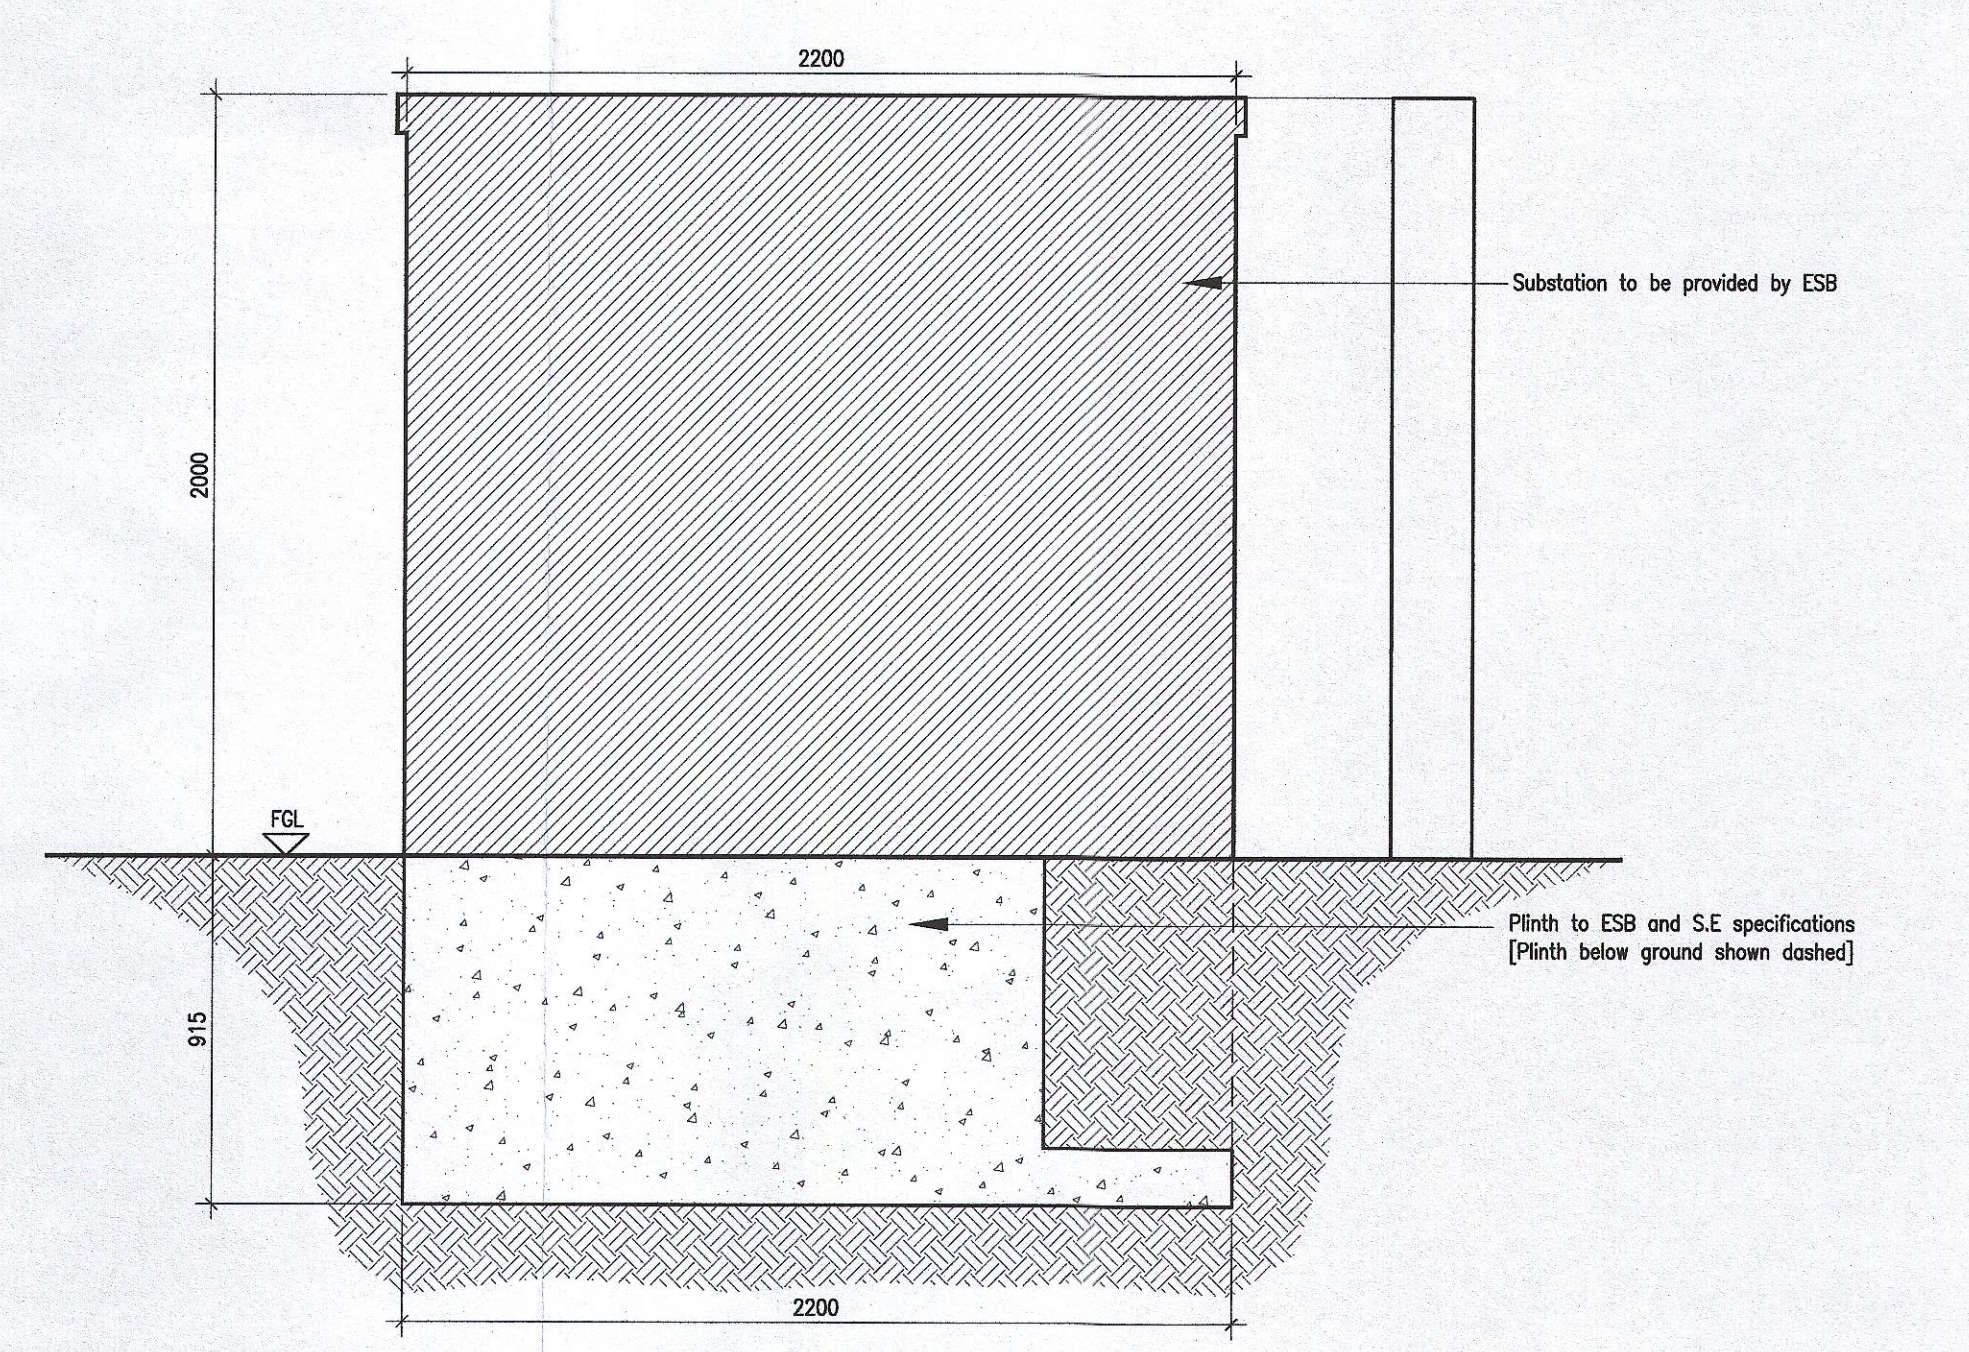

05 ESB Substation Typical Section A-A
705 1:20@A1

- Notes
1. Copyright Reserved
 2. Work to Egress dimensions only. Do not scale drawing
 3. The contractor is responsible for checking all levels and dimensions on site and shall refer all discrepancies to the Architect
 4. Where appropriate, for details of r.c. structure, or mechanical and electrical details, see Engineers drawings
 5. Proprietary items shall be fixed in strict accordance with manufacturers instructions.
 6. Sizes of proprietary items shall be checked with manufacturer.
 7. The contractor shall be responsible for the coordination of structure, finishes and services.

Issue Status	
Progress	
Planning Application	■
Fire Cert	
Disability Cert	
Tender	
Construction	
As Built	
Information Only	

No.	Date	Revision	Initials
01	27/01/23	Planning Application	RT

Project: Adamstown Extension - Clonburris SDZ Residential Development

Drawing Title: Proposed Electrical Substation

Drawing No: 6268-P-705

Scale: 1:20@A1 Rev: 01 Drawn: RT Date: Jan' 23

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