



SCALE 1:100

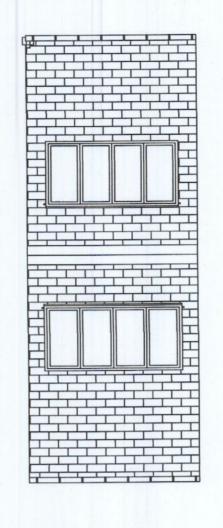

Roof Plan SCALE 1:100

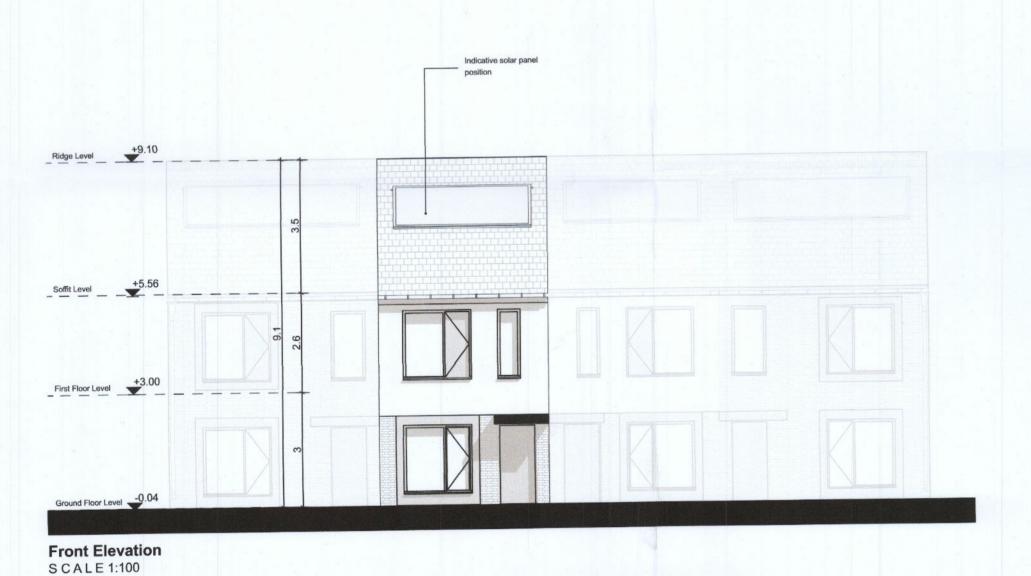

		Indicative solar panel position
Ridge Level +9.10		
	ro.	
Soffit Level+5.60		
First Floor Levy+3.00	2.6	
	ю.	
±0.00		

Rear Elevation SCALE 1:100

Typical Section SCALE 1:100


House Type B - Gross Internal Area				
Area Type	Proposed Area	DoHPCLG Area Min.		
Ground Floor	43.1 m ²			
First Floor	43.1 m ²			
Grand Total	86.2 m ²	73.0 m ²		

House Typ	oe B - Space Provision 8	& Room Sizes
Area Type	Proposed Area	DoHPCLG Area Min.
Aggregate Bedroom Area	25.8 m ²	25.0 m ²
Aggregate Living Area	34.2 m ²	30.0 m ²
Main Living Area	19.2 m ²	13.0 m ²

	House Type B - Storage Pr	ovision
Area Type	Proposed Area	DoHPCLG Area Min.
Storage	4.0 m ²	4.0 m ²
Refer to Site Plan for:	- Finished floor levels to	survey datum

			_
Unit Number: 8, 10, 13, 14,	21, 22,	43, 47, 48, 49, 50, 81, 82, 83, 86, 87, 88,	
219, 220.			

- Handing of type for each unit

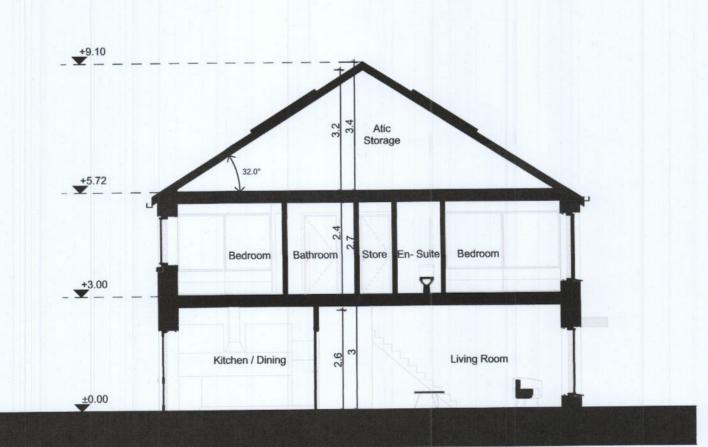


Notes

Do not scale from this drawing.
Use figured dimensions only.
All errors and omissions to be reported to the Architect.
This drawing is to be read in conjunction with relevant consultant's drawings.
All dimensions are in millimetres and all levels are in meters to match Datums unless otherwise noted.

This drawing is for planning purposes only and not for construction. This drawing or design may not be reproduced without permission.

NOTES ON FINISHES: TO BE FINISHED IN SLATE OR CONCRETE ROOF ROOF: TILES IN SELECTED COLOUR OR SIMILAR APPROVED SELECTED CLAY BRICKWORK WHERE INDICATED WALLS: OTHERWISE SELECTED SELF-COLOURED RENDER ALL WINDOWS AND DOORS, FRAMES AND LEAFS TO BE JOINERY: ALUMINIUM POWDER COATED TO APPROVED COLOUR OR UPVC OR PAINTED TIMBER TO APPROVED COLOUR. OBSCURE GLAZING WHERE INDICATED TO SENSITIVE WINDOWS. RAINWATER GOODS: GUTTERS, DOWNPIPES AND FIXINGS TO BE uPVC OR ALUMINIUM POWDER COATED TO SELECTED COLOUR TO MATCH ROOF SLATES. INDICATIVE SOLAR PANEL POSITION, FINAL SOLAR SOLAR PANELS: PANEL POSITION DEPENDS ON HOUSE ORIENTATION. THE SOLAR PANELS INDICATED ARE A PROVISIONAL OPTION TO SATISFY RENEWABLE ENERGY REQUIREMENTS OF BUILDING REGULATIONS PART L. SOLAR PANELS MAY BE OMITTED IN FAVOUR OF

ALTERNATIVE RENEWABLE ENERGY OPTIONS.

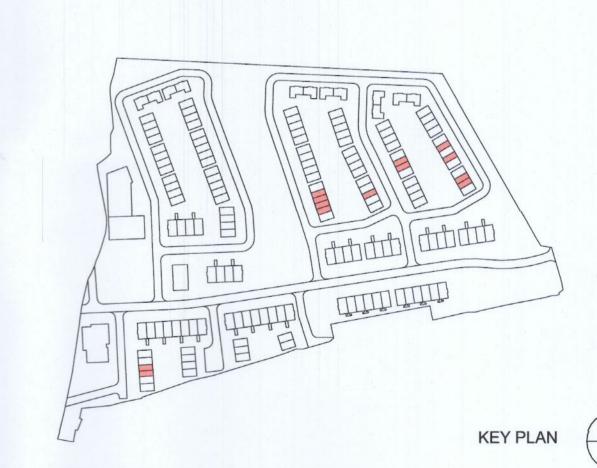

Planning Application
- Additional Information

DAVEY SMITH

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Layout ID: PH 004 - House type B 2B Mid Terrace

Project: Clonburris, K1

Scale: 1:100
Job No: 2004
Series:
Date: 22/11/2022

Drawing Name: Proposed Plans, Section and Elevations