

Stone Wall Elevation (Wall Type C) (PUBLIC FACING BOUNDARY) Scale 1:20

GARDEN TERRACE RAILING TYPE C (APARTMENTS NO. 3 & 4):

Bow Top Railing 850mm height panel (900mm total height of GL)


Panel: Constructed using either 12mm solid round bars at maximum 100mm gap Rails: 2 no horizontal flat rails either 30 x 10 for each infill. Bars welded at each punched

Posts: 50 x 50X1500mm hot dipped galvanised post to BS EN9 ISO 1461:2009 after fabrication and subsequently electrostatically powder coated in a plant complying to EN

Fixings: angle cleats and 10mm anti vandal bolts and nuts Method of setting posts: Erect posts plumb and level in 25n concrete bases minimum size 350 x 350 x 600mm or as

recommended by supplier, set 100mm below ground level Conformity: Submit manufacturers and installer certificates to BS 1722-9

FENCE TYPE C - Steel fence screen front private terraces Scale 1:20

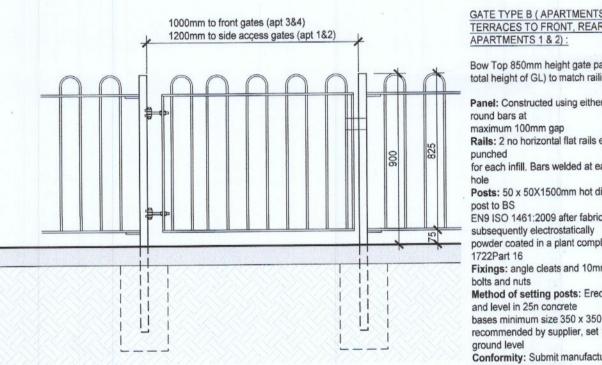

GATE TYPE B (APARTMENTS NO. 3 & 4 TERRACES TO FRONT, REAR ACCESS TO APARTMENTS 1 & 2):

Bow Top 850mm height gate panel (900mm total height of GL) to match railings.

Panel: Constructed using either 12mm solid round bars at Rails: 2 no horizontal flat rails either 30 x 10


for each infill. Bars welded at each punched Posts: 50 x 50X1500mm hot dipped galvanised post to BS EN9 ISO 1461:2009 after fabrication and


powder coated in a plant complying to EN Fixings: angle cleats and 10mm anti vandal bolts and nuts Method of setting posts: Erect posts plumb and level in 25n concrete bases minimum size 350 x 350 x 600mm or as

recommended by supplier, set 100mm below ground level Conformity: Submit manufacturers and installer certificates to BS 1722-9 Fittings: Drop Bolts & Recievers, Locking Device (Padlock not Supplied)

Hinge: 22mm 90° Hinge

Gate - private curtilage

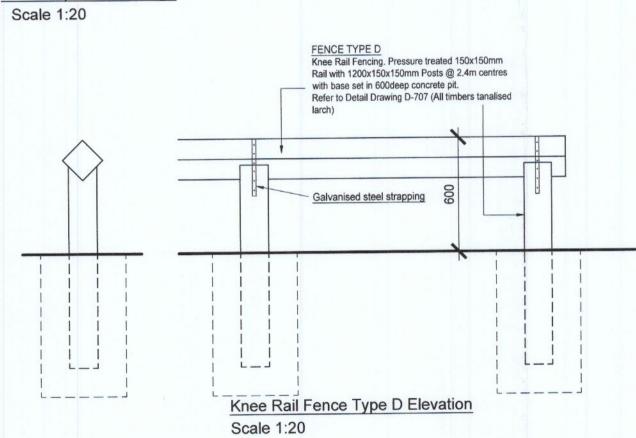


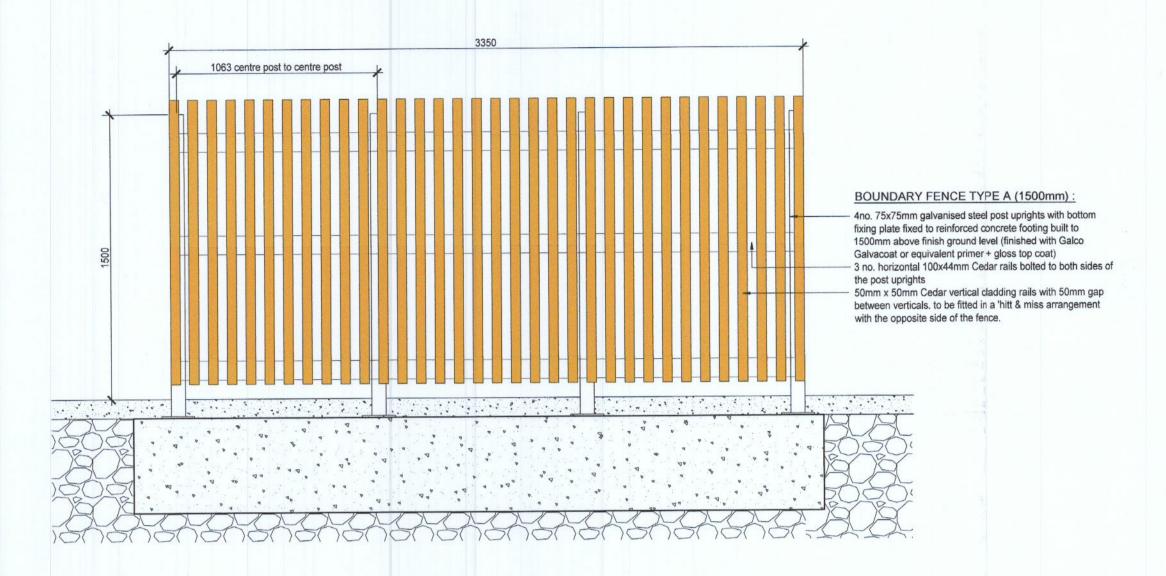

Timber Screen Front Elevation (FENCE TYPE A) Scale 1:20

Stage:

PLANNING

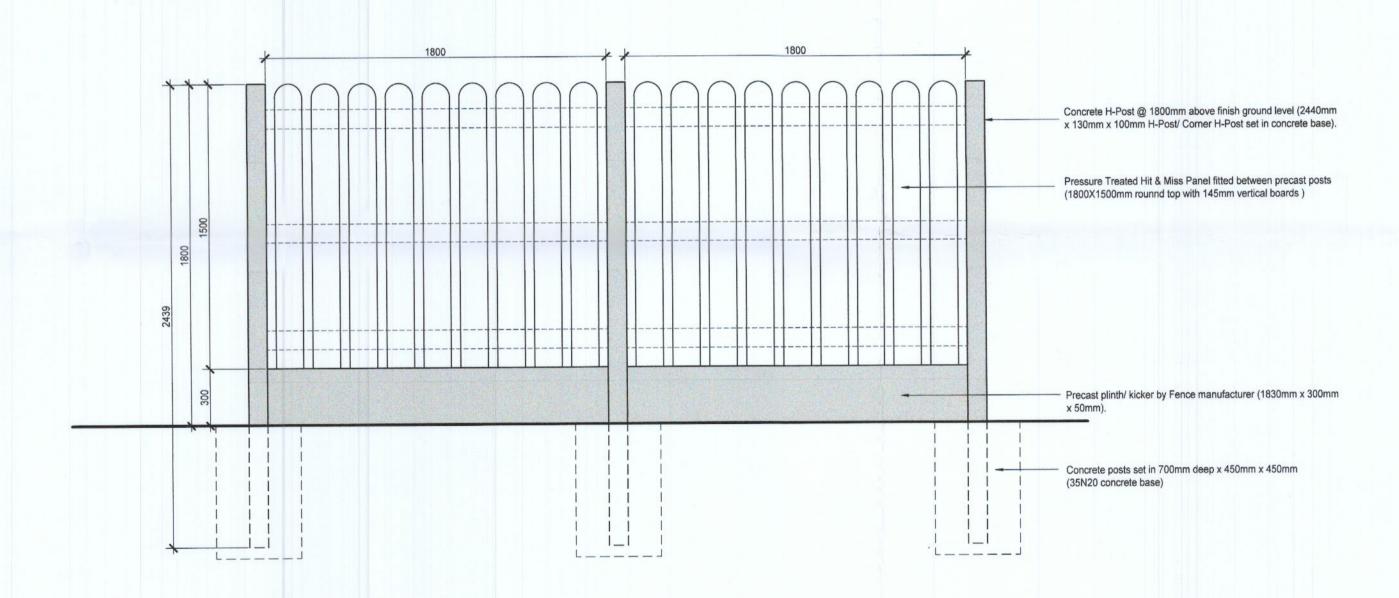

FENCE TYPE B - Concrete Post & Timber Panel Elevation Detail (Rear gardens only) scale 1:20

REVISIONS AFTER LAST PLOT:	REVISIONS AFTER LAST PLOT:

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1:20 @A1 DATE: Sept 2022 PROJECT: DUBLIN SIMON DWG. NO. APARTMENTS AT OLD NANGOR ROAD, RAWN: JB/OM JOB NO. 17016 D-707 CLONDALKIN, DUBLIN 22. K:\17016/T Revision DRAWING: **Boundary Details**

Merchants House,

27-30 Merchants Quay, Dublin 8. Tel: (01) 633 4261. Fax (01) 633 4265

Email: info@walshassociates.ie

ARCHITECTS & PROJECT MANAGERS
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