

## Additional information Planning Reg. Ref. SD22A/0300




Existing Vehicular Access to Existing Dwelling No.5 and No. 7 Photo by CK Architecture. June 2022.



Existing Vehicular Access to Existing Dwelling No.5 and No. 7 Photo by Robert Flanagan. October 2022.



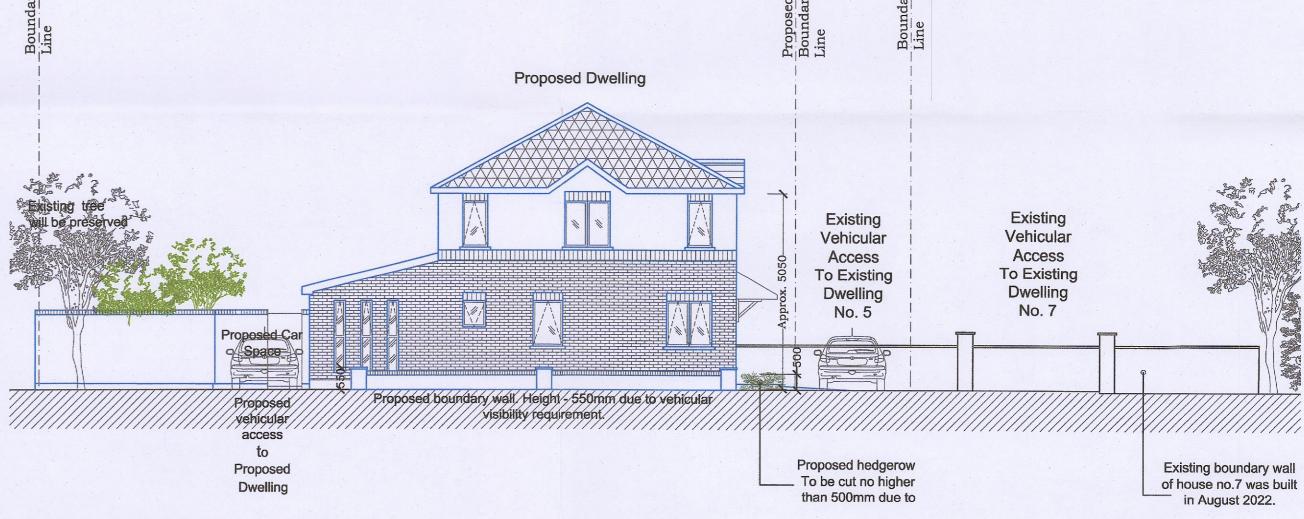

Proposed front elevation with vehicular access
Scale 1:200

This analysis was conducted with Cad Tool Vehicle Turning Simulation (version 1.1.744). (Civil Tools for AutoCAD Applications).

Vehicle Details for tracking Path of Vehicle by DN-GEO-03060, June 2017 (Appendix A: Design Vehicles)

DB32 Private Car
Overall Length: 4.223m
Overall Width: 1.715m
Overall Body Height: 1.392m
Min Body Ground Clearance: 0.233m
Max Track Width: 1.629m
Lock-to-lock time: 4.00s
Curb to Curb Turning Radius: 5.780m

Robert Flanagan

JOB DESCRIPTION:
Proposed 2-story dwelling
5 Kilcarberry CI, Clondalkin, Dublin 22
Additional information
Planning Reg. Ref. SD22A/0300

DRAWING TITLE:
Vehicular Access

DATE: SCALE:
Oct 2022 As Indicated

DRAWN BY: DRAWING REF:

CK-VK
CHECKED BY:

CK Architecture

Design-Planning-Survey-Management

Ashleigh House,

John F Kennedy Rd, Dublin 12

Tel/Fax: 01 6208135 contact@ckarchitecture.ie WWW.CKARCHITECTURE.IE

