


- NOTES**
1. THIS DRAWING IS TO BE READ IN CONJUNCTION WITH ALL RELEVANT ARCHITECTS AND ENGINEER'S DRAWINGS, SPECIFICATIONS AND SCOPE OF WORKS DOCUMENTS. DO NOT SCALE DRAWINGS. USE FIGURED DIMENSIONS ONLY & VERIFY ON SITE. ANY DISCREPANCIES TO BE REPORTED TO THE ARCHITECT / CM TEAM IMMEDIATELY.
 2. ALL DIMENSIONS ARE IN MILLIMETRES.
 3. ALL LEVELS ARE IN METERS.
 4. DRAWING TO BE READ IN CONJUNCTION WITH OTHER PROJECT DISCIPLINE DRAWINGS. COORDINATE ALL ACTIVITIES WITH CONSTRUCTION MANAGEMENT TEAM ON ACTIVITIES REQUIRING OTHER TRADES ATTENDANCE.

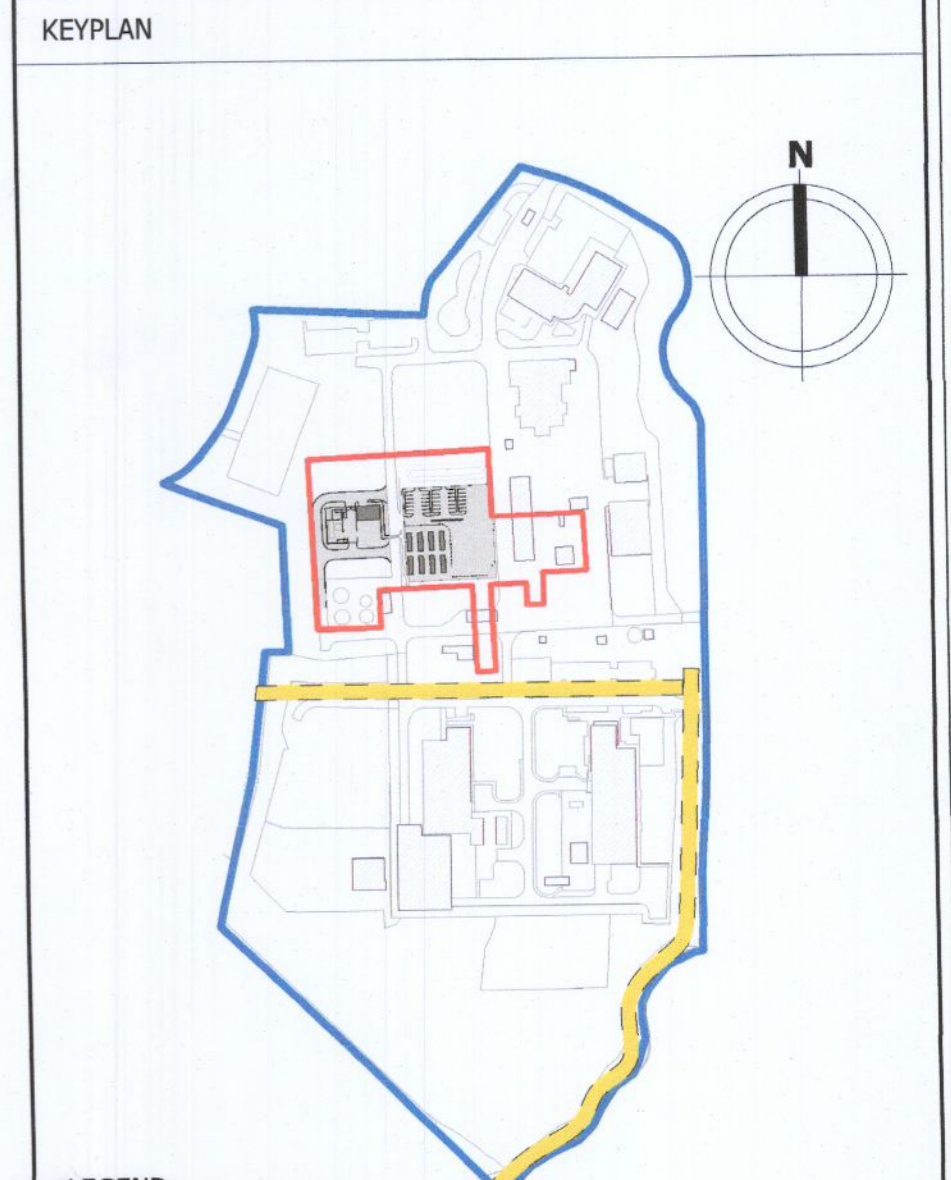

- LEGEND**
- Extent of Proposed Site, Redline Boundary
 - Extent of Site Ownership, Blue Line Boundary
 - ESB Wayleave
 - Existing Trees/Hedgerow
 - Existing Buildings
 - Proposed Building
 - Proposed Trees/Hedgerow
 - Proposed Landscaping
 - Proposed Permeable Asphalt Hardstanding
 - Proposed Compacted Hardcore Hardstanding
 - Existing Compacted Hardcore Hardstanding
 - Proposed VOC Abatement System Compound Plinth (Concrete)

- MATERIALS LEGEND**
1. Composite insulated metal skinned roof panels 1000 mm wide, Colour: Silver Grey
 2. Aluminum pressed metal capping, Colour: Silver Grey
 3. 1100mm high galvanized and painted handrail to ramped personnel access
 4. 2m wide paved footpath
 5. Permeable asphalt access road finished to match existing
 6. 2.4m high Paladin weldmesh fence, RAL 9005 black
 7. Proprietary 2.4m high Paladin weldmesh double security gate.
 8. Sealed concrete plinth
 9. Sealed and painted 350mm high, 200mm wide reinforced concrete bund.
 10. Sealed and painted concrete equipment ramps to bunds
 11. Personnel steel galvanized gate
 12. Compacted stone hardcore finish with geo liner membrane under to match existing
 13. Proposed steel frame painted pipe rack with gravel trench under to match existing

REV	DATE	DESCRIPTION	DRN	DES	CHKD	APPR
E	13 JUL 22	Issued for Planning	JD	AK	AQ	EF
D	30 JUN 22	Issued for Information	JD	AK	AQ	EF
C	02 JUN 22	Issued for Information	JD	AK	AQ	EF
B	01 JUN 22	Issued for Information	JD	AK	AQ	EF
A	30 MAY 22	Issued for Information	JD	AK	AQ	EF

STATUS: **PLANNING**

CLIENT

THIS DRAWING IS THE PROPERTY OF DPS AND SHALL NOT BE USED, REPRODUCED OR DISCLOSED TO ANYONE WITHOUT THE PRIOR WRITTEN PERMISSION OF DPS AND SHALL BE RETURNED UPON REQUEST.

PROJECT TAKEDA VOC ABATEMENT SYSTEM

TITLE PROPOSED DETAIL SITE PLAN

PROJECT No.	A1 Scale	DISCIPLINE	
A21DB035	1:200	Architecture	
CLIENT DRAWING NO.	DRAWING NO.	SHT	REV
N/A	A21DB035-AE-PL-307		E

Proposed site layout
SCALE: 1 : 200