


Contractors must verify all dimensions at the job site before commencing any work. Measurements shown to be scaled. Dimensions to blockwork only. This drawing is copyright. Drawing provided for planning purposes ONLY.

REV.	DATE	BY	DESCRIPTION

**LEGEND**

INDICATES PROPOSED BUILD

INDICATES SITE BOUNDARY

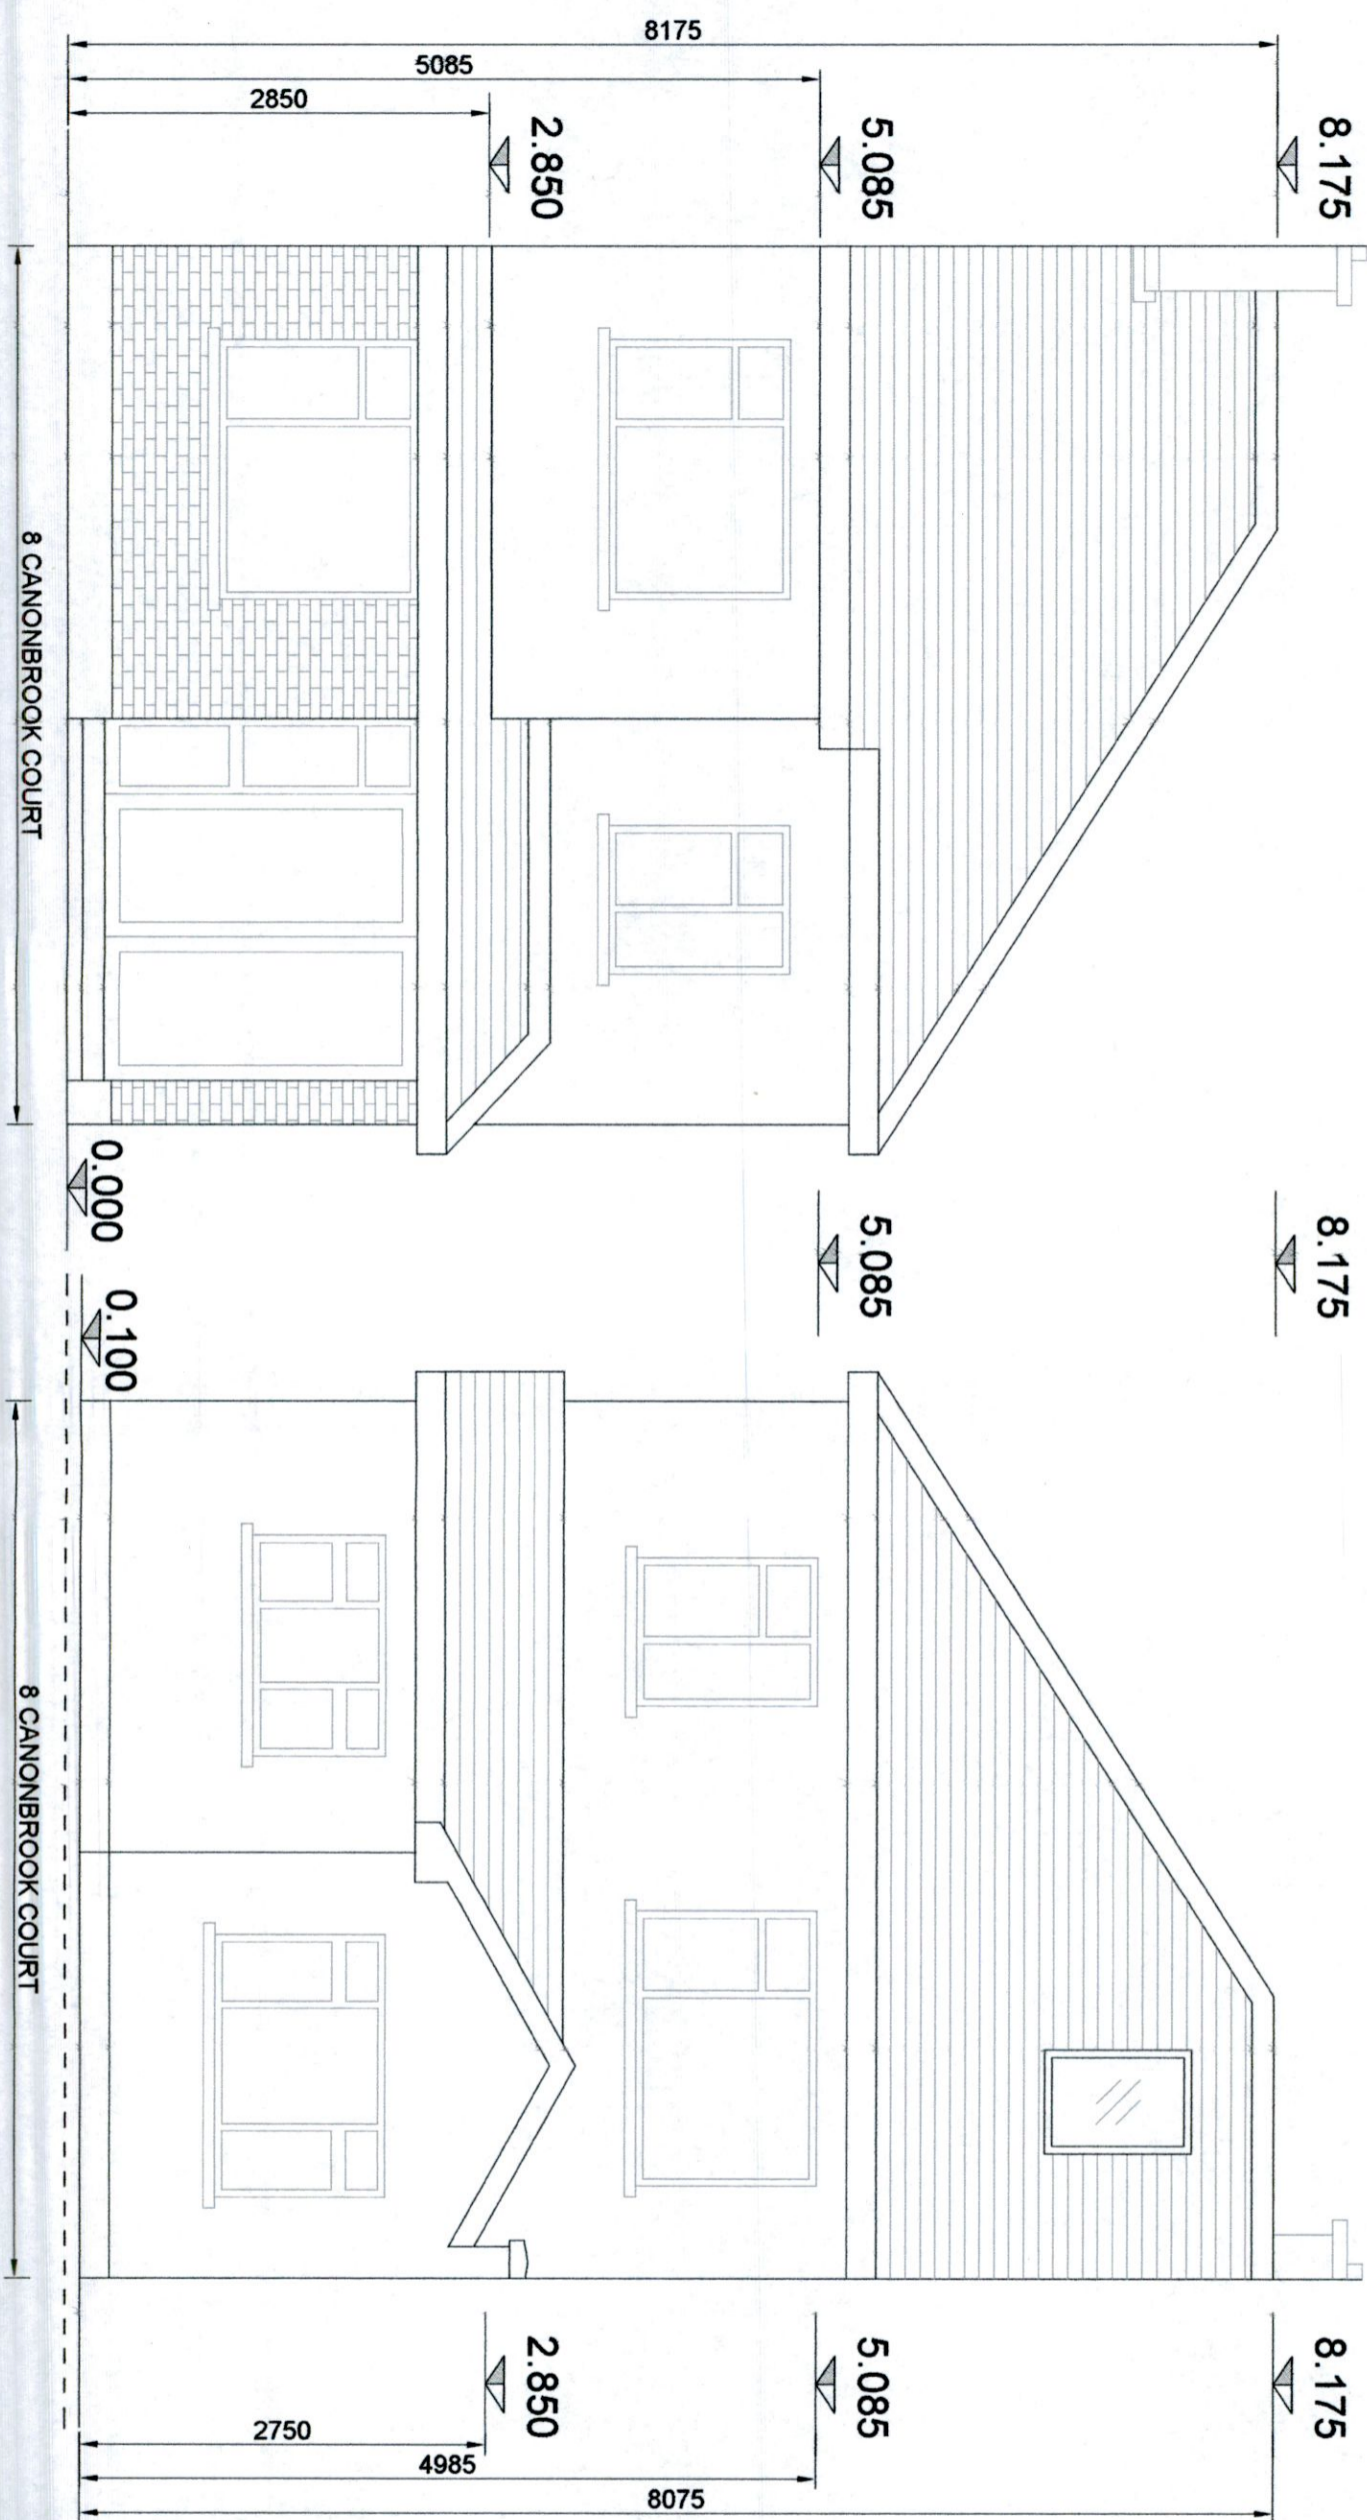

**Existing Front Elevation**

SCALE 1:50

**Existing Rear Elevation**

SCALE 1:50

**PROJECT DETAILS:**  
 CONVERSION OF EXISTING ATTIC SPACE  
 COMPRISING OF A MODIFICATION OF EXISTING  
 ROOF STRUCTURE, RAISING OF EXISTING GABLE  
 WALL TO INCLUDE NEW WINDOW AT ATTIC LEVEL,  
 AND DUTCH HIP ADDING A NEW INTERNAL ACCESS  
 STAIRS AND FLAT DORMER TO REAR.

**CLIENT:**  
 JIMMY SHERIDAN

**PROJECT:**  
 8 CANONBROOK COURT,  
 GLEBE, LUCAN, CO. DUBLIN

**DRAWING TITLE:**  
 EXISTING FRONT AND REAR ELEVATION

ALL BUILDING WORK TO BE CARRIED  
 OUT IN ACCORDANCE WITH ENGINEERS  
 DETAILS AND CURRENT BUILDING REGULATIONS  
 THIS DRAWING ISSUED FOR PLANNING PERMISSION ONLY

**SCALE:**  
 1:50 @A3

**DATE:**  
 28.05.22

**DRAWING NO.:**  
 103

**DRAWN BY:**  
 JL


Contractors must verify all dimensions at the job site before commencing work. Dimensions shown on this drawing are scaled. Dimensions are to be used as a guide only. The drawing is copyright. Drawing provided for planning purposes ONLY.

REV.	DATE	BY	DESCRIPTION

**LEGEND**

 INDICATES PROPOSED BUILD

 INDICATES SITE BOUNDARY

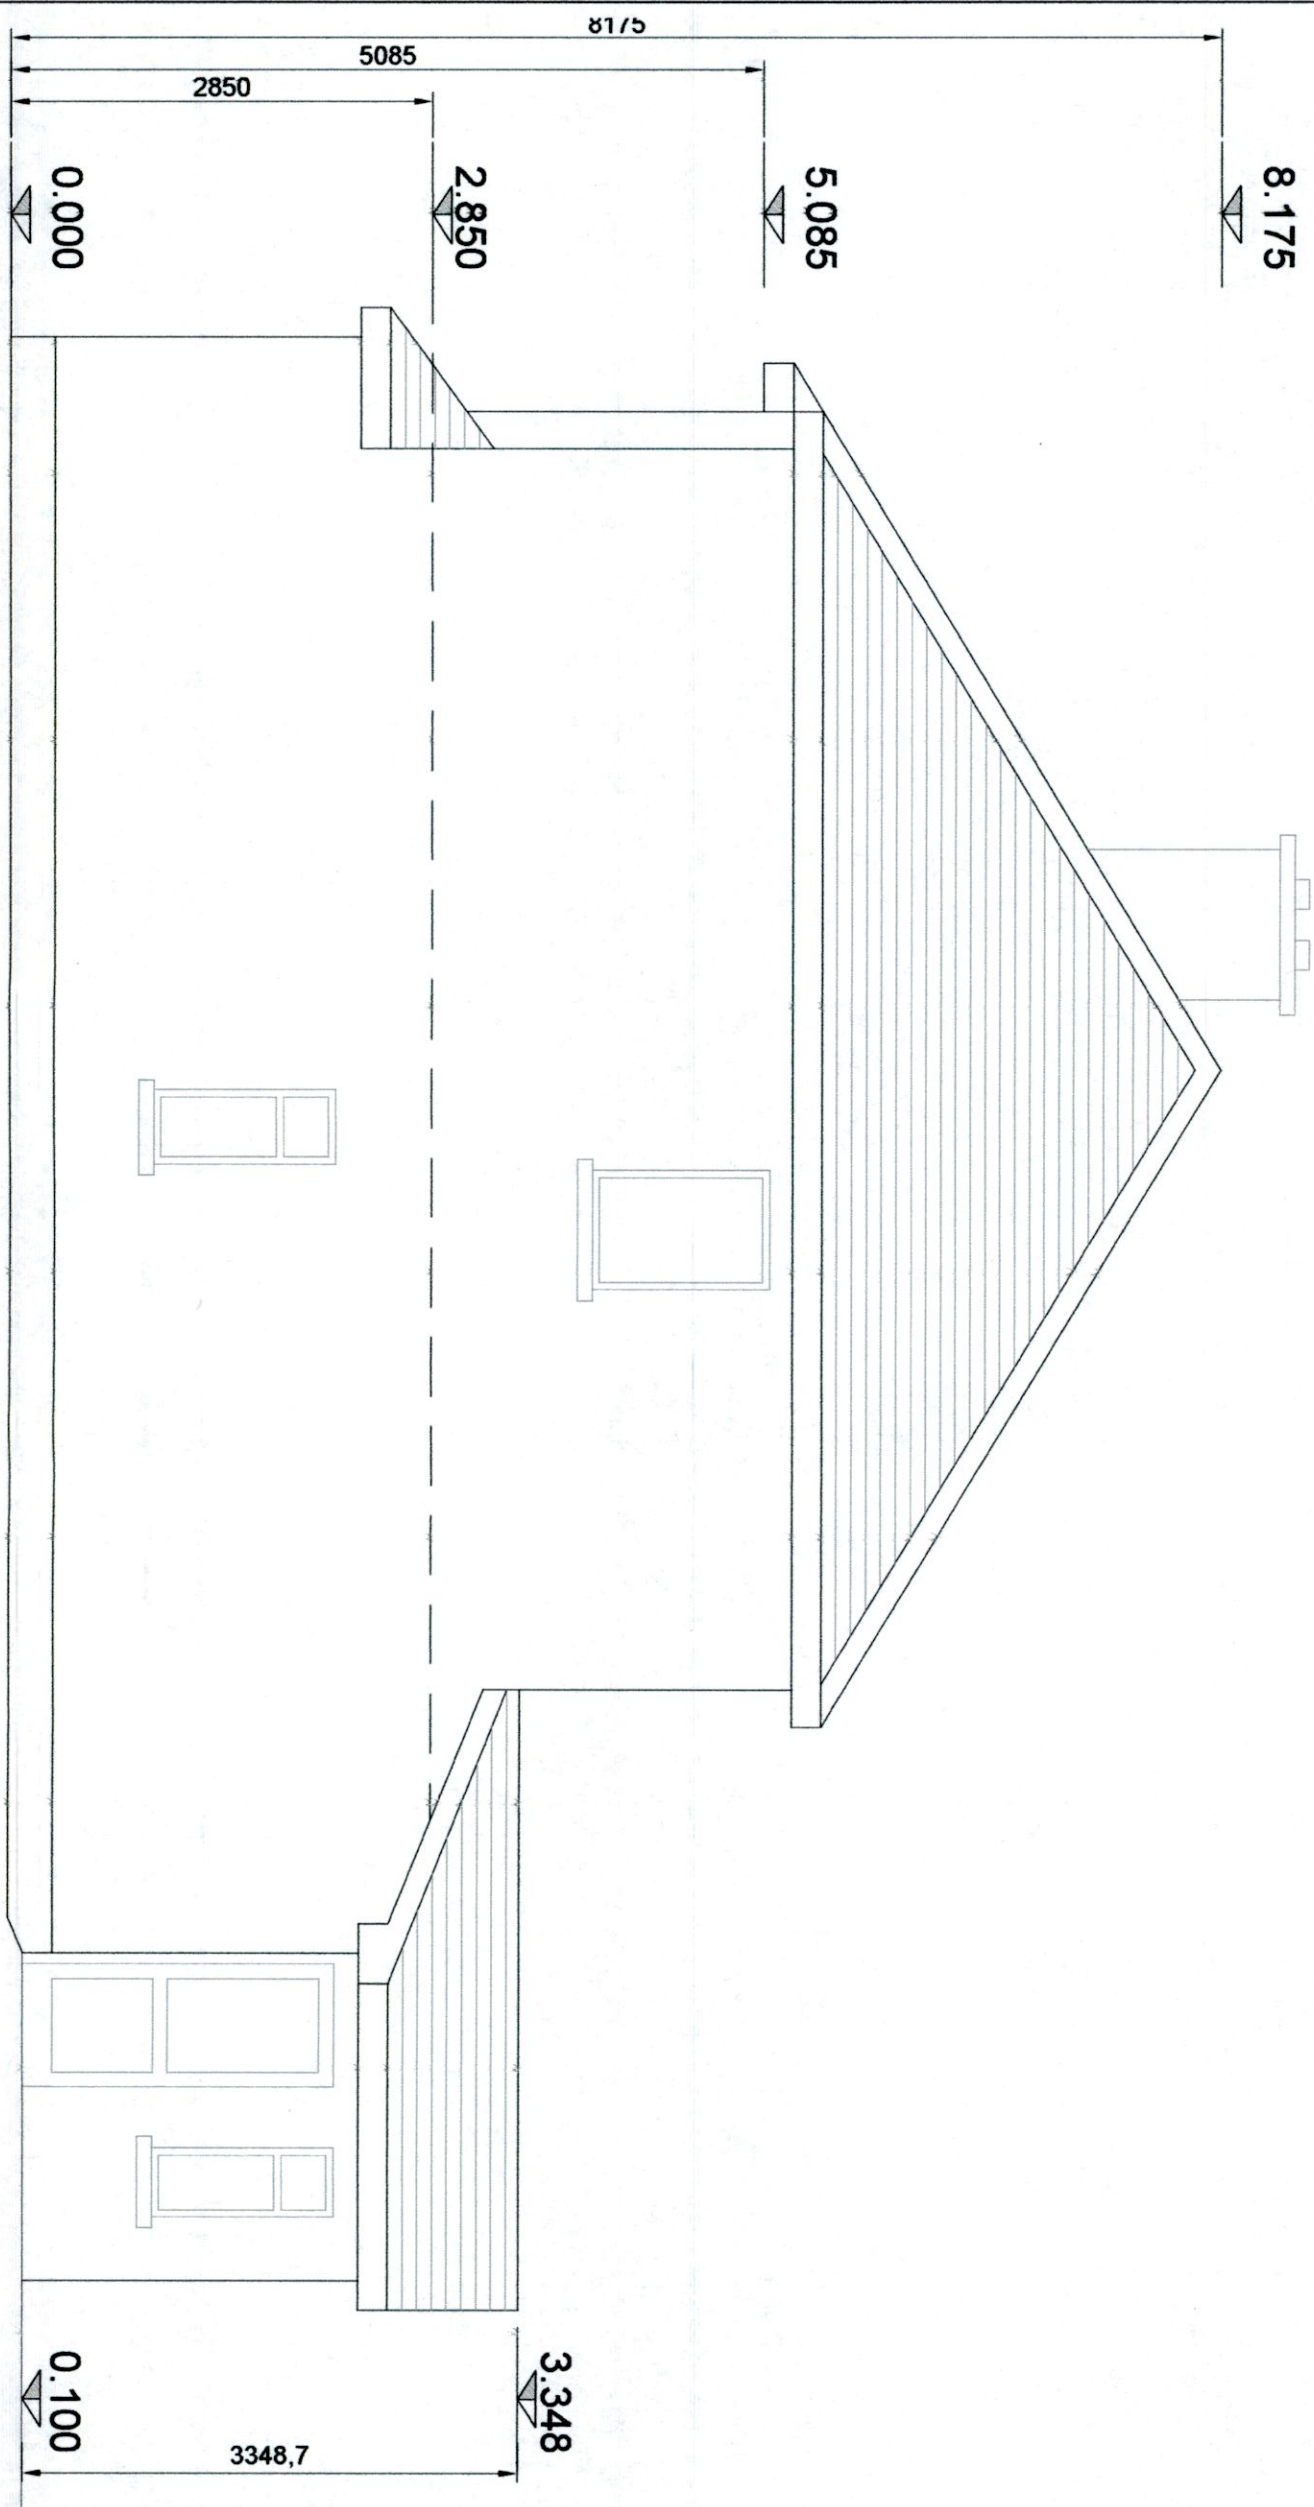

**PROJECT DETAILS:**  
 CONVERSION OF EXISTING ATTIC SPACE  
 COMPRISING OF A MODIFICATION OF EXISTING  
 ROOF STRUCTURE, RAISING OF EXISTING GABLE  
 WALL TO INCLUDE NEW WINDOW AT ATTIC LEVEL,  
 AND DUTCH HIP, ADDING A NEW INTERNAL ACCESS  
 STAIRS AND FLAT DORMER TO REAR.

**CLIENT:**  
 JIMMY SHERIDAN

**PROJECT:**  
 8 CANONBROOK COURT,  
 GLEBE, LUCAN, CO. DUBLIN

**DRAWING TITLE:**  
 EXISTING SIDE ELEVATION

ALL BUILDING WORK TO BE CARRIED  
 OUT IN ACCORDANCE WITH ENGINEERS  
 DETAILS AND CURRENT BUILDING REGULATIONS  
 THIS DRAWING ISSUED FOR PLANNING PERMISSION ONLY

**SCALE:**  
 1:50 @A3

**DATE:**  
 26.05.22

**DRAWING NO.:**  
 104

**DRAWN BY:**  
 JL

# Existing Side Elevation

SCALE 1:50