


Roof Plan SCALE 1:100



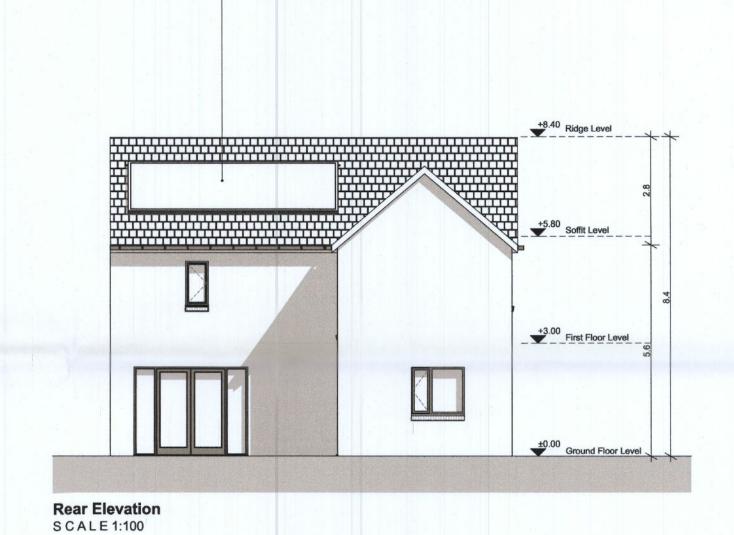

Front Elevation SCALE 1:100


House Type C2 - Gross Internal Area				
Area Type	Proposed Area	DoHPCLG Area Min		
Ground Floor	66.4 m ²			
First Floor	66.4 m ²			
Grand Total	132.8 m ²	110.0 m ²		

House Type C2 - Space Provision & Room Sizes				
Area Type	Proposed Area	DoHPCLG Area Min.		
Aggregate Bedroom Area	44.7 m ²	43.0 m ²		
Aggregate Living Area	48.9 m ²	40.0 m ²		
Main Living Area	19.6 m ²	15.0 m ²		

House Type C2 - Storage Provision				
Area Type	Proposed Area	DoHPCLG Area Min.		
Storage	6.0 m ²	6.0 m ²		

Refer to Site Plan for:	- Finished floor levels to survey datum	
TOOL TO OILO FIGHTON	- Orientation	
	- Handing of type for each unit	

Unit Number: 1, 28, 31, 62, 64, 102.

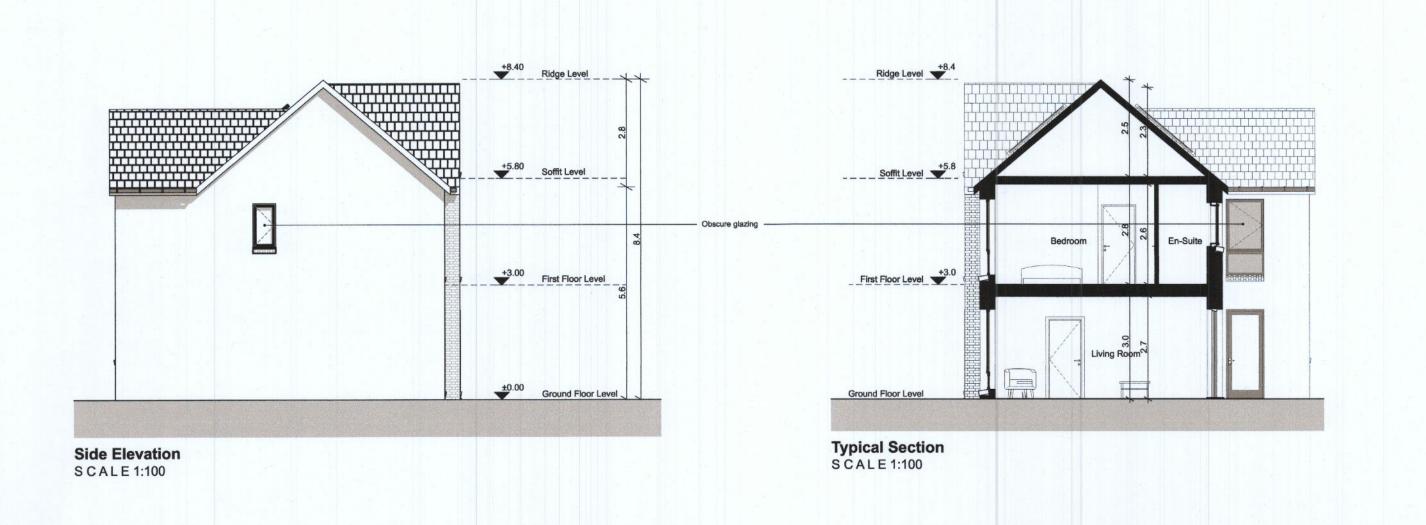

Refer to Architects Site Plan Drawing PL02 for North orientation of each units.

Levels on Housetype drwaings are given relative to 0.00 FFL of the unit type. Refer to Architects Site Plan Drawing PL02 for specific FFLs of each unit relative to Malin Head datum level.

Do not scale from this drawing.

Use figured dimensions only.

WINDOWS.

All errors and omissions to be reported to the Architect.

This drawing is to be read in conjunction with relevant consultant's drawings.

This drawing is for planning purposes only and not for construction.

This drawing or design may not be reproduced without permission.

NOTES ON FINISHES: ROOF: TO BE FINISHED IN SLATE OR CONCRETE ROOF TILES IN SELECTED COLOUR OR SIMILAR APPROVED WALLS: SELECTED CLAY BRICKWORK WHERE INDICATED

OTHERWISE SELECTED SELF-COLOURED RENDER JOINERY: ALL WINDOWS AND DOORS, FRAMES AND LEAFS TO BE

> ALUMINIUM POWDER COATED TO APPROVED COLOUR OR UPVC OR PAINTED TIMBER TO APPROVED COLOUR. OBSCURE GLAZING WHERE INDICATED TO SENSITIVE

SOLAR PANELS MAY BE OMITTED IN FAVOUR OF ALTERNATIVE RENEWABLE ENERGY OPTIONS.

RAINWATER GOODS: GUTTERS, DOWNPIPES AND FIXINGS TO BE uPVC OR ALUMINIUM POWDER COATED TO SELECTED COLOUR TO MATCH ROOF SLATES.

SOLAR PANELS: INDICATIVE SOLAR PANEL POSITION, FINAL SOLAR PANEL POSITION DEPENDS ON HOUSE ORIENTATION. THE SOLAR PANELS INDICATED ARE A PROVISIONAL OPTION TO SATISFY RENEWABLE ENERGY REQUIREMENTS OF BUILDING REGULATIONS PART L.



Planning Application

DAVEY + SMITH ARCHITECTS

DAVEY+SMITH ARCHITECTS I 13 SEAPOINT BUILDING, 44/45 CLONTARF ROAD, CLONTARF, DUBLIN 3 I PH: 01 2447638 I EMAIL: info@davey-smith.com I WEB: www.davey-smith.com Layout ID: PH 006 - House Type C2 - Wide Front Semi-Detached

Drawing Name: Proposed Plans, Section and Elevations