



SCALE 1:100

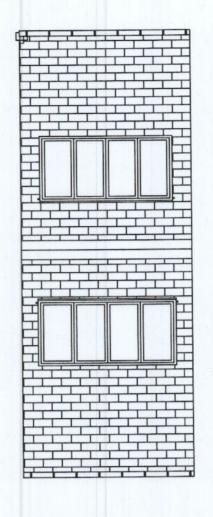

Roof Plan SCALE 1:100

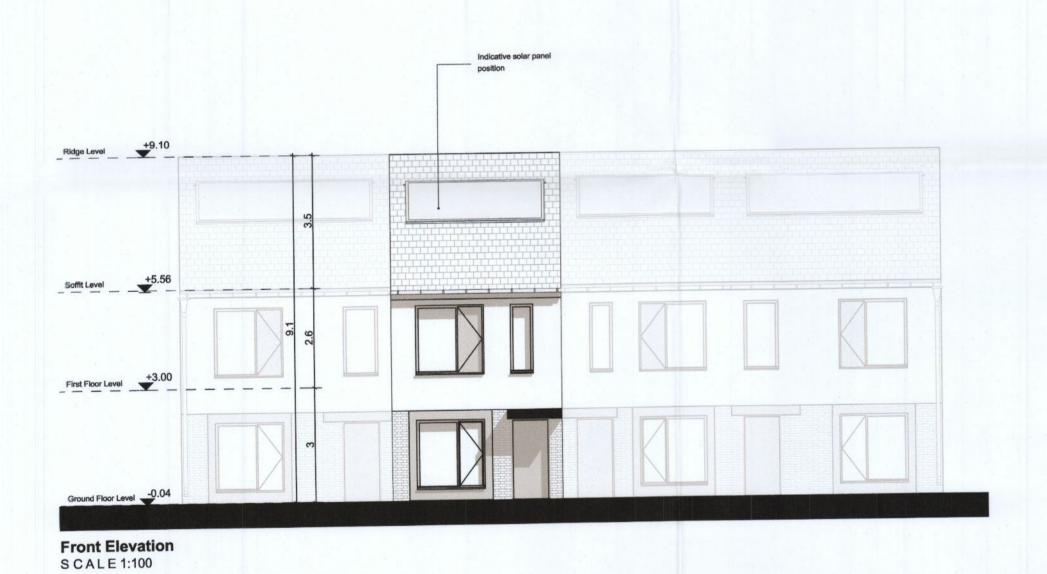


House Type B - Gross Internal Area				
Area Type	Proposed Area	DoHPCLG Area Min.		
Ground Floor	43.1 m ²			
First Floor	43.1 m ²			
Grand Total	86.2 m ²	73.0 m ²		

House Type B - Space Provision & Room Sizes				
Area Type	Proposed Area	DoHPCLG Area Min.		
Aggregate Bedroom Area	25.8 m ²	25.0 m ²		
Aggregate Living Area	34.2 m ²	30.0 m ²		
Main Living Area	19.2 m ²	13.0 m ²		


House Type B - Storage Provision			
Area Type	Proposed Area	DoHPCLG Area Min.	
Storage	4.0 m ²	4.0 m ²	

Refer to Site Plan for: - Finished floor levels to survey datum OrientationHanding of type for each unit

Unit Number: 8, 10, 13, 14, 21, 22, 43, 47, 48, 49, 50, 81, 82, 83, 86, 87, 88, 219, 220.

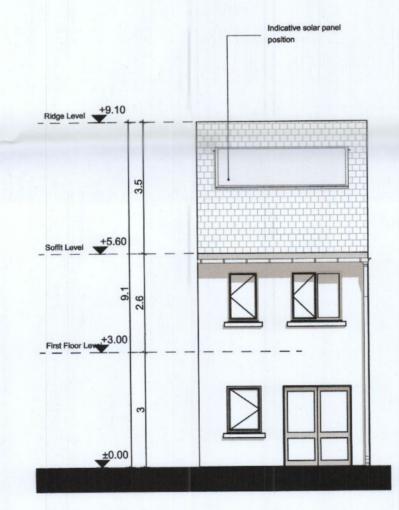

Rear Elevation S C A L E 1:100

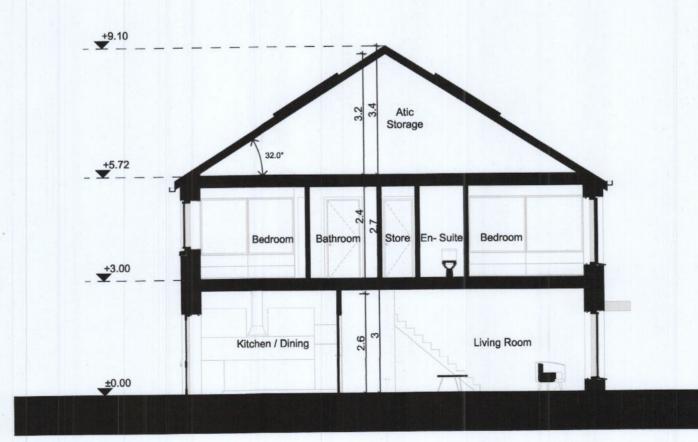

Typical Section SCALE 1:100

Notes

Do not scale from this drawing. Use figured dimensions only.

All errors and omissions to be reported to the Architect.

This drawing is to be read in conjunction with relevant consultant's drawings. All dimensions are in millimetres and all levels are in meters to match Datums unless otherwise noted.

This drawing is for planning purposes only and not for construction. This drawing or design may not be reproduced without permission.

NOTES ON FINISHES:

ROOF:

TO BE FINISHED IN SLATE OR CONCRETE ROOF TILES IN SELECTED COLOUR OR SIMILAR APPROVED

WALLS:

SELECTED CLAY BRICKWORK WHERE INDICATED OTHERWISE SELECTED SELF-COLOURED RENDER

JOINERY:

ALL WINDOWS AND DOORS, FRAMES AND LEAFS TO BE ALUMINIUM POWDER COATED TO APPROVED COLOUR OR UPVC OR PAINTED TIMBER TO APPROVED COLOUR.

OBSCURE GLAZING WHERE INDICATED TO SENSITIVE WINDOWS.

RAINWATER GOODS: GUTTERS, DOWNPIPES AND FIXINGS TO BE uPVC OR ALUMINIUM POWDER COATED TO SELECTED COLOUR TO MATCH ROOF SLATES.

SOLAR PANELS:

INDICATIVE SOLAR PANEL POSITION, FINAL SOLAR PANEL POSITION DEPENDS ON HOUSE ORIENTATION. THE SOLAR PANELS INDICATED ARE A PROVISIONAL OPTION TO SATISFY RENEWABLE ENERGY REQUIREMENTS OF BUILDING REGULATIONS PART L. SOLAR PANELS MAY BE OMITTED IN FAVOUR OF ALTERNATIVE RENEWABLE ENERGY OPTIONS.



Planning Drawings

DAVEY + SMITH ARCHITECTS

DAVEY + SMITH ARCHITECTS Unit 13,THE SEAPOINT BUILDING, 44-45 CLONTARF ROAD, CLONTARF, DUBLIN 3 | PH: 01 2447638 | EMAIL: info@davey-smith.com | WEB: www>davey-smith.com

Layout ID: PH 004 - House type B 2B Mid Terrace Job No: 2004

Project: Clonburris, K1 Drawing Name: Proposed Plans, Section and Elevations Date: 29/06/2022