

Drawing Number: 586/PD/03

Scale: 1:100

Roof

S.M. M. N.

stainless steel at 750mm c.c. horizontally

and 450mm c.c. vertically

WATSON FITZPATRICK & ASSOCIATES Planning & Design Consultants 98 Woodlawn Park Grove Firhouse, Dublin 24.


felt on prefabricated roof trusses at 600mm centres to I.S. 193: 1986, complete with bracing, water storage tank supports and holding down clips, all to manufacturers instructions. Coloured concrete roof tiles laid to manufacturers instructions on 35mmx 50mm battens on sarking

> Note: All structural timbers to comply with SR11, structural

and supplied at a moisture content not exceeding 22^. timber for domestic construction. Timber to be kiln dried

felt on prefabricated roof trusses at 600mm centres to LS 193: 1986, complete with briefing, water storage tunk supports and holding down clips, all to manufacturers instructions Roof.

Coloured concrete roof tiles laid to manufacturers instructions on 35mmx 50mm battens on sarking

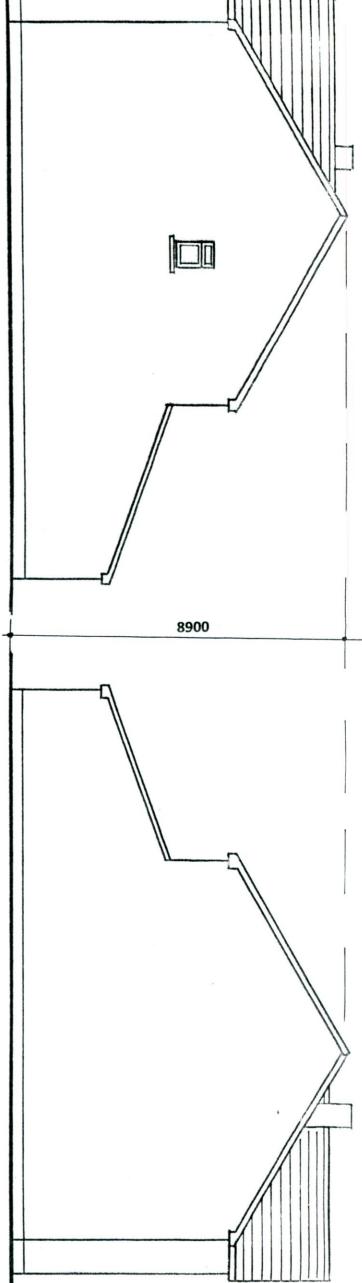

SIDE ELEVATION

Floor Joists

44mm x 175mm SCA floor joists at 400mm centres with 1 no row of bridging at centre span. Double row under stud partitions in same direction.

pack and nog off walls metal straps 5mmx30mm over 3 joists at 2000mm centres loists at all party walls to be hung on metal shoes. Galvanised 75mmx175mm SCA trimmers to firebreast and opes

Balusters - 840mm vertically over pitch line and 900mm over landing, not greater than 100mm between balusters. Headroom 2000mm vertically: Stairs: 2R+G to be between 550mm and 700mm, minimum clear width 800mm.

Pipe Bedding 10.0 N/mm2.
Blinding 10.0 N/mm2.
Strip Foundation 15.0 N/mm2.
Ground Floor 20.0 N/mm2. Concrete Mixes: 7.5 N/mm2

Lintols:

Paths 25.0 N/mm2

pressed metal lintols incorporating insulation, 225mm. bearing each end. Precast concrete composite lintol and

150mm thick power floated concrete slab on 50mm thick polystyrene insulation, 25mm at external edges on 1000 gauge Visqueen damp proof membrane on sand blinding on 150mm minimum well consolidated hard-core filling.

felt on prefabricated not trusses at 600mm centres to I.S. 193: 1986, complete with bracing, water storage tank supports and holding down clips, all to manufacturers instructions. instructions on 35mmx 50mm battens on sarking Coloured concrete roof tiles laid to manufacturers

External Walls

To consist of 215mm solid block inner leaf with 100mm cavity 50mm insulation and 100mm block outer leaf with 19mm external render and 13mm lightweight internal plaster

Ventilation:

other rooms 1/20 of floor area Room vents - 6500sq.mm.
Roof - 25mm continuous strip or equal.
Window opes Kitchen 1/10 of floor area,


Insulation:

Maximum Elemental IUI Values. Exposed Roofs - 0.25 W/M2 K. Exposed Walls - 0.45 W/M2 K Exposed Floors - 0.45 W/M2 K.



8900

FRONT ELEVATION

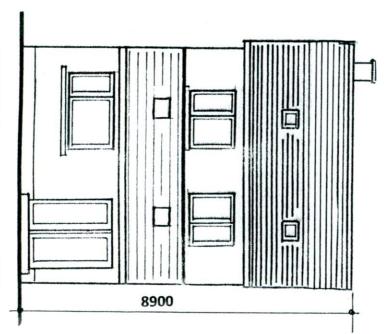

REAR ELEVATION

Floor on 1000 gauge Visqueen damp proof membrane on sand blinding on 150mm minimum well consolidated hard-core filling. thick polystyrene insulation, 25mm at external edges 150mm thick power floated concrete slab on 50mm.

PROPOSED TWO STOREY FOUR BEDROOM DETACHED HOUSE TO SIDE OF 29 BALLYROAN HEIGHTS, RATHFARNHAM, DUBLIN 16 FOR J. McDONAGH.

98 Woodlawn Park Grove Planning & Design Consultants Firhouse, Dublin 24. WATSON FITZPATRICK & ASSOCIATES