


- GENERAL NOTES:**
1. THIS DRAWING IS TO BE READ IN CONJUNCTION WITH ALL RELEVANT ARCHITECTS & ENGINEERS DRAWINGS, SPECIFICATIONS, ETC..
 2. DO NOT SCALE, USE FIGURED DIMENSIONS ONLY (WHERE APPLICABLE)
 3. ANY DISCREPANCIES / DEVIATIONS ENCOUNTERED TO BE REPORTED TO THE ENGINEER IMMEDIATELY (IN WRITING).
 4. FOR ALL SETTING OUT DIMENSIONS REFER TO ARCHITECTS DRAWINGS.

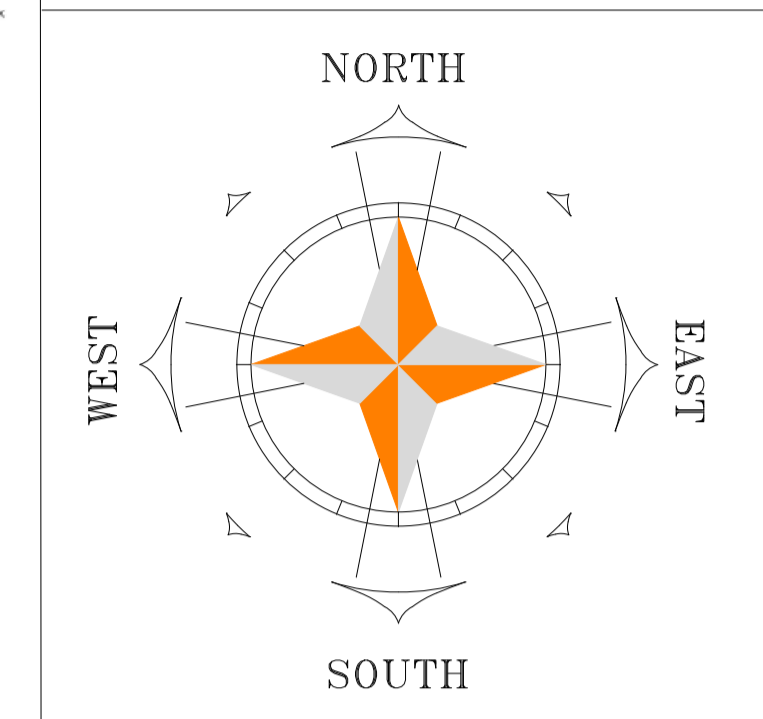

- LEGEND:**
- PROPOSED ROOF OUTLETS
 - PROPOSED DOWN PIPES
 - PROPOSED SURFACE WATER DRAINAGE
 - PROPOSED BLUE ROOF
 - PROPOSE AJ
 - EXISTING SURFACE WATER DRAINAGE
 - PERMEABLE PAVING

NOTES:
FOR COURTYARD DRAINAGE SEE DRAWING 603

*** DO NOT SCALE USE FIGURED DIMENSIONS ONLY ***

P6	PF	LAYOUT REVISED	13-05-2022
P5	PF	LAYOUT REVISED	26-04-2022
P3	P.F	LAYOUT REVISED	20-04-2022
REV:	BY:	AMENDMENTS:	DATE:

DRAWN BY:	PF	TECH. CHECK:	PF
SCALE:	1:200	SIZE:	A1
DATE:	08/01/2021	APPROVED:	AF


FOR COMMENT

CLIENT: GEENHILLS LIVING
C/O BELVEDERE LIVING LTD

JOB TITLE: BANCROFT VIEW SHD


DRAWING TITLE: PROPOSED ROOF DRAINAGE LAYOUT

JOB No:	DRAWING No:	REV:
20_4993	602	P6

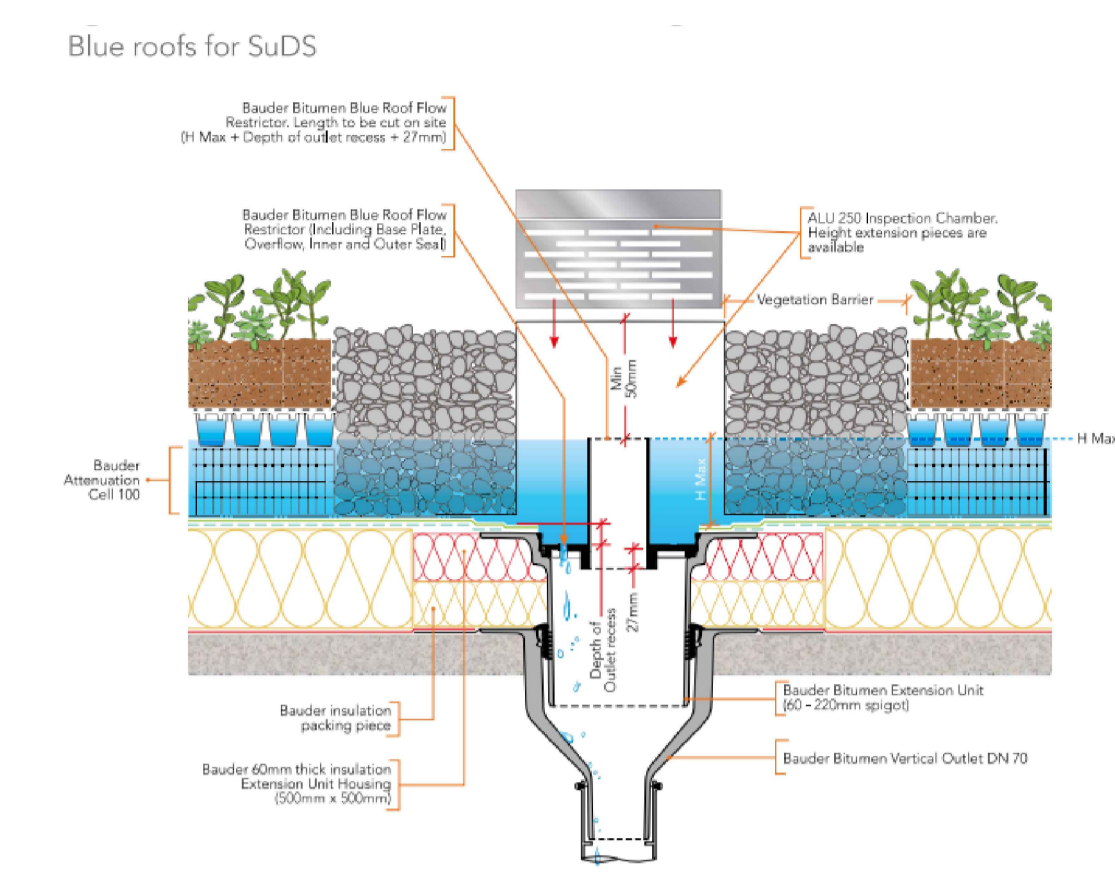

BLUE ROOF CONSTRUCTION - OUTLET
SCALE NTS

NOTES:
FOR RAINWATER DOWNPIPE FROM COURTYARD SEE DRAWING 603

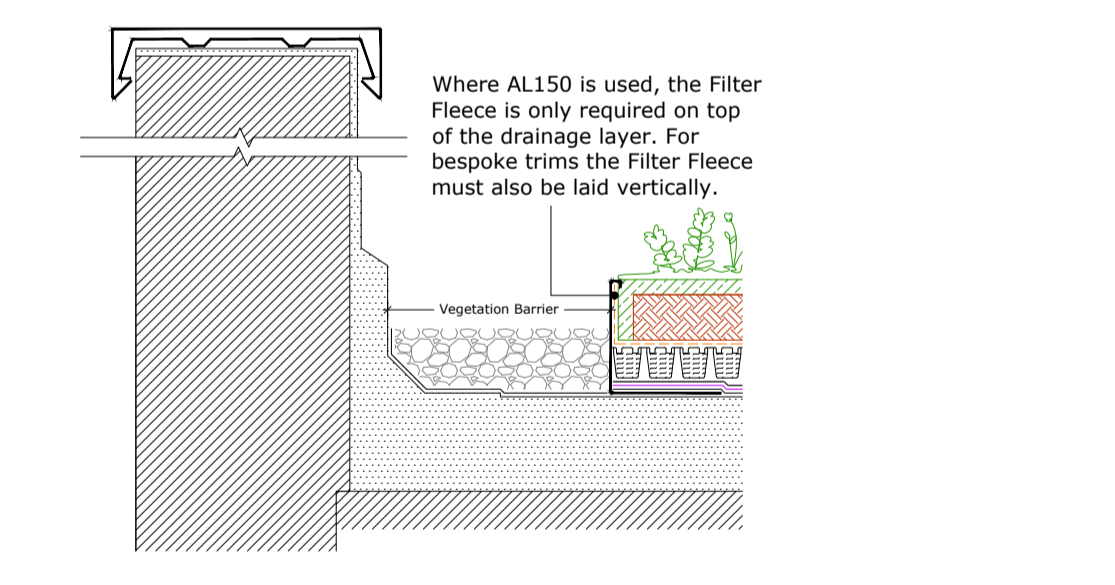

UPSTAND TO PARAPET
SCALE 1:10

PROPOSED ROOF DRAINAGE LAYOUT
SCALE 1:200



MANHOLE BLOCKED O
PROPOSED LOCATION OF NEW SADDLE CONNECTION TO EXISTING SURFACE WATER DRAINAGE