


SURFACE WATER MH	Invert Level
S1	85.90
S2	85.76
S3	85.50
S4	85.40
S5	85.10
S6	86.18
S7	85.92
S8	85.84
S9	85.64
S10	85.56
S10.1	85.81
S11	85.36
S12	85.00
S13	84.68


**PROPOSED GROUND FLOOR SURFACE WATER DRAINAGE LAYOUT**  
SCALE 1:200

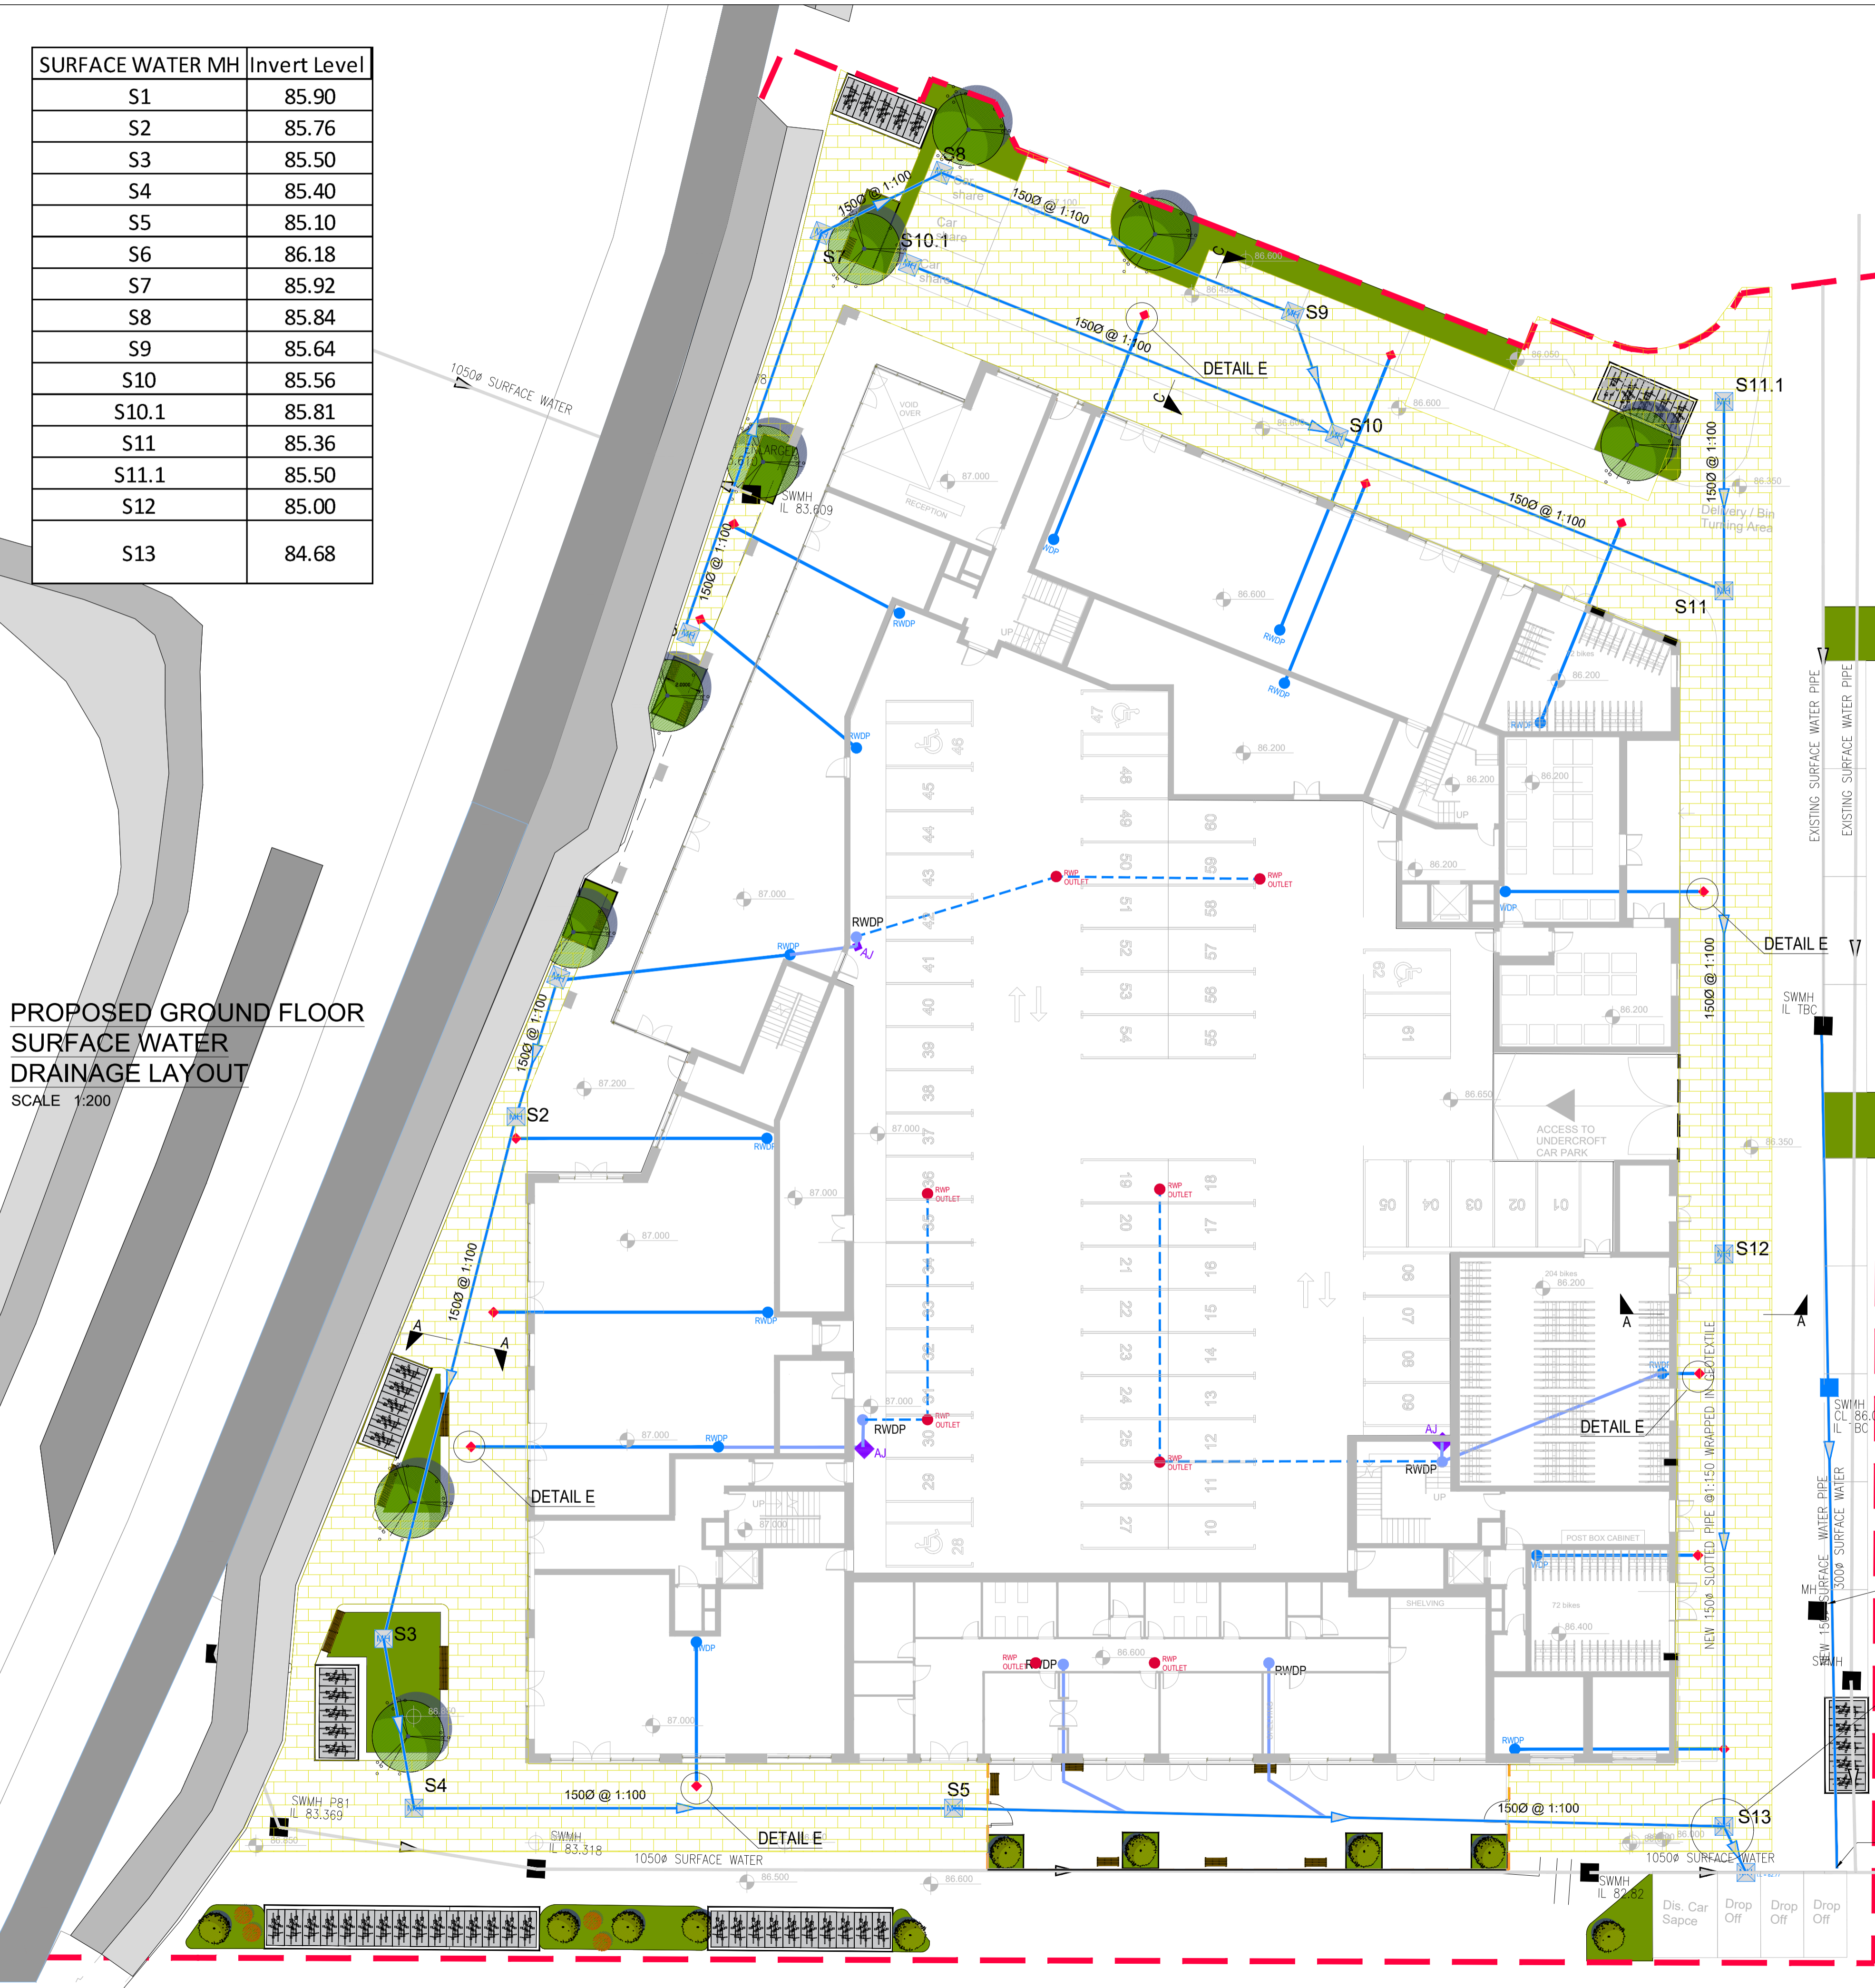




**LEGEND:**

- RAINWATER DOWNPIPE FROM ROOF
- PROPOSED SURFACE WATER DRAINAGE PIPE
- PROPOSED SURFACE WATER MANHOLE
- PERMEABLE PAVING
- EXISTING SURFACE WATER DRAINAGE MANHOLE
- EXISTING SURFACE WATER DRAINAGE PIPE
- DRAINAGE OUTLET UNDERSIDE OF CARPARK CEILING
- DRAINAGE DISTRIBUTION B BOX
- DRAINAGE PIPE UNDERSIDE OF CARPARK CEILING
- ACCESS CHAMBER

- GENERAL NOTES:**
- THIS DRAWING IS TO BE READ IN CONJUNCTION WITH ALL RELEVANT ARCHITECTS & ENGINEERS DRAWINGS, SPECIFICATIONS, ETC...
  - DO NOT SCALE, USE FIGURED DIMENSIONS ONLY (WHERE APPLICABLE)
  - ANY DISCREPANCIES / DEVIATIONS ENCOUNTERED TO BE REPORTED TO THE ENGINEER IMMEDIATELY (IN WRITING).
  - FOR ALL SETTING OUT DIMENSIONS REFER TO ARCHITECTS DRAWINGS.

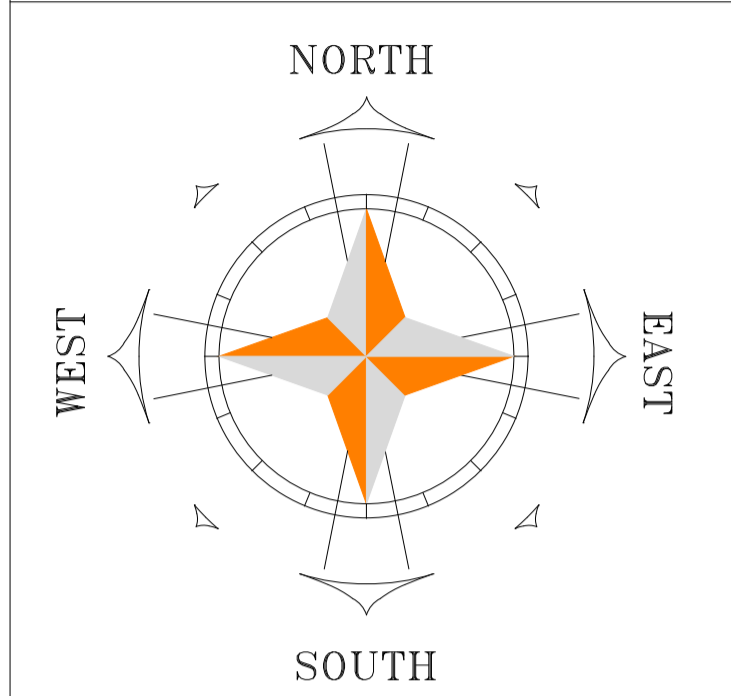

**NOTES:**  
FOR RAINWATER DOWNPIPE FROM COURTYARD SEE DRAWING 603

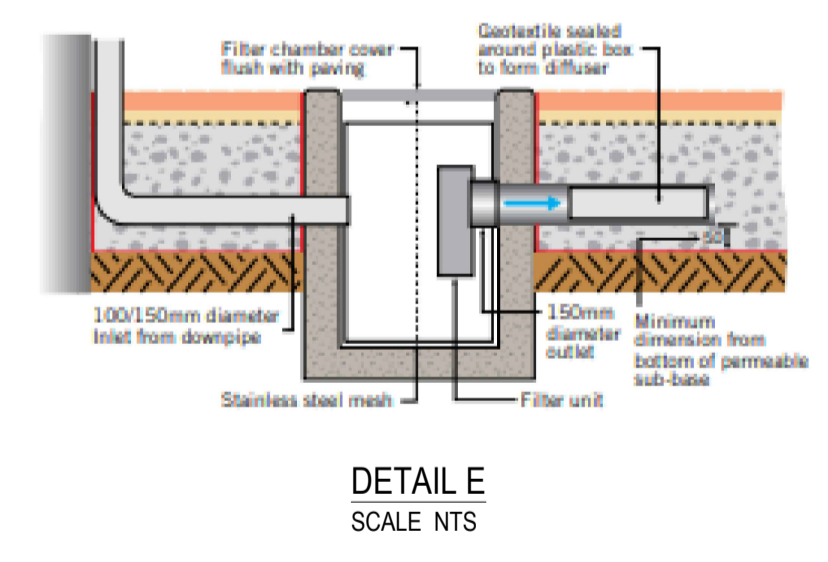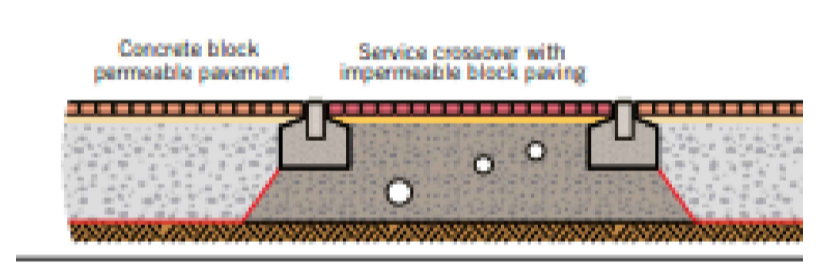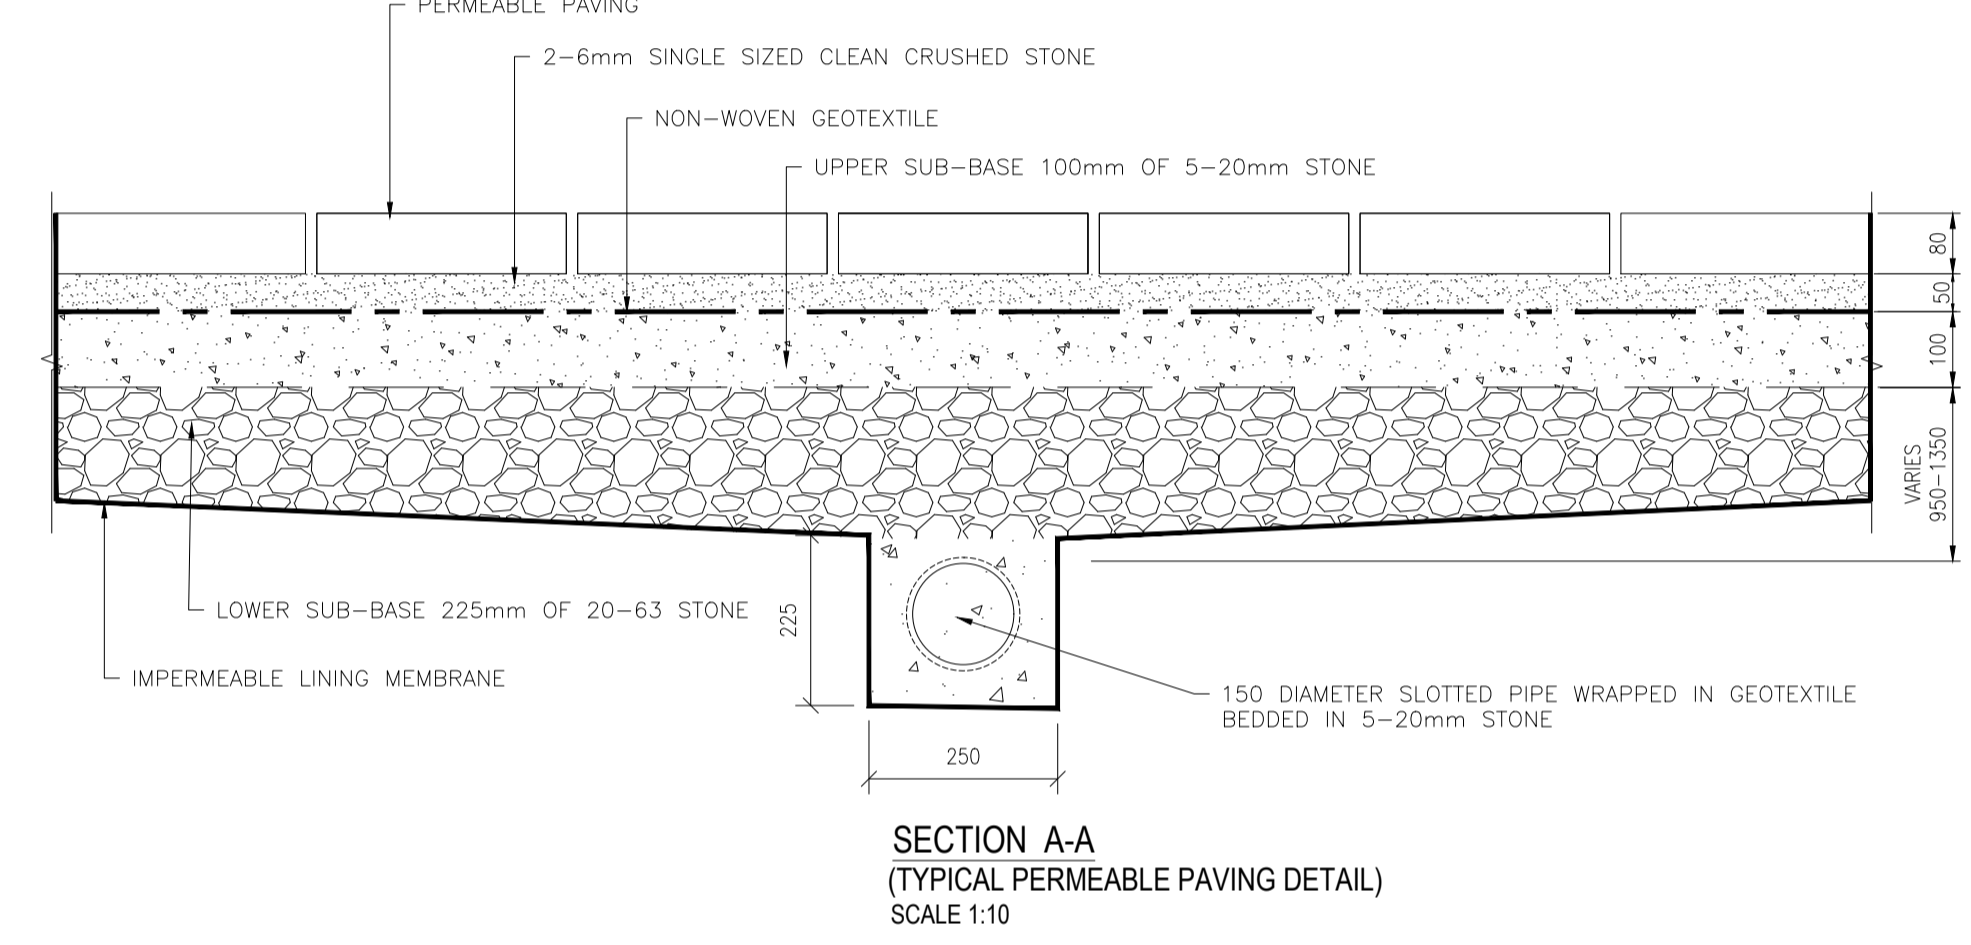

S13 MANHOLE FITTED WITH HYDROBREAK (2 L / SEC)

\*\*\* DO NOT SCALE USE FIGURED DIMENSIONS ONLY \*\*\*

REV	BY	AMENDMENTS	DATE
P6	PF	LAYOUT REVISED	13-05-2022
P5	PF	LAYOUT REVISED	26-04-2022
P2	PM	FOR COMMENT	15/01/2021

DRAWN BY:	PM	TECH. CHECK:	PM
SCALE:	1:200	SIZE:	A1
DATE:	08/01/2021	APPROVED:	AF

**FOR PLANNING**

CLIENT: GEENHILLS LIVING  
C/O BELVEDERE LIVING LTD

JOB TITLE: BANCROFT VIEW SHD

DRAWING TITLE: PROPOSED GROUND FLOOR SURFACE WATER DRAINAGE LAYOUT

**Fitzsimons Doyle & Associates**  
250 Harold's Cross Road, Dublin 6w  
Tel: +353 (0) 4966011 Fax: +353 (0) 4967018  
Web: www.fdaconsulting.ie Email: admin@fdaconsulting.ie