


MINIMUM MANHOLE DIAMETERS				
DIAMETER OF LARGEST PIPE IN MANHOLE (mm)	INTERNAL DIAMETER OF MANHOLE (mm)			
LESS THAN 375	1200			
375 TO 450	1350			
500 TO 750	1500			

PRE-CAST CONCRETE MANHOLE

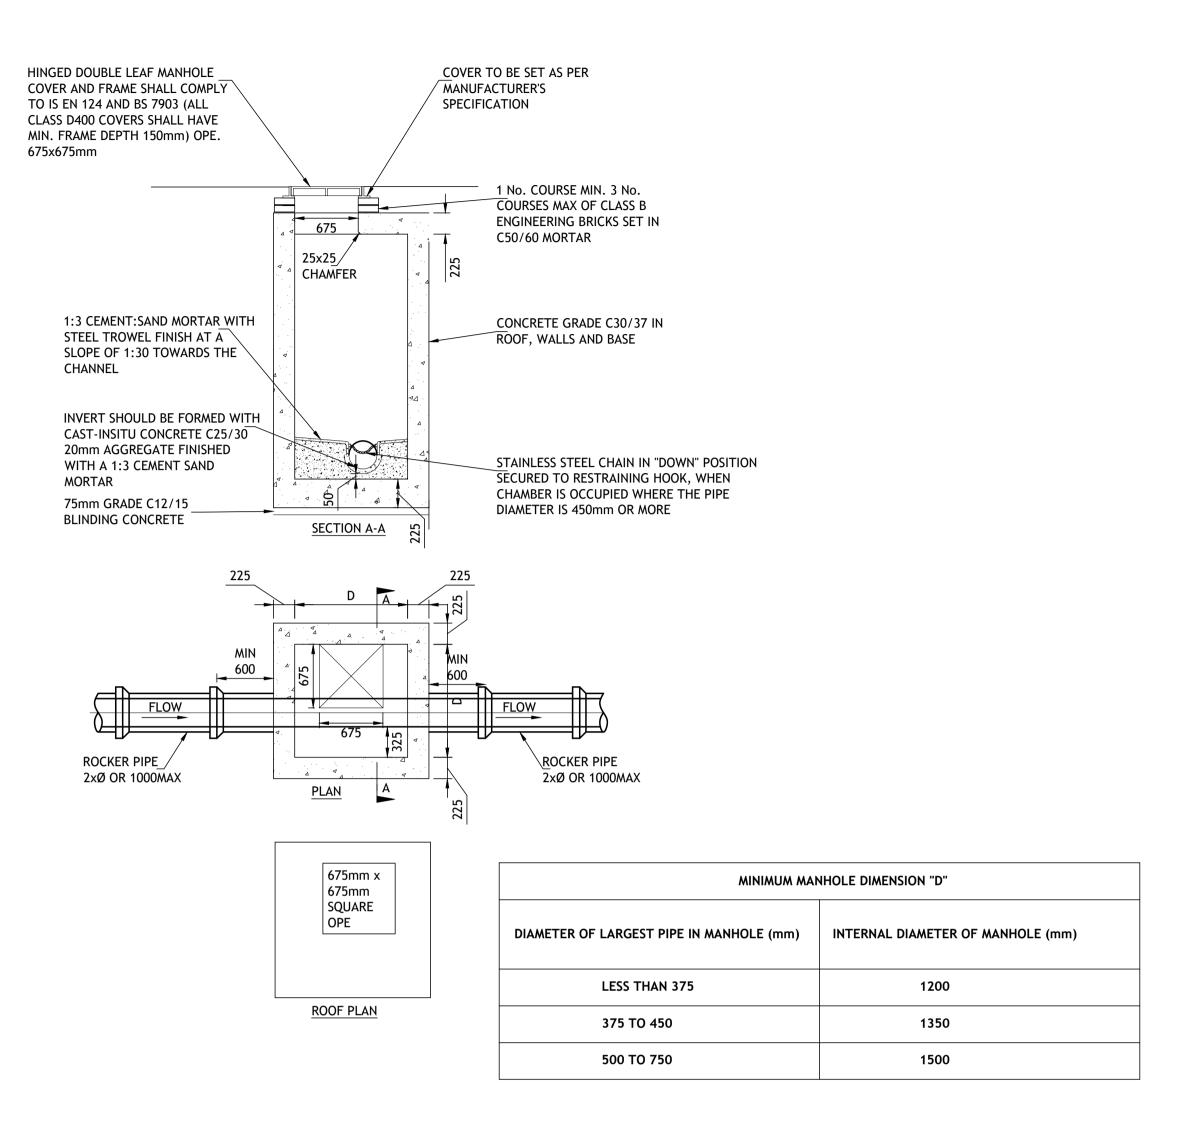

IN-SITU CONCRETE MANHOLE

NT

- ALL DIMENSIONS ARE IN MILLIMETRES (mm) UNLESS NOTED OTHERWISE.
 PRE-CAST MANHOLES UNITS: COMPLYING WITH REQUIREMENTS OF IS EN
- 1917 AND BS 5911-PART 3.
 THICKER MANHOLE BASES REQUIRED FOR SEWERS IN EXCESS OF 3m DEEP WHERE THE SIZE IS GREATER THAN THE STANDARD MINIMUM SIZE.
- CHANNELS, BENCHING ETC. SUBJECT TO IRISH WATER APPROVAL AND COMPLYING WITH BS 5911-PART 4 2002.

 5. STRUCTURAL DESIGN AND REINFORCEMENT DETAILS TO BE PROVIDED BY THE DEVELOPER AND SUBMITTED TO IRISH WATER FOR REVIEW.

4. APPROVED PRE-CAST CONCRETE BASES MAY BE USED INCORPORATING

- 6. MANHOLES GREATER THAN 3m IN DEPTH WILL REQUIRE A DETAILED STRUCTURAL DESIGN AND BE SUBJECT TO IRISH WATER APPROVAL.
 7. MANHOLE ROOFS SHOULD CONSIST OF RE-INFORCED CONCRETE SLAB
- 7. MANHOLE ROOFS SHOULD CONSIST OF RE-INFORCED CONCRETE SLAB OF IN-SITU CONCRETE, C30/37, WITH A MINIMUM THICKNESS OF 225mm DESIGNED TO CARRY ALL LIVE AND DEAD LOADS, ALTERNATIVELY, APPROVED PRE-CAST CONCRETE ROOF SLABS MAY BE USED SUBJECT TO IRISH WATER APPROVAL AND COMPLIANCE WITH BS 5911 PART 4: 2002.
- 8. COVERS AND FRAMES SHALL BE SUITABLE FOR ROAD AND TRAFFIC CONDITIONS SUBJECT TO APPROVAL FROM IRISH WATER.
- 9. 200mm ALL AROUND, 100mm DEEP CONCRETE PLINTH WITH PROTECTIVE STAINLESS STEEL METAL BAND AROUND COVERS IN GREEN AREAS
- 10. ALL CHAMBERS TO BE CHECKED FOR UPLIFT BY THE DEVELOPER BASED ON GROUND CONDITIONS WITHIN THE SITE. SHOULD ANTI FLOATATION MEASURES BE REQUIRED THEY SHALL BE SUBJECT TO APPROVAL FROM IRISH WATER.
- 11. ALL CONCRETE TO BE IN ACCORDANCE WITH IS EN 206 : 2013.

- ALL DIMENSIONS ARE IN MILLIMETRES (mm) UNLESS NOTED
 OTHERWISE
- 2. IN-SITU MANHOLES TO HAVE A MINIMUM WALL AND FLOOR
 THICKNESS OF 225mm FOR MANHOLE DEPTHS UP TO 3.0m AND
- 300mm OR MORE WHEN THE MANHOLE DEPTH EXCEEDS 3.0m.
 3. STRUCTURAL DESIGN & REINFORCEMENT DETAILS TO BE PROVIDED BY THE DEVELOPER AND SUBMITTED TO IRISH WATER FOR REVIEW.
- 4. MANHOLES GREATER THAN 3m IN DEPTH WILL REQUIRE A DETAILED STRUCTURAL DESIGN AND BE SUBJECT TO IRISH WATER APPROVAL.
- 5. COVERS AND FRAMES SHALL BE SUITABLE FOR ROAD AND TRAFFIC CONDITIONS SUBJECT TO APPROVAL FROM IRISH WATER.
- 6. 200mm ALL AROUND, 100mm DEEP CONCRETE PLINTH WITH PROTECTIVE STAINLESS STEEL METAL BAND AROUND COVERS IN
- GREEN AREAS.

 7. ALL CHAMBERS TO BE CHECKED FOR UPLIFT BY THE DEVELOPER BASED ON GROUND CONDITIONS WITHIN THE SITE. SHOULD ANTI FLOATATION MEASURES BE REQUIRED THEY SHALL BE SUBJECT TO
- APPROVAL FROM IRISH WATER.

 8. ALL CONCRETE TO BE IN ACCORDANCE WITH IS EN 206 : 2013.

GENERAL NOTES:

1. THIS DRAWING IS TO BE READ IN CONJUNCTION WITH ALL RELEVANT ARCHITECTS & ENGINEERS DRAWINGS, SPECIFICATIONS, ETC..

2. DO NOT SCALE, USE FIGURED DIMENSIONS ONLY (WHERE APPLICABLE)

3. ANY DISCREPANCIES / DEVIATIONS ENCOUNTERED TO BE REPORTED TO THE ENGINEER IMMEDIATELY (IN WRITING).

4. FOR ALL SETTING OUT DIMENSIONS REFER TO ARCHITECTS DRAWINGS.

P1	PF	PLANNING	02-05-2022
**	* DO NO	T SCALE USE FIGURED DIMENSI	ONS ONLY ***

drawn by: PM		TECH. CHECK:	PM
scale: AS SHOWN	SIZE: A1	ENG. CHECK:	AF
DATE: 08/01/2	2021	APPROVED:	AF

DRAWING STATUS: FOR PLANNING

GEENHILLS LIVING
C/O BELVEDERE LIVING LTD

JOB TITLE: BANCROFT VIEW SHD

DRAINAGE DETAILS
SHEET 2 OF 4



Fitzsimons Doyle & Associates
250 Harolds Cross Road, Dublin 6w

Tel: +353 (0) 4966011 Fax: +353 (0) 4967018

Web: www.fdaconsulting.ie Email: admin@fdaconsulting.ie

JOB No: 20_4993

DRAWING No:

REV:

P1