All work to comply with:

- (a) Building Regulations
- (b) Relevant Irish Standards Specification (IS) or British Standards (BS)
- (c) Accepted Codes of Practice
- (d) Requirements of the Department of the Environment
- (e) Conditions of Grant of Planning Permission

The work throughout shall be executed in a proper and workmanlike manner using the best available materials of their kind

The works are to comply with Department of Environment/ Homebond/Sustainable Energy Authority Ireland -Acceptable Construction Details. The Main Contractor should provide Clients with Checklist and Comments that the building has been completed correctly

KITCHEN FITTINGS:

KITCHEN TO BE SUPPLIED AND FITTED BY OTHERS.
EXACT LAYOUT TO BE CONFIRMED WITH CLIENT, CONTRACTOR
TO MAKE ALL NECESSARY M&E ATTENDANCES TO SUIT.
PROVIDE MECHANICAL EXTRACT FANTO COOKER HOOD.
PROVIDE WASTE/WATER SUPPLY TO DISHWASHER, ALL
KITCHEN WASTE PIPES TO BE CONCEALED WITH NO SURFACE
MOUNTED PIPEWORK

UTILITY FITTINGS:

UTILITY FITTING BY OTHERS. CONTRACTOR TO CONFIRM WITH CLIENT POSITION OF ALL APPLIANCES & FITTINGS TO BE INSTALLED WITHIN UTILITY ROOM PRIOR TO COMMENCEMENT. PROVIDE ADDITIONAL VENT FROM TUMBLE DRYER AS REQUIRED.

CONTRACTOR TO MAKE ALL NECESSARY ATTENDANCES

WC/BATHROOM/EN-SUITES:

ALL BATHROOM/WC & EN-SUITE LAYOUTS FOR SANITYWARE ARE PROVISIONAL ONLY. CONTRACTOR TO SEEK FINAL LAYOUT DETAILS AND APPROVAL FROM CLIENT PRIOR TO CONSTRUCTION & INSTALLATION

STRUCTURAL STEELWORK:

REFER TO STRUCTURAL ENGINEERS DRAWINGS FOR EXACT POSITION & SPECIFICATION OF ALL STEELWORK. SEE ENGINEERS CALCULATION SHEETS FOR CONCRETE PADSTONE BEARING SIZES AND SPECIFICATIONS

MOVEMENT JOINTS:

MOVEMENT JOINTS TO BE USED IN STRUCTURE AS SET OUT IN NSAI RECOMMENDATIONS TO EUROCODE 6 FOR THE DESIGN OF

MASONARY STRUCTURE IN IRELAND WHERE A MAXIMUM DISTANCE BETWEEN THE MOVEMENT JOINTS IN MASONARY WILL

NO BE GREATED THAN 7M. THESE MOVEMENT JOINTS SHOULD BE

10mm WIDE AND THERE SHOULD BE WALL TIES ON BOTH SIDES OF

THE JOINT AT 225mm C/C VERTICALLY

GROUND FLOOR CONSTRUCTION-

To provide - 0.11 U-Value (W/m2K)

- See Finishes Schedule for Selected Floor Finish.
- 50mm Concrete (Sand & Cement) Floor Screed structural where required incorporating Underfloor Heating Pipes attached

to mesh in floor.

- Vapour barrier
- 150mm Xtratherm HYF Floor Insulation installed in 2 x

75mm

layers staggered from bottom layer with 50mm Perimeter Insulation Boards.

- 150mm Concrete floorslab
- Monarflex RMB350 Radon Barrier, or similarly approved, strictly

to manufacturers instalation instructions.

- 50mm well compacted Sand Blinding.
- 150mm min. hardcore to Engineers Specification.

PITCHED ROOF (along ceiling) CONSTRUCTION -

Toprovide 0.12 U-Value (W/m2K) blue/black or fibre cement slate on treated sw batten, on pro clima solitex plus breather membrane on rafters to engineer's specification above attic void Ceiling Joist -

200mm fibre insulation laid over joists with 200mm fibre insulation between joists to comply with part L of the building regulations (T.G.D.'s) and as per preliminary BER specification, on pro clima INTELLO® PLUS airtight barrier with all joints taped and sealed on 25mm service cavity with 12.5mm plasterboard and 3 mm skim & painted emulsion finish

FLAT ROOF CONSTRUCTION -

To provide 0.13 U-Value (W/m2K)

fibreglass roof finish by specialist installer or single-ply membrane by "Trocal" or similar approved manufacturer on 18mmO.S.B. ply on 160mmXtrathermFR/ALU over rafters to meet B.E.R. spec u-value of 0.13 or greater on vapour control layer (NB: Full buildup as per manufacturers recommendations and specification) on selected O.S.B board on tapered firring pieces on timber ceiling joists to engineers specification and detail, installed to manufactures specification.

PART A - STRUCTURE

TOBE IN ACCORDANCE WITH THE REQUIREMENTS OF BUILDING REGULATIONS, TECHNICAL GUIDANCE DOCUMENT, PART A, SECTIONS 1 TO 3 INCLUSIVE.

PART B - FIRE

TO BE IN ACCORDANCE WITH THE REQUIREMENTS OF BUILDING REGULATIONS, TECHNICAL GUIDANCE DOCUMENT, PART B, SECTIONS 1 TO 5 INCLUSIVE.

PARTC-SITE PREPARATION AND RESISTANCE TO MOISTURE TO BE IN ACCORDANCE WITH THE REQUIREMENTS OF

BUILDING REGULATIONS, TECHNICAL GUIDANCE DOCUMENT, PART C, SECTIONS 1 TO 5 INCLUSIVE.

PART D - MATERIALS AND WORKMANSHIP

TO BE IN ACCORDANCE WITH THE REQUIREMENTS OF BUILDING REGULATIONS, TECHNICAL GUIDANCE DOCUMENT, PART D, SECTIONS 1 AND 2 INCLUSIVE.

PART E - SOUND

TO BE IN ACCORDANCE WITH THE REQUIREMENTS OF BUILDING REGULATIONS, TECHNICAL GUIDANCE DOCUMENT, PART E, SECTIONS 1 AND 4 INCLUSIVE.

PART F - VENTILATION

TO BE IN ACCORDANCE WITH THE REQUIREMENTS OF BUILDING REGULATIONS, TECHNICAL GUIDANCE DOCUMENT, PART F, SECTIONS 1 AND 2 INCLUSIVE.

PART G - HYGIENE

TO BE IN ACCORDANCE WITH THE REQUIREMENTS OF BUILDING REGULATIONS, TECHNICAL GUIDANCE DOCUMENT, PART G, SECTIONS 1 AND 3 INCLUSIVE.

PART H - DRAINAGE & WASTE DISPOSAL

TO BE IN ACCORDANCE WITH THE REQUIREMENTS OF BUILDING REGULATIONS, TECHNICAL GUIDANCE DOCUMENT, PARTH, SECTIONS 1 AND 3 INCLUSIVE.

PART J - HEAT PRODUCING APPLIANCES

TO BE IN ACCORDANCE WITH THE REQUIREMENTS OF BUILDING REGULATIONS, TECHNICAL GUIDANCE DOCUMENT, PART J, SECTIONS 1 AND 4 INCLUSIVE.

PART K - STAIRWAYS, RAMPS AND GUARDS

TO BE IN ACCORDANCE WITH THE REQUIREMENTS OF BUILDING REGULATIONS, TECHNICAL GUIDANCE DOCUMENT, PART K, SECTIONS 1 AND 4 INCLUSIVE.

PART L - CONSERVATION OF FUEL AND ENERGY

TO BE IN ACCORDANCE WITH THE REQUIREMENTS OF BUILDING REGULATIONS, TECHNICAL GUIDANCE DOCUMENT, PART L, SECTIONS 1 AND 3 INCLUSIVE.

PART M-ACCESS FOR PEOPLE WITH DISABILITIES

TO BE IN ACCORDANCE WITH THE REQUIREMENTS OF BUILDING REGULATIONS, TECHNICAL GUIDANCE DOCUMENT, PART M, SECTIONS 1 AND 3 INCLUSIVE.

Rev Description Chkd Date

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Co. Meath

boyne.enterprises@outlook.com +353 87 359 5720

Client

Katherine McKenna

Projec

46 Heatherview Road House

Drawing

Drawing Notes Scale 1:100

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Construction

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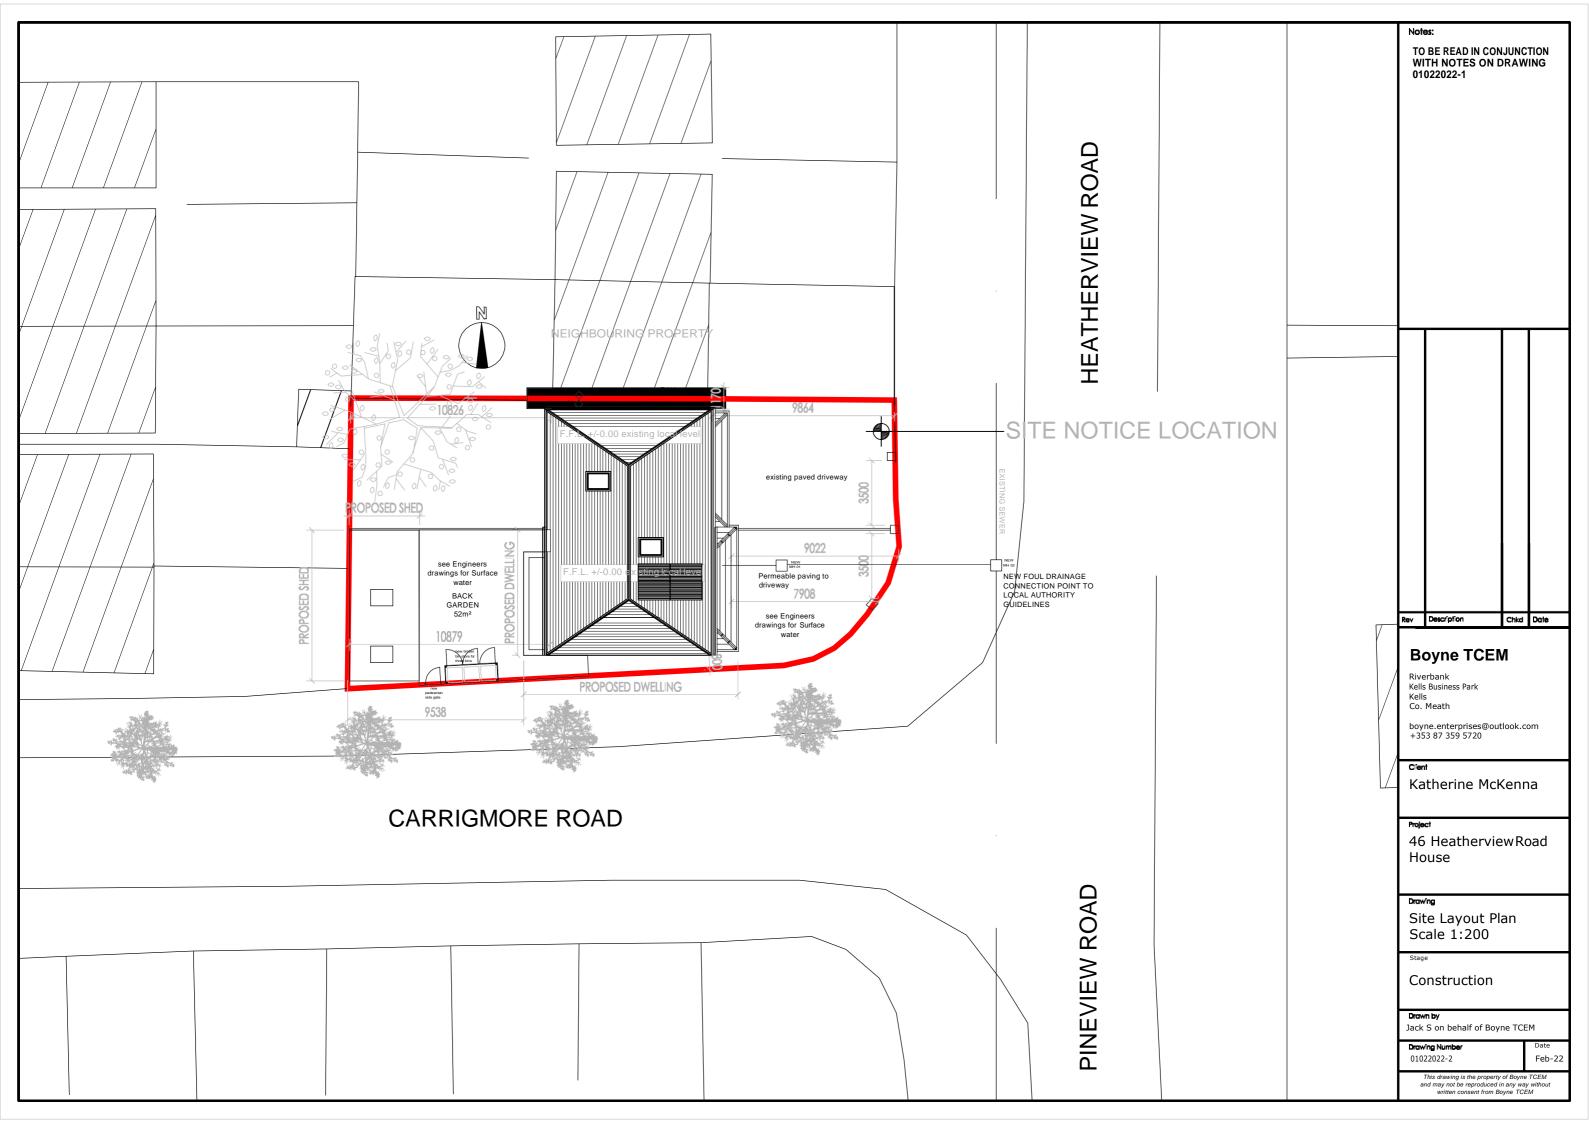
Jack S on behalf of Boyne TCEM

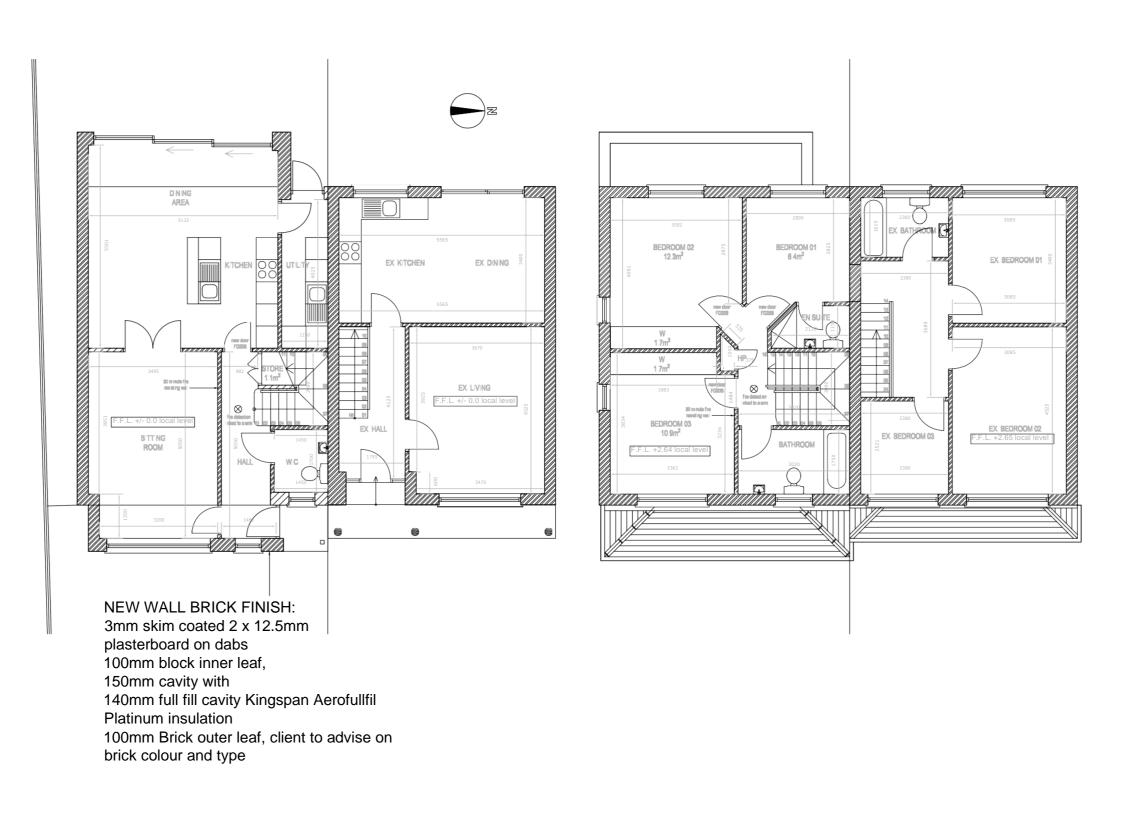
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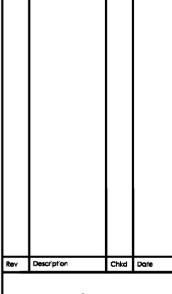




GROUND FLOOR PLAN FIRST FLOOR PLAN

Note

TO BE READ IN CONJUNCTION WITH NOTES ON DRAWING 01022022-1



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Plans Scale 1:100

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Drawn by

Jack S on behalf of Boyne TCEM

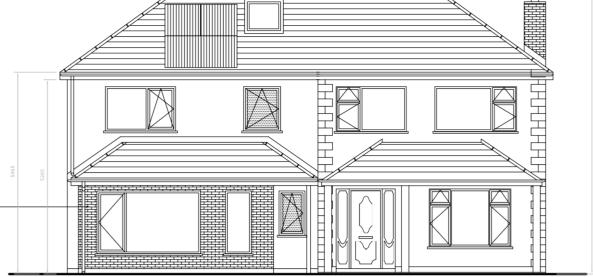
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NEW PITCHED ROOF:

tiles to match existing fixed to 38x50 s.w. battens on tyvek vapour permeable membrane on roof joists to be 175x44mm @ 400 c/c to eng. spec. ceiling joists to be 175x44mm @ 400 c/c to eng. spec.



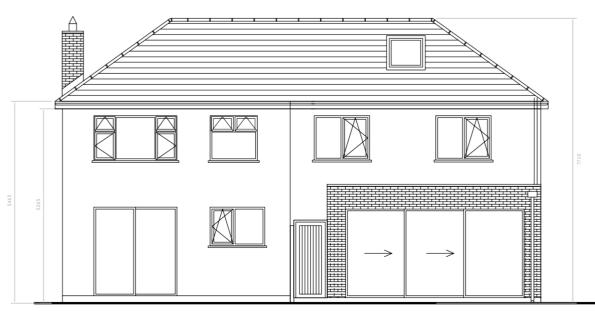
NEW WALL BRICK FINISH:

3mm skim coated 2 x 12.5mm
plasterboard on dabs
100mm block inner leaf,
150mm cavity with
140mm full fill cavity Kingspan Aerofullfil

Platinum insulation 100mm Brick outer leaf, client to advise on brick colour and type

NEW ROOF:

trocal 1.5mm or eq. app. fixed strictly in accordance with manufacturers recommendations on underlay on 150mm Kingspan Thermaroof TR31 between joists with 175x44 joists @ 400c/c with 12.5mm plasterboard with skim plaster finish under

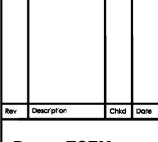


PROPOSED REAR ELEVATION

PROPOSED FRONT ELEVATION

Notes:

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Front & Rear Elev. Scale 1:100

Stage

Construction

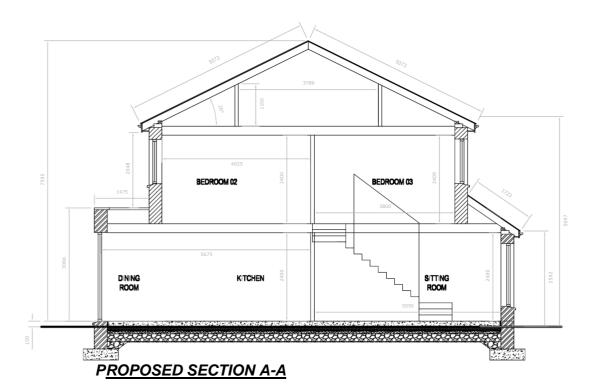
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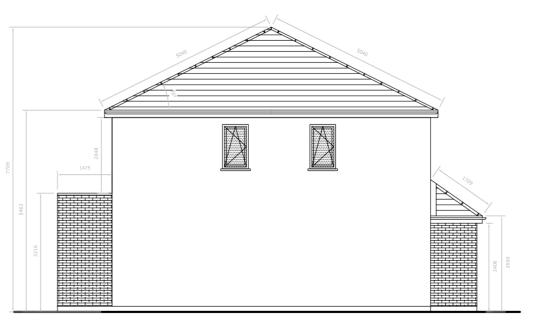
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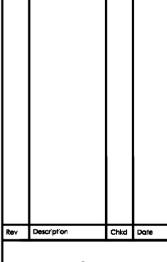




PROPOSED SIDE ELEVATION

Note

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Draw'r

Side Elev. & Section Scale 1:100

Stag

Construction

Drawn by

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