


**OSi PLACE Map**

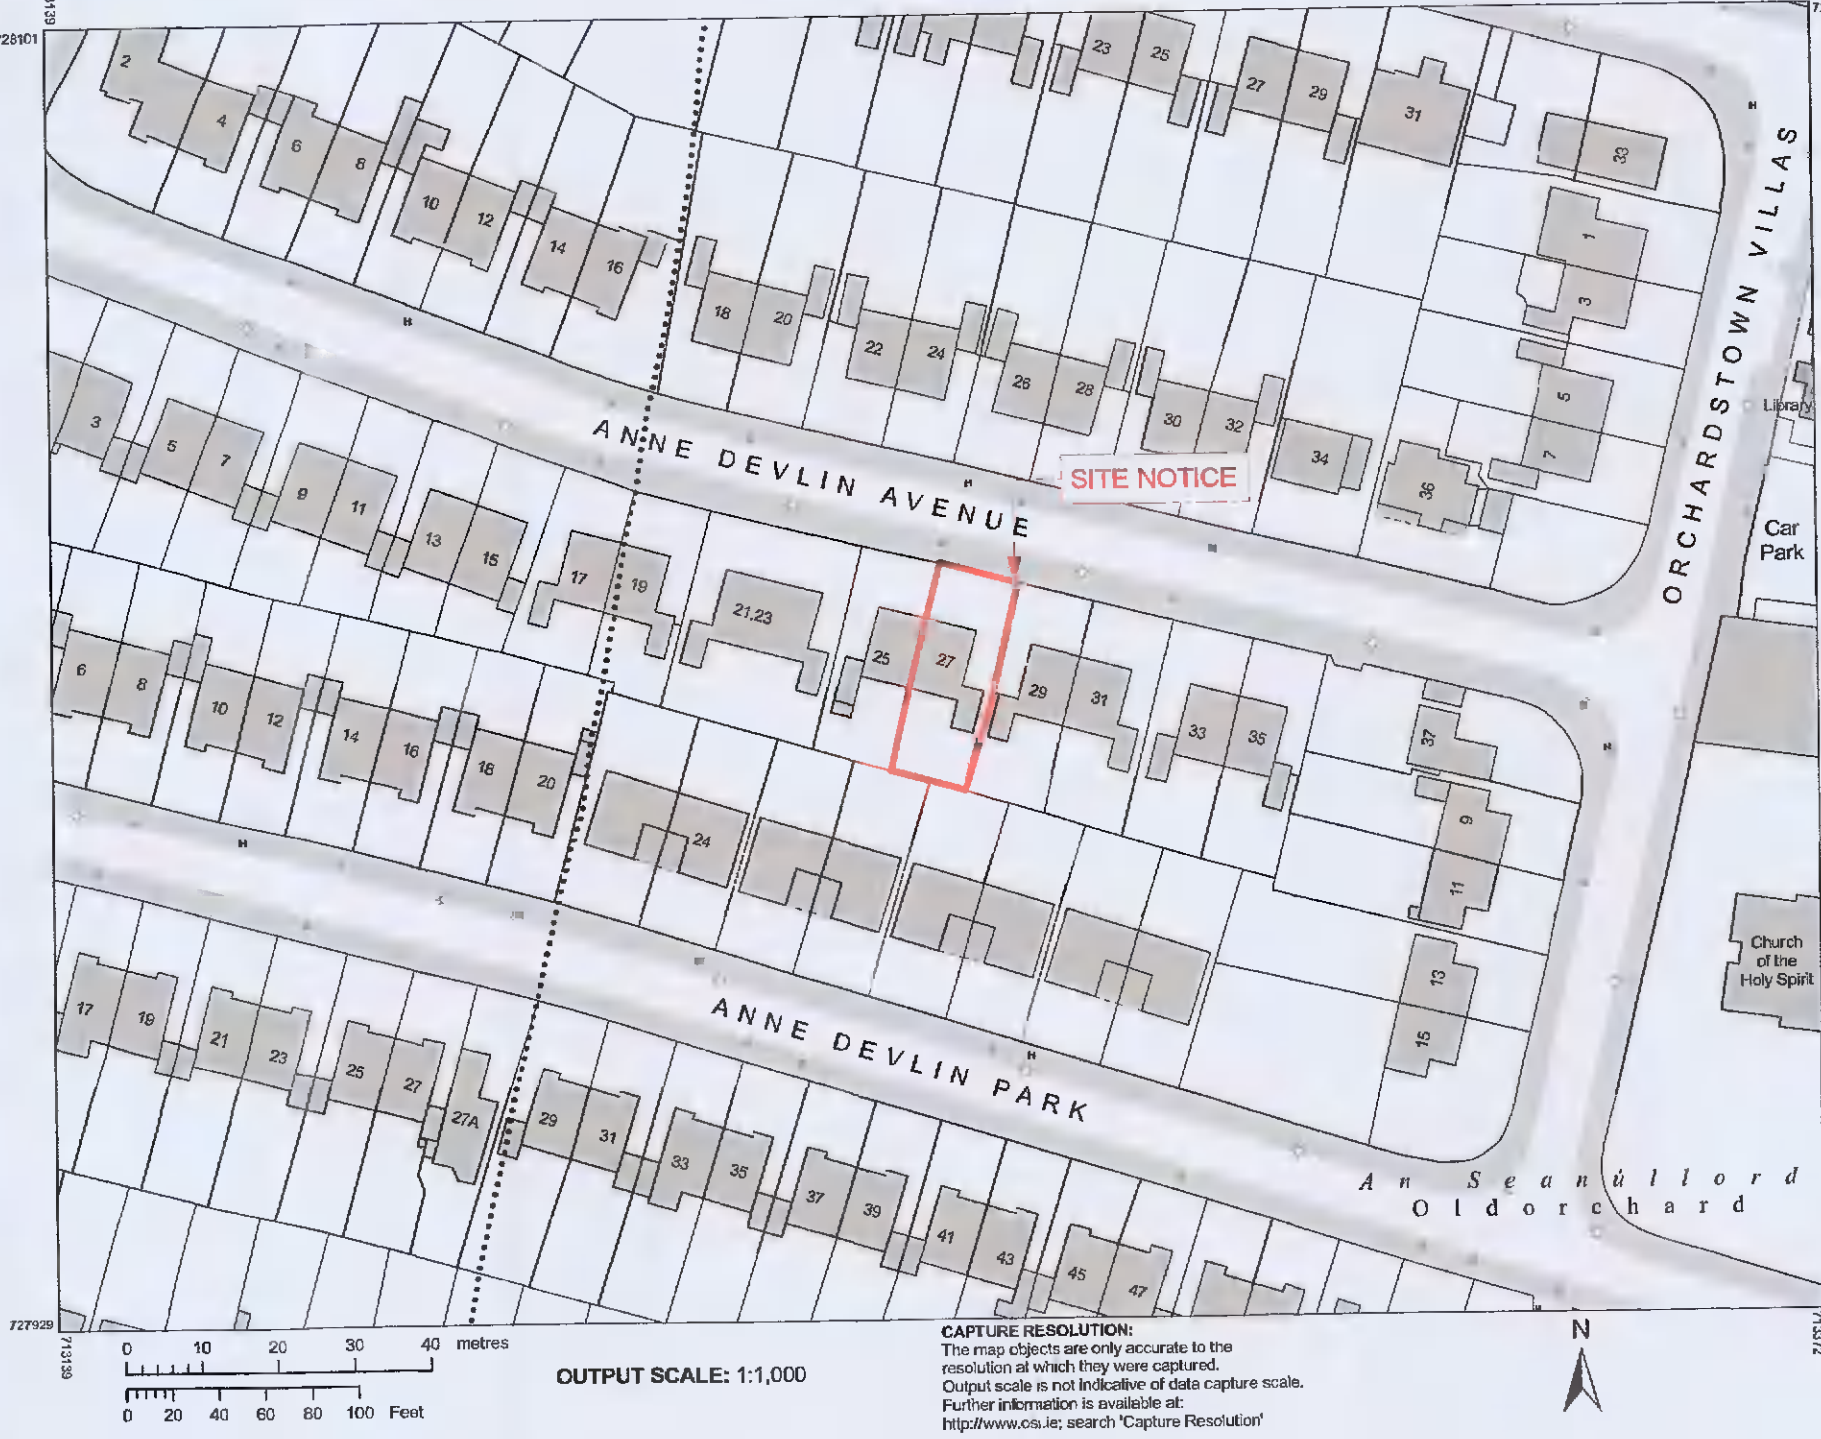

Ordnance Survey  
National Mapping Agency

CENTRE COORDINATES: ITM 713256,726015

PUBLISHED: 28/07/2021 ORDER NO.: 50205236\_1

MAP SERIES: 1:1,000 MAP SHEETS: 3391-07

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search 'Large Scale Legend'


CAPTURE RESOLUTION:  
The map objects are only accurate to the resolution at which they were captured.  
Output scale is not indicative of data capture scale.  
Further information is available at:  
<http://www.osi.ie>, search 'Capture Resolution'

OUTPUT SCALE: 1:1,000

1 SITE LOCATION  
Scale 1:1,000 @ A1 Sheet Size



2 EXISTING NORTH ELEVATION - FRONT ELEVATION  
Scale 1:100 @ A1 Sheet Size

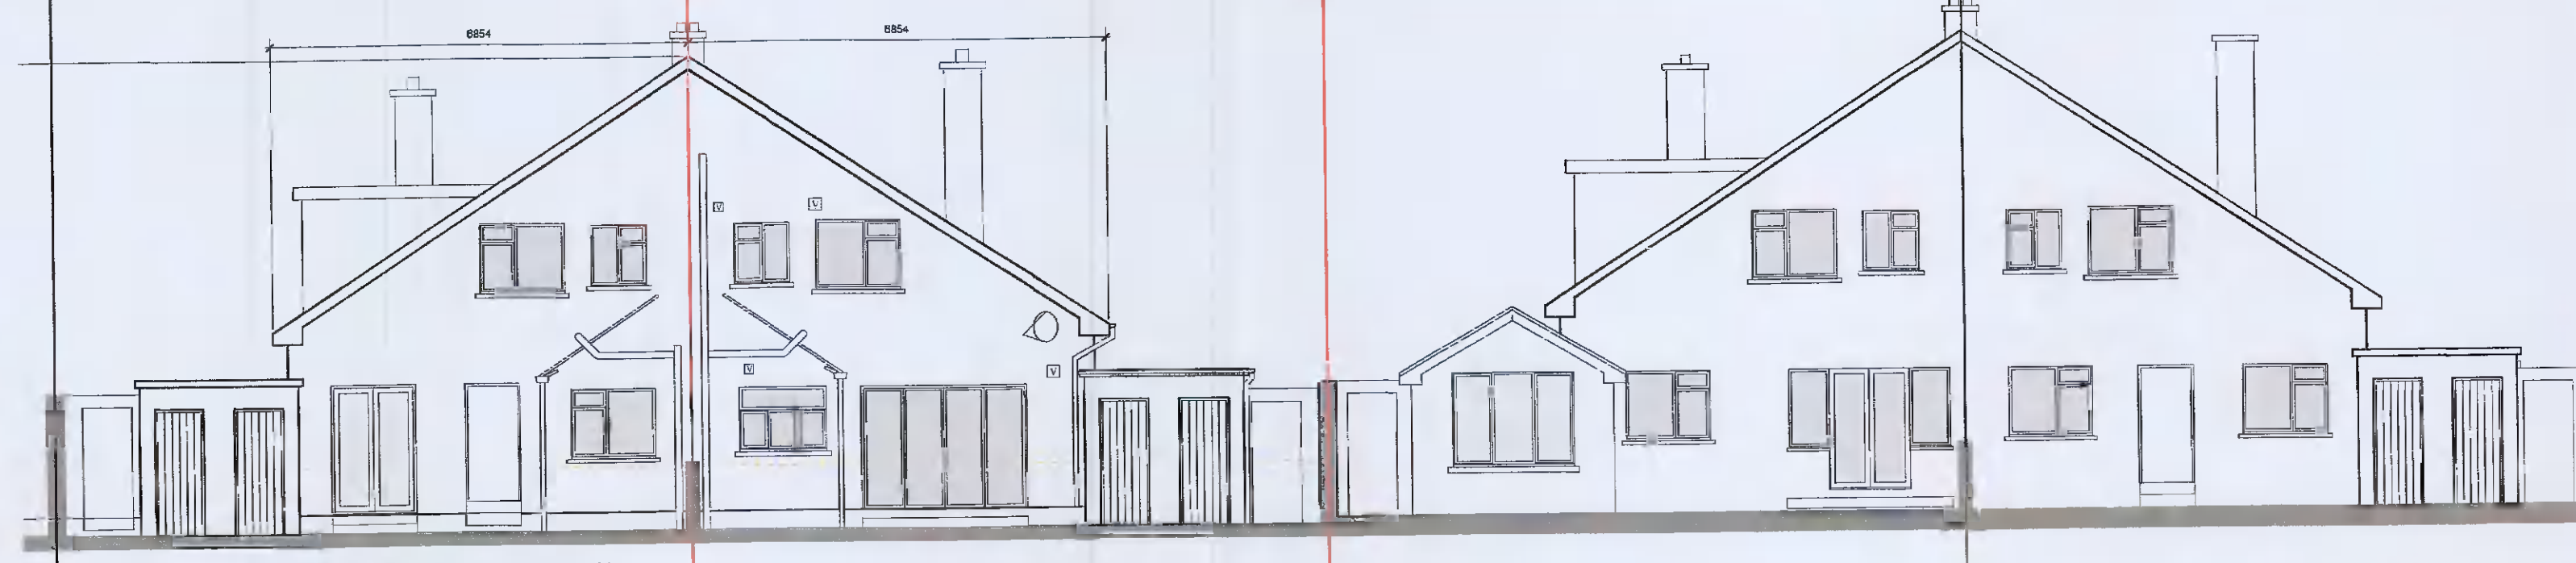


3 EXISTING SOUTH ELEVATION - REAR ELEVATION  
Scale 1:100 @ A1 Sheet Size


- notes
- do not scale from this drawing, use figured dimensions only.
  - all dimensions to be checked on site by the contractor before any work shall commence.
  - inform the architect immediately of any discrepancy.
  - all materials used should be new and of a suitable nature and quality in relation to the purpose and conditions of their use.
  - all materials should be adequately mixed or prepared in accordance with the manufacturers written instructions.
  - all materials should be used or fixed so as to perform adequately the function for which they are intended.
  - building tolerances should comply with BS 6954 part 1 1988.
  - workmanship on the building site should comply with the requirements of BS 6000.
  - all drawings to be read in conjunction with the Architects' Specification.
  - all drawings to be read in conjunction with the Engineers' Drawings & Specification.

LEGEND


|           |                           |
|-----------|---------------------------|
| RWP       | RAINWATER PIPE            |
| SVP       | SOIL/SOIL VENT PIPE       |
| SP        | SOIL PIPE                 |
| [Pattern] | PERMEABLE PAVING          |
| [Pattern] | PERMEABLE PEBBLE FINISH   |
| [Pattern] | EXISTING CONCRETE PATHWAY |
| GB        | GAS BOILER                |
| [Symbol]  | SATELLITE DISH            |

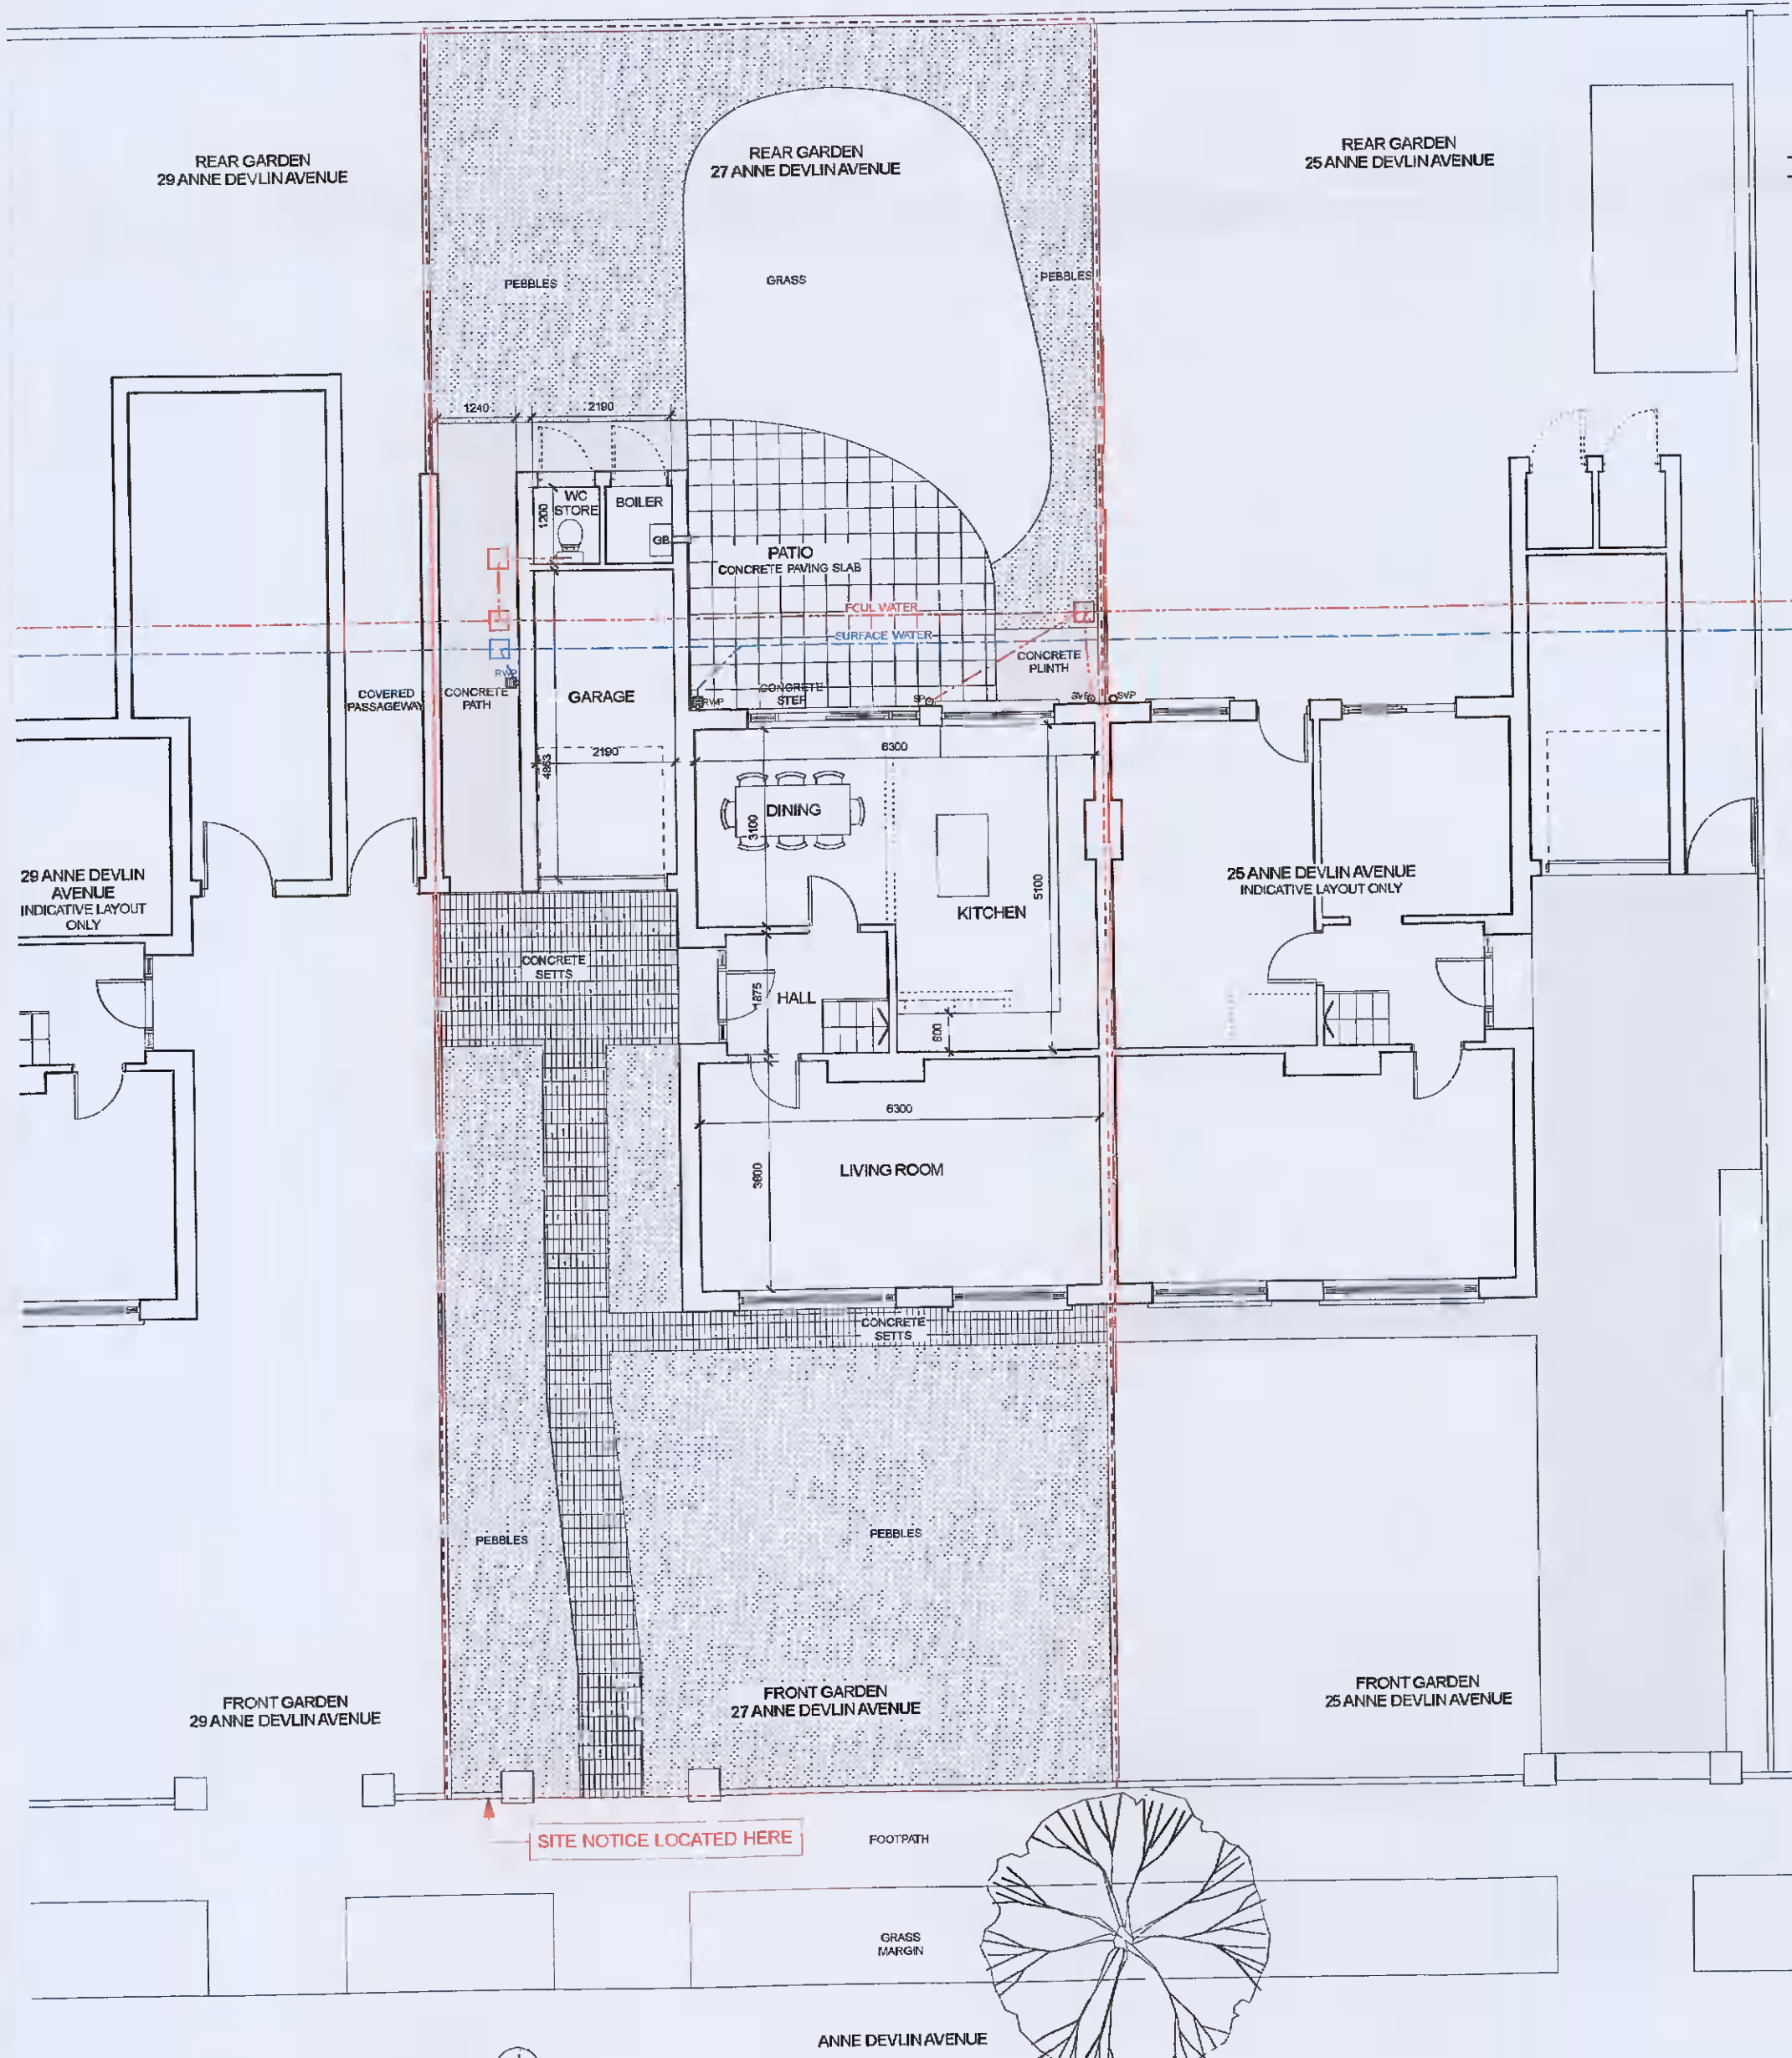


6 EXISTING GROUND FLOOR PLAN  
Scale 1:100 @ A1 Sheet Size

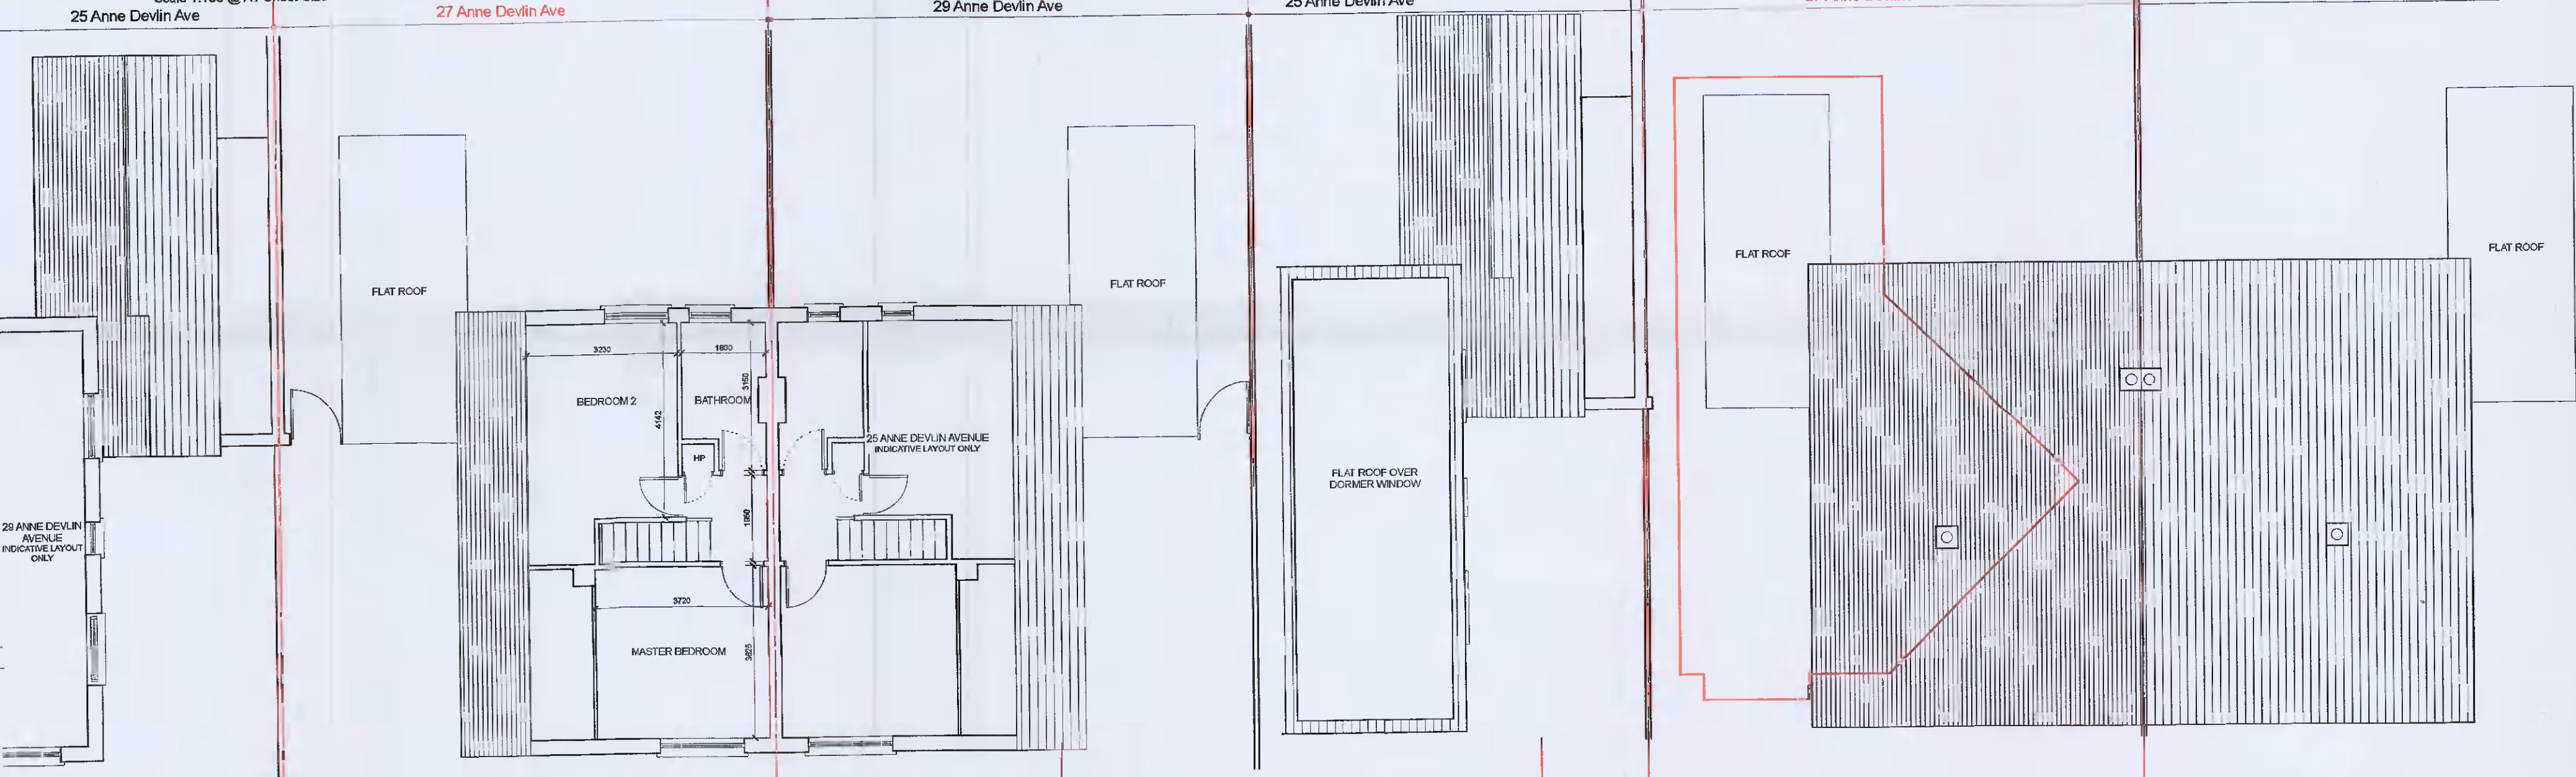

7 EXISTING ROOF PLAN  
Scale 1:100 @ A1 Sheet Size

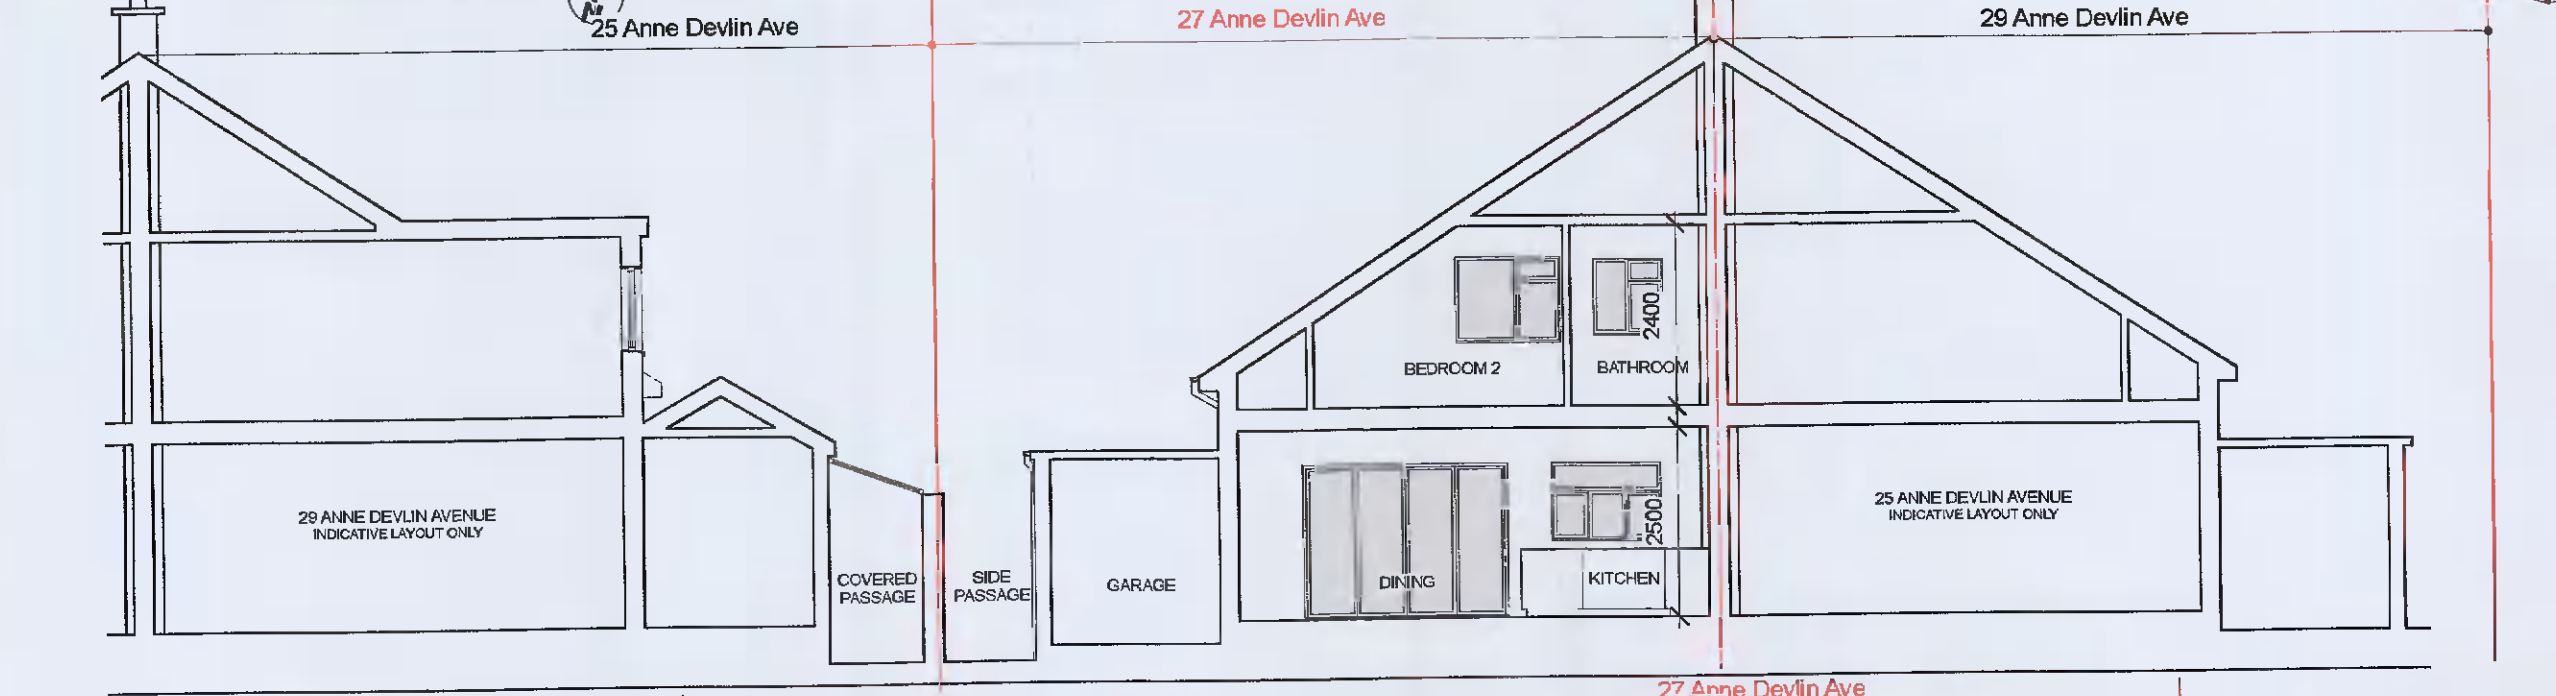

8 EXISTING FIRST FLOOR PLAN  
Scale 1:100 @ A1 Sheet Size

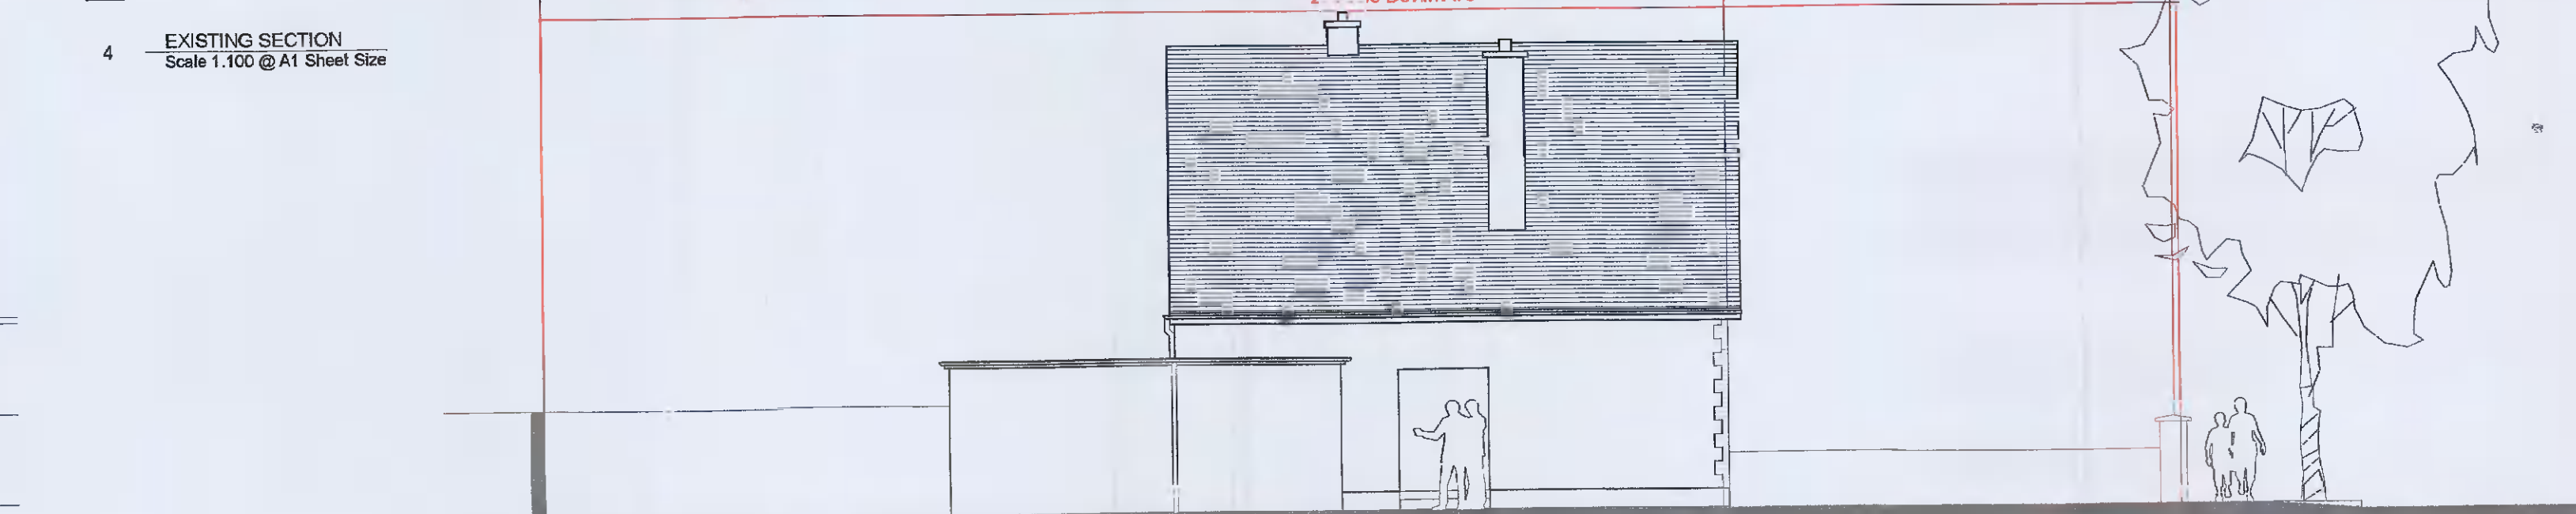

4 EXISTING SECTION  
Scale 1:100 @ A1 Sheet Size

APPLICATION FOR PLANNING PERMISSION ONLY

|         |  |             |          |
|---------|--|-------------|----------|
| project | EXTENSION TO 27 ANNE DEVLIN AVENUE RATHFARNHAM, DUBLIN 14 D14 H5M4 | drawing no. | 100      |
| client  | LAURA & CRAIG SARGEANT   | revision    | 0        |
| drawing | PROPOSED FLOOR PLANS   | date        | FEB 2022 |
| job no. | 882  | scale       | AS SHOWN |

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