





SUDS POND TYPICAL SECTION


THE TRENCH WILL BE BACKFILLED AND COMPACTED AFTER PLACING THE GEOMEMBRANE IN POSITION
 Note 1 GROUND TO BE PREPARED TO ENGINEERS SPECIFICATION BEFORE INSTALLATION OF GEOMEMBRANE
 Note 2 TRENCH DEPTH MAY VARY TO SUIT PROJECT REQUIREMENTS

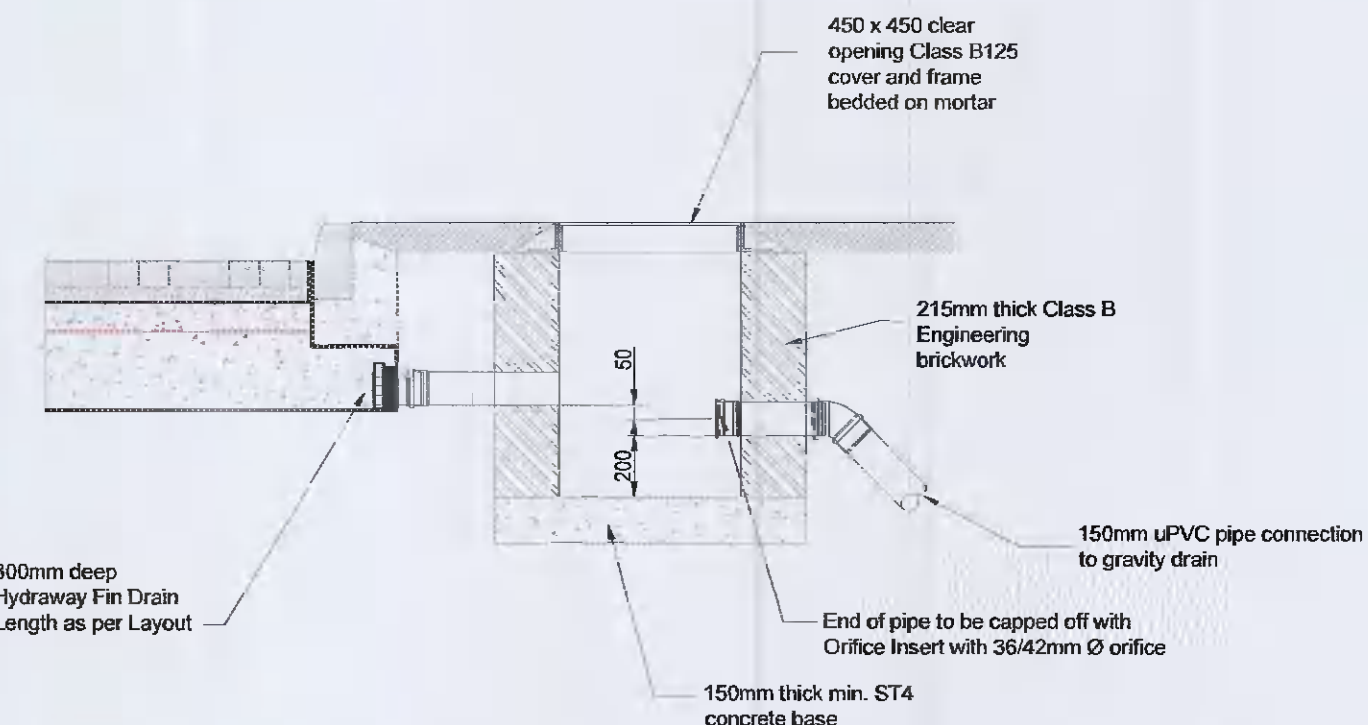


TYPICAL OUTLET DETAIL

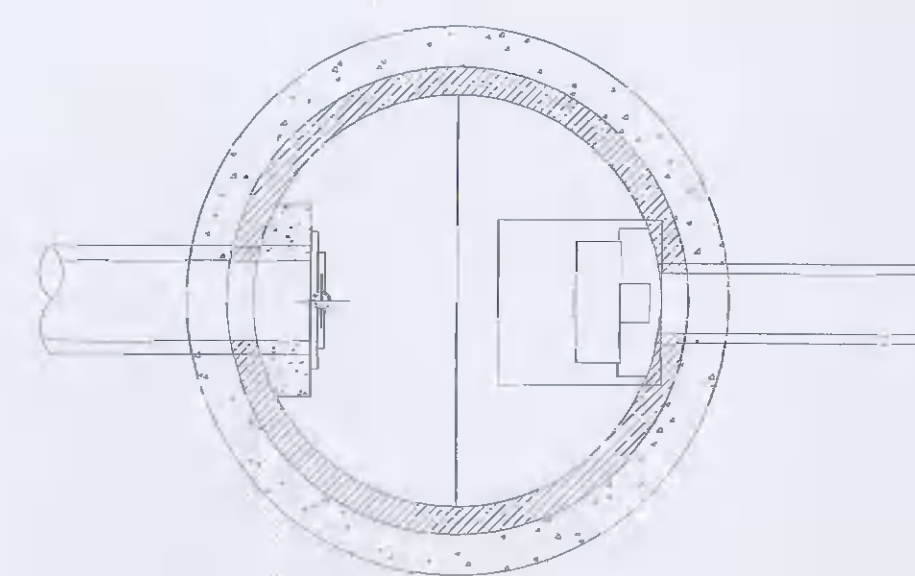


PLAN FLOW CONTROL MANHOLE DETAIL SCALE 1:25

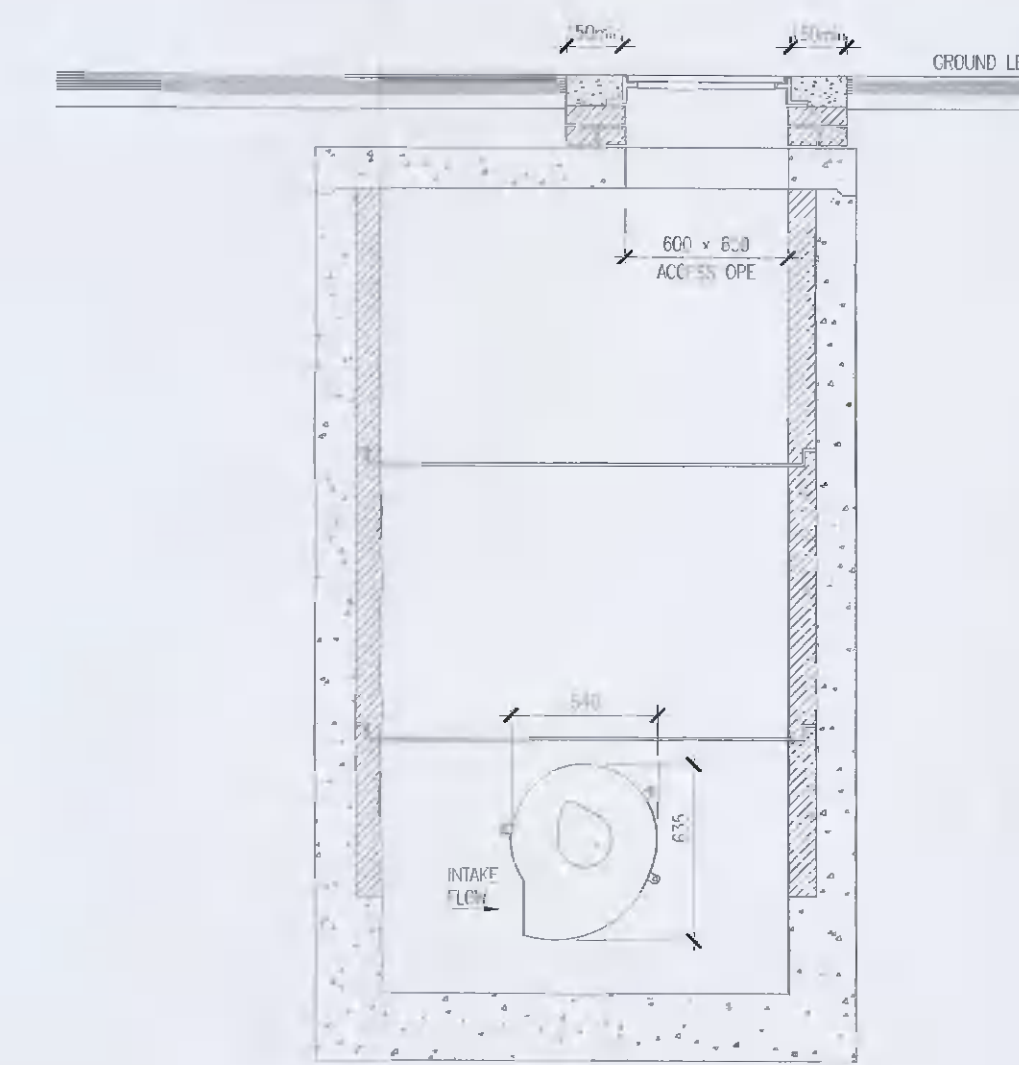


SECTION A-A FLOW CONTROL MANHOLE DETAIL SCALE 1:25

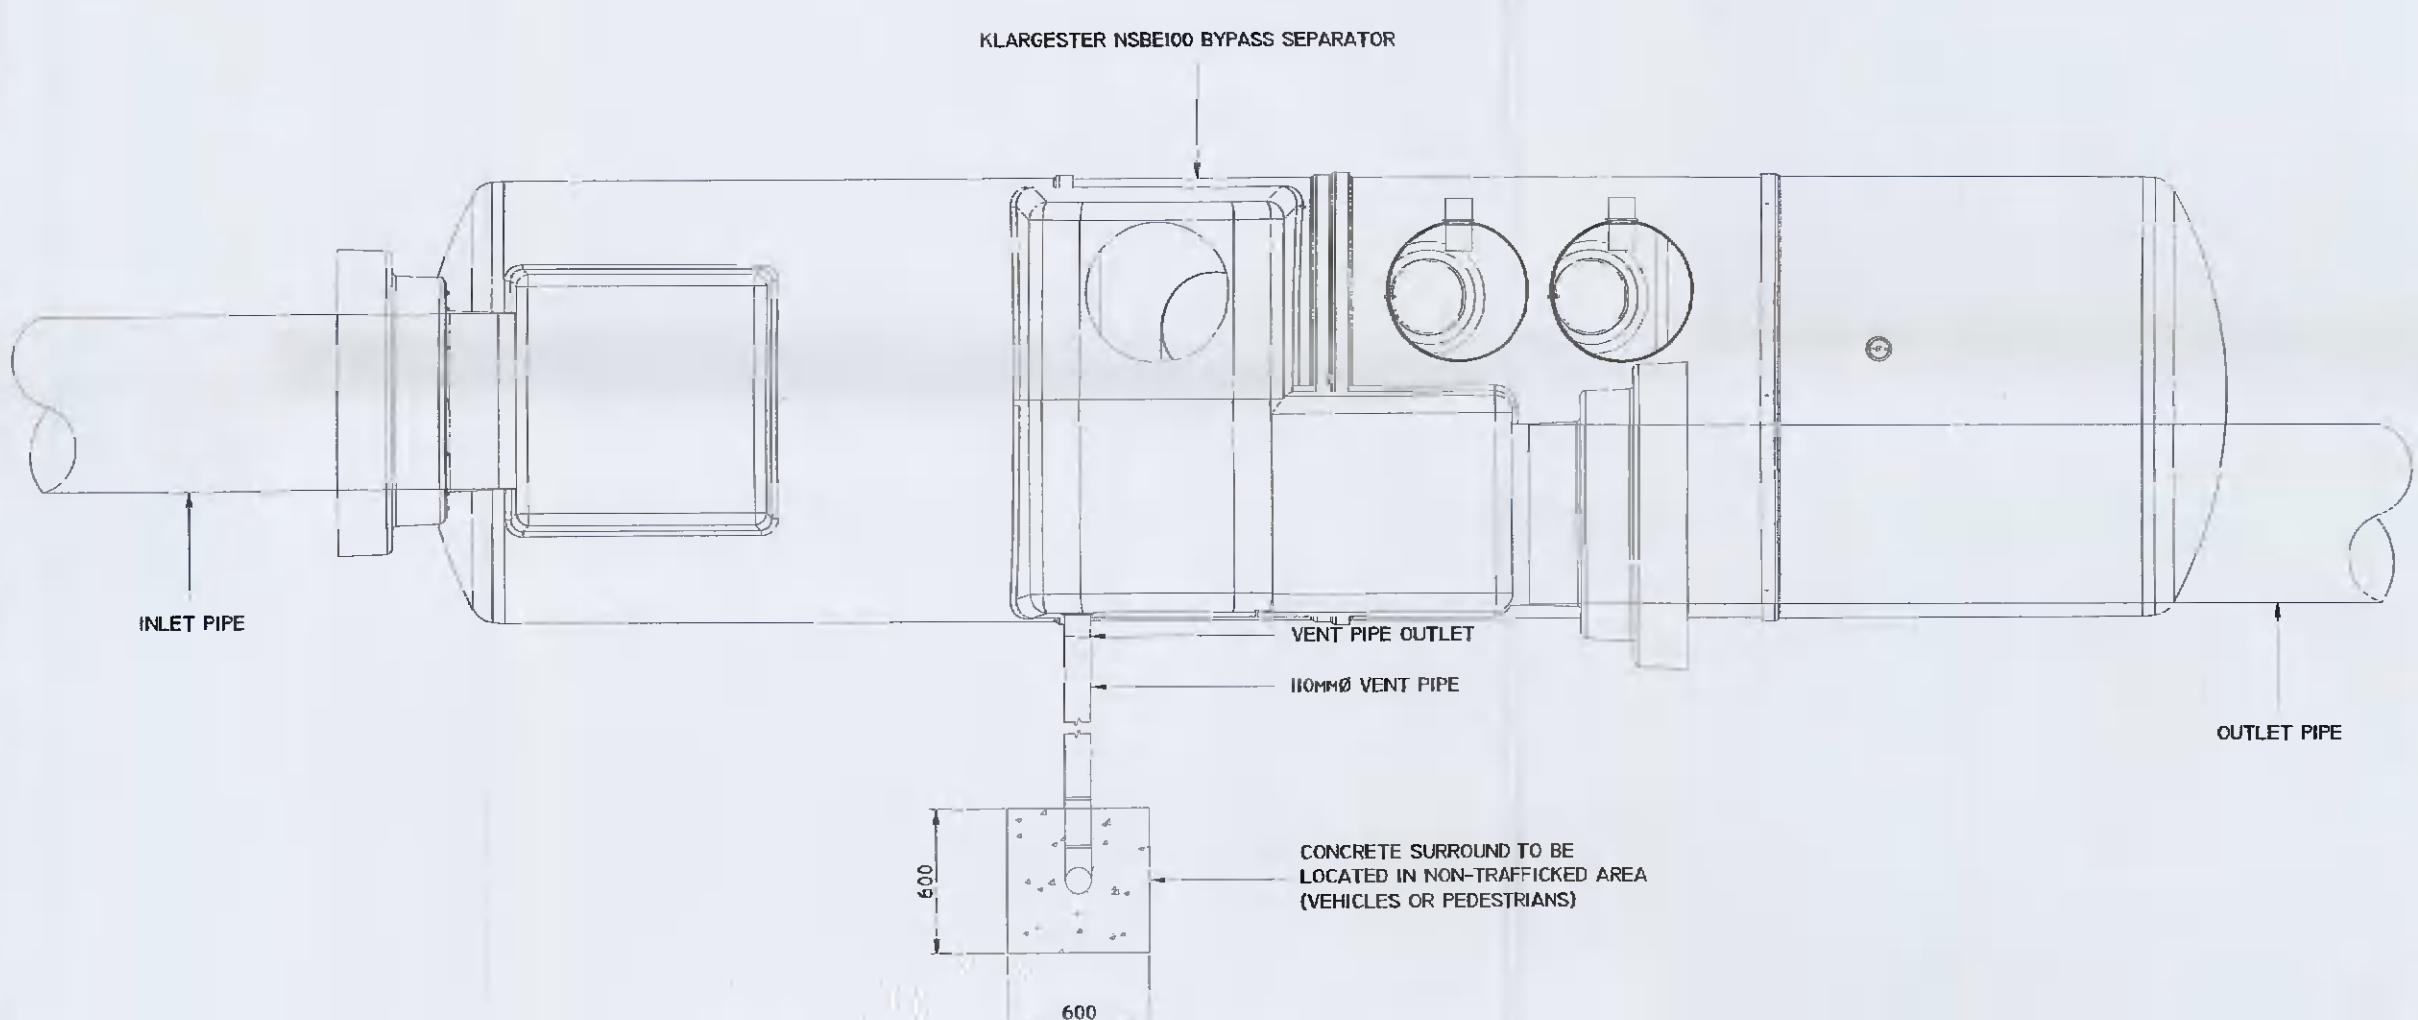


TYPICAL PETROL INTERCEPTOR VENT PIPE DETAIL PLAN

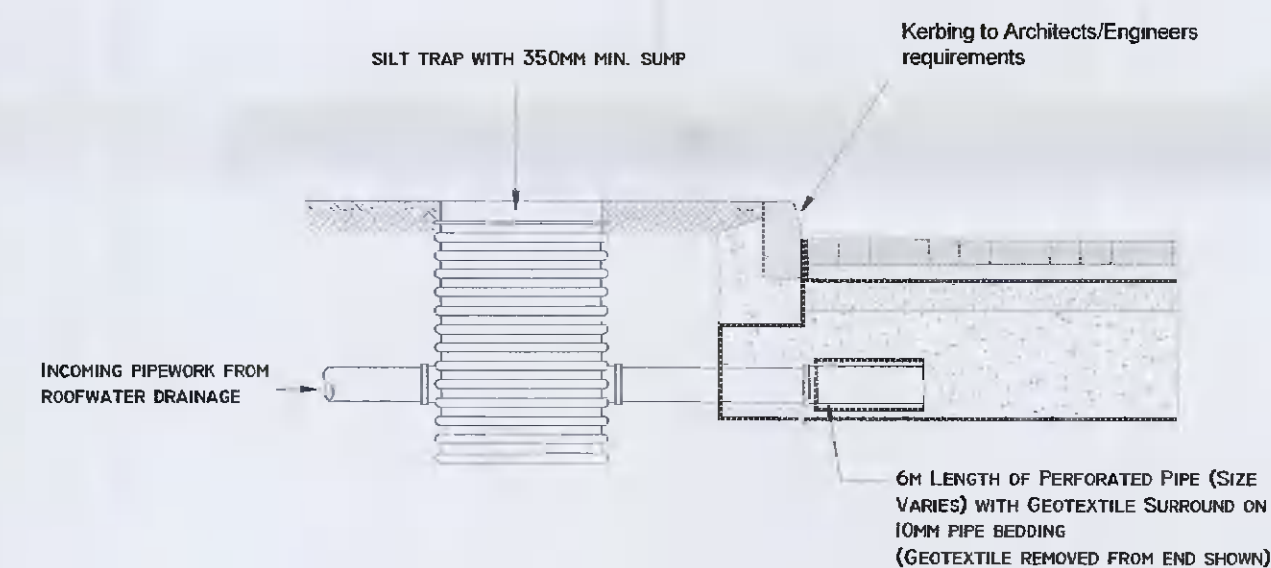


TYPICAL INLET DETAIL FOR DISTRIBUTION BOX

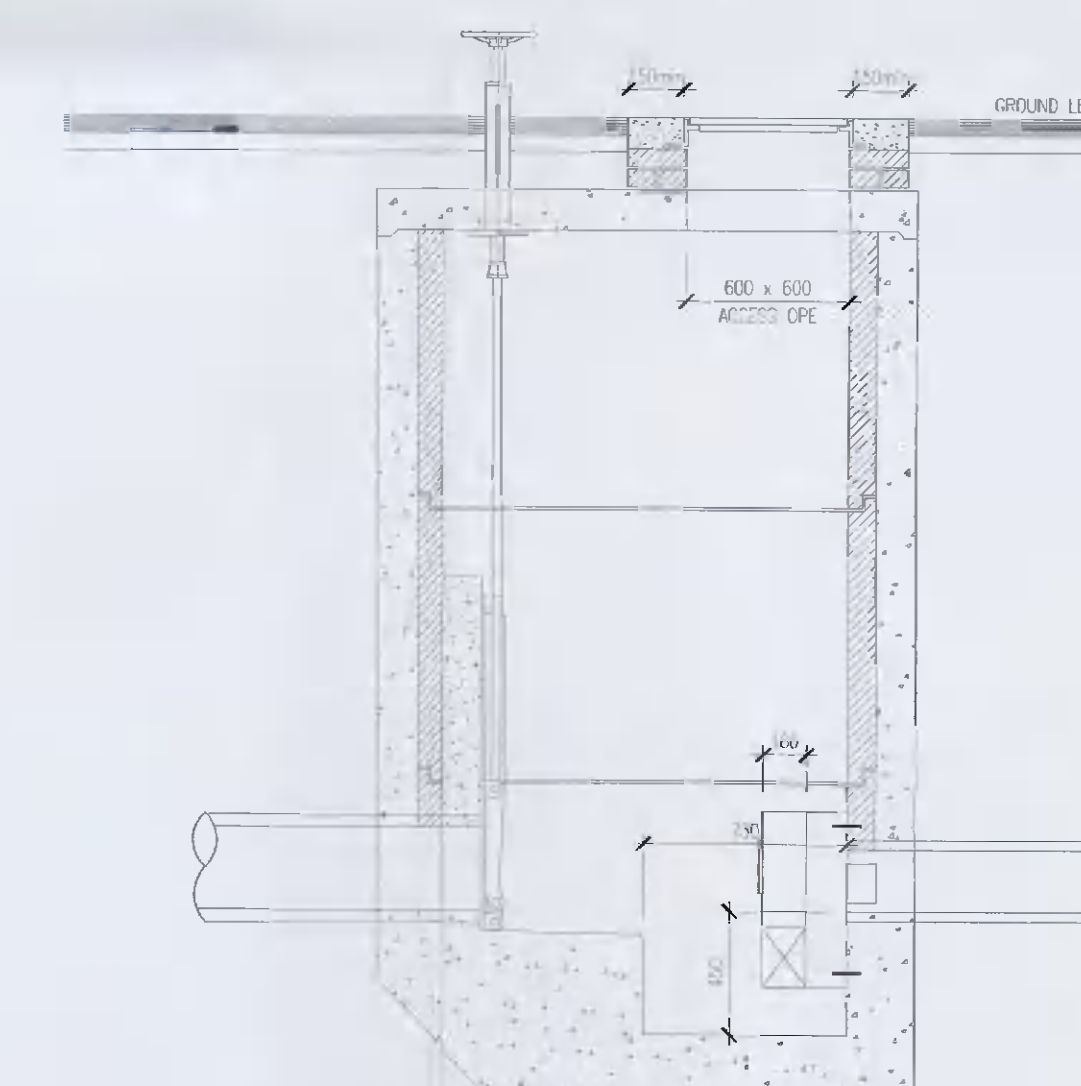


SECTION B-B FLOW CONTROL MANHOLE DETAIL SCALE 1:25

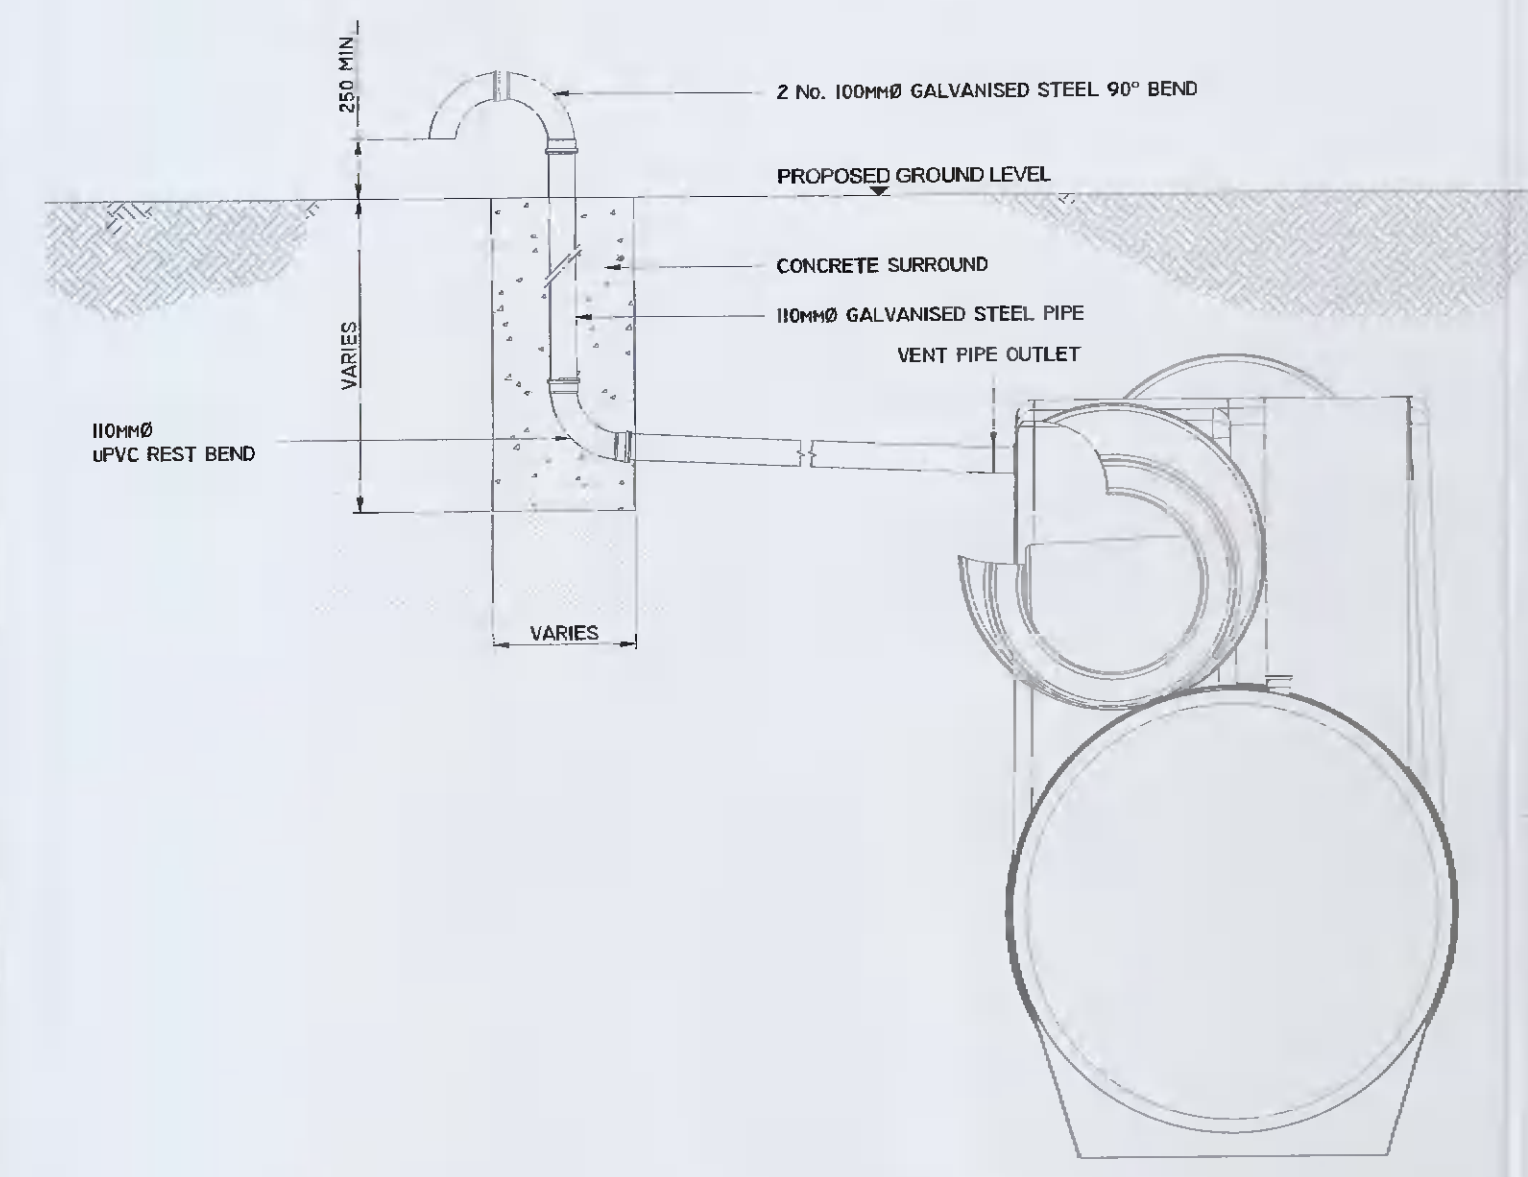

TYPICAL PETROL INTERCEPTOR VENT PIPE DETAIL ELEVATION

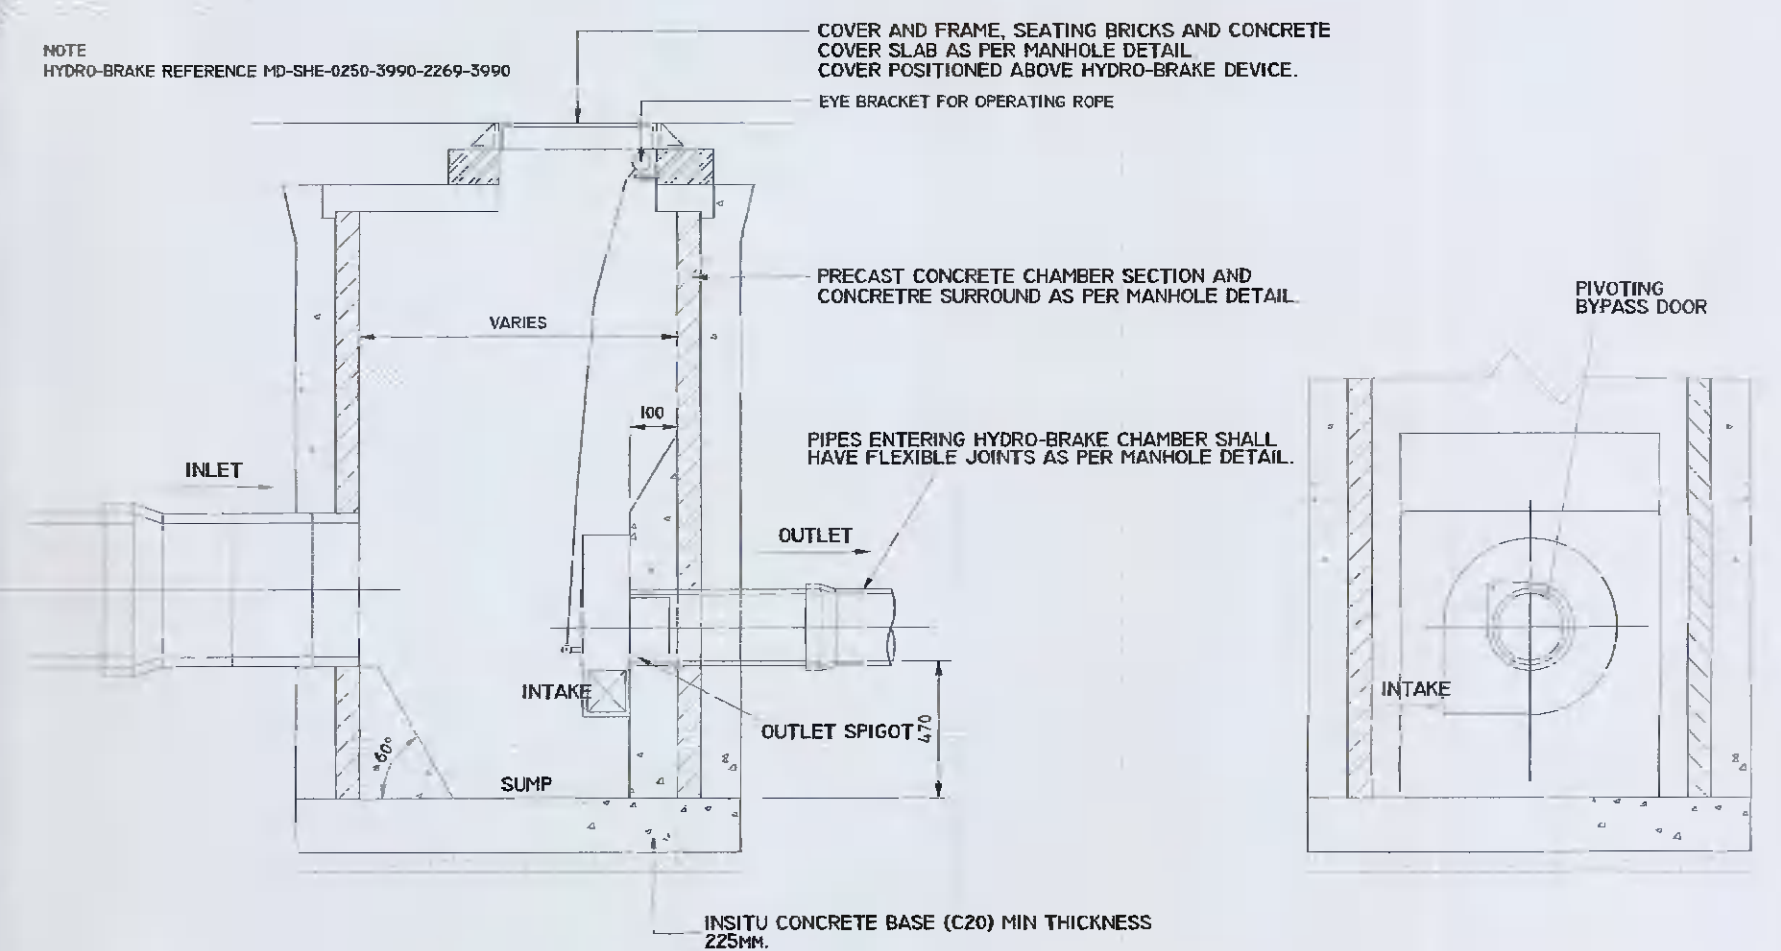

TYPICAL HYDRO-BRAKE MANHOLE DETAILS

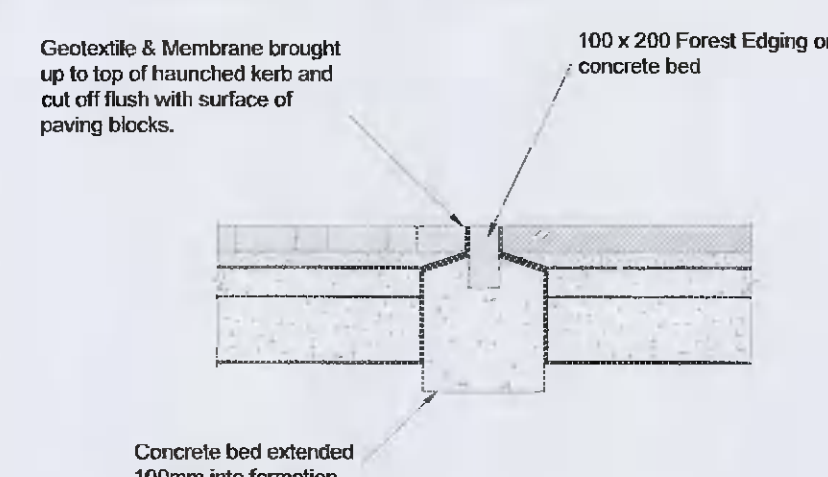

FULL HEIGHT RESTRAINT DETAIL

Client: **EQUINIX**

HAZARD IDENTIFICATION LEGEND:

HAZARD IDENTIFICATION (if none state 'none relevant')	CONTROL AND MITIGATION MEASURES

NOTE:
 Hazards listed above are only those considered significant risks and:
 a) not likely to be obvious to a competent contractor or other designers;
 b) unusual; or
 c) likely to be difficult to manage effectively

NOTE:
 REFER DRAWING DB080-PIN-00-ZZ-DR-C-PLAN-1295 FOR SUDS CATCHMENT LAYOUT AND SUDS FEATURES
 REFER DRAWING DB080-PIN-00-ZZ-DR-C-PLAN-1207 FOR SURFACE WATER DRAINAGE LAYOUT

PLANNING REGISTRATION REFERENCE: SD21A/0186

DESIGN ISSUE
 THE DESIGN IS SUBJECT TO PLANNING APPROVAL AND DETAILED DESIGN.

REV	DATE	DESCRIPTION	DWN	CHK	APP
P03	08.02.22	CFI RESPONSE		FJVRUM	
P02	17.09.21	ISSUED FOR TENDER		FJVRUM	
P01	02.02.22	ISSUED FOR APPROVAL		FJVRUM	
REV	DATE	DESCRIPTION		DWN	CHK APP

Key:

Project: EQUINIX DB081

Drawing Title: SUDS DETAILS

Drawing Number: DB080-PIN-00-ZZ-DR-C-PLAN-1296

Scale: 1:500 Paper Size: A1 Purpose: D2 Revision: P03

PINNACLE CONSULTING ENGINEERS

SIXTH FLOOR PROSPECT HOUSE, 100 NEW OXFORD STREET LONDON WC1A 1HB Tel: 0207 0433410