




LEGEND:

- PROPOSED SURFACE WATER DRAIN
- PROPOSED SURFACE WATER MANHOLE
- PROPOSED ACO CHANNEL DRAIN
- PROPOSED ATTENUATION TANK
- PROPOSED DOWNPIPE FROM GROUND FLOOR ABOVE
- PROPOSED GULLY
- PROPOSED DN80 SURFACE WATER RISING MAIN
- EXTENT OF PROPOSED DEVELOPMENT

NOTES:

1. REFER TO DRAWING NO. 202253-PUNCH-XX-XX-DR-C-0100 FOR GROUND FLOOR DRAINAGE LAYOUT.
2. REFER TO DRAWING NO. 202253-PUNCH-XX-XX-DR-C-0100 FOR PROPOSED MANHOLE AND PIPE SCHEDULES.

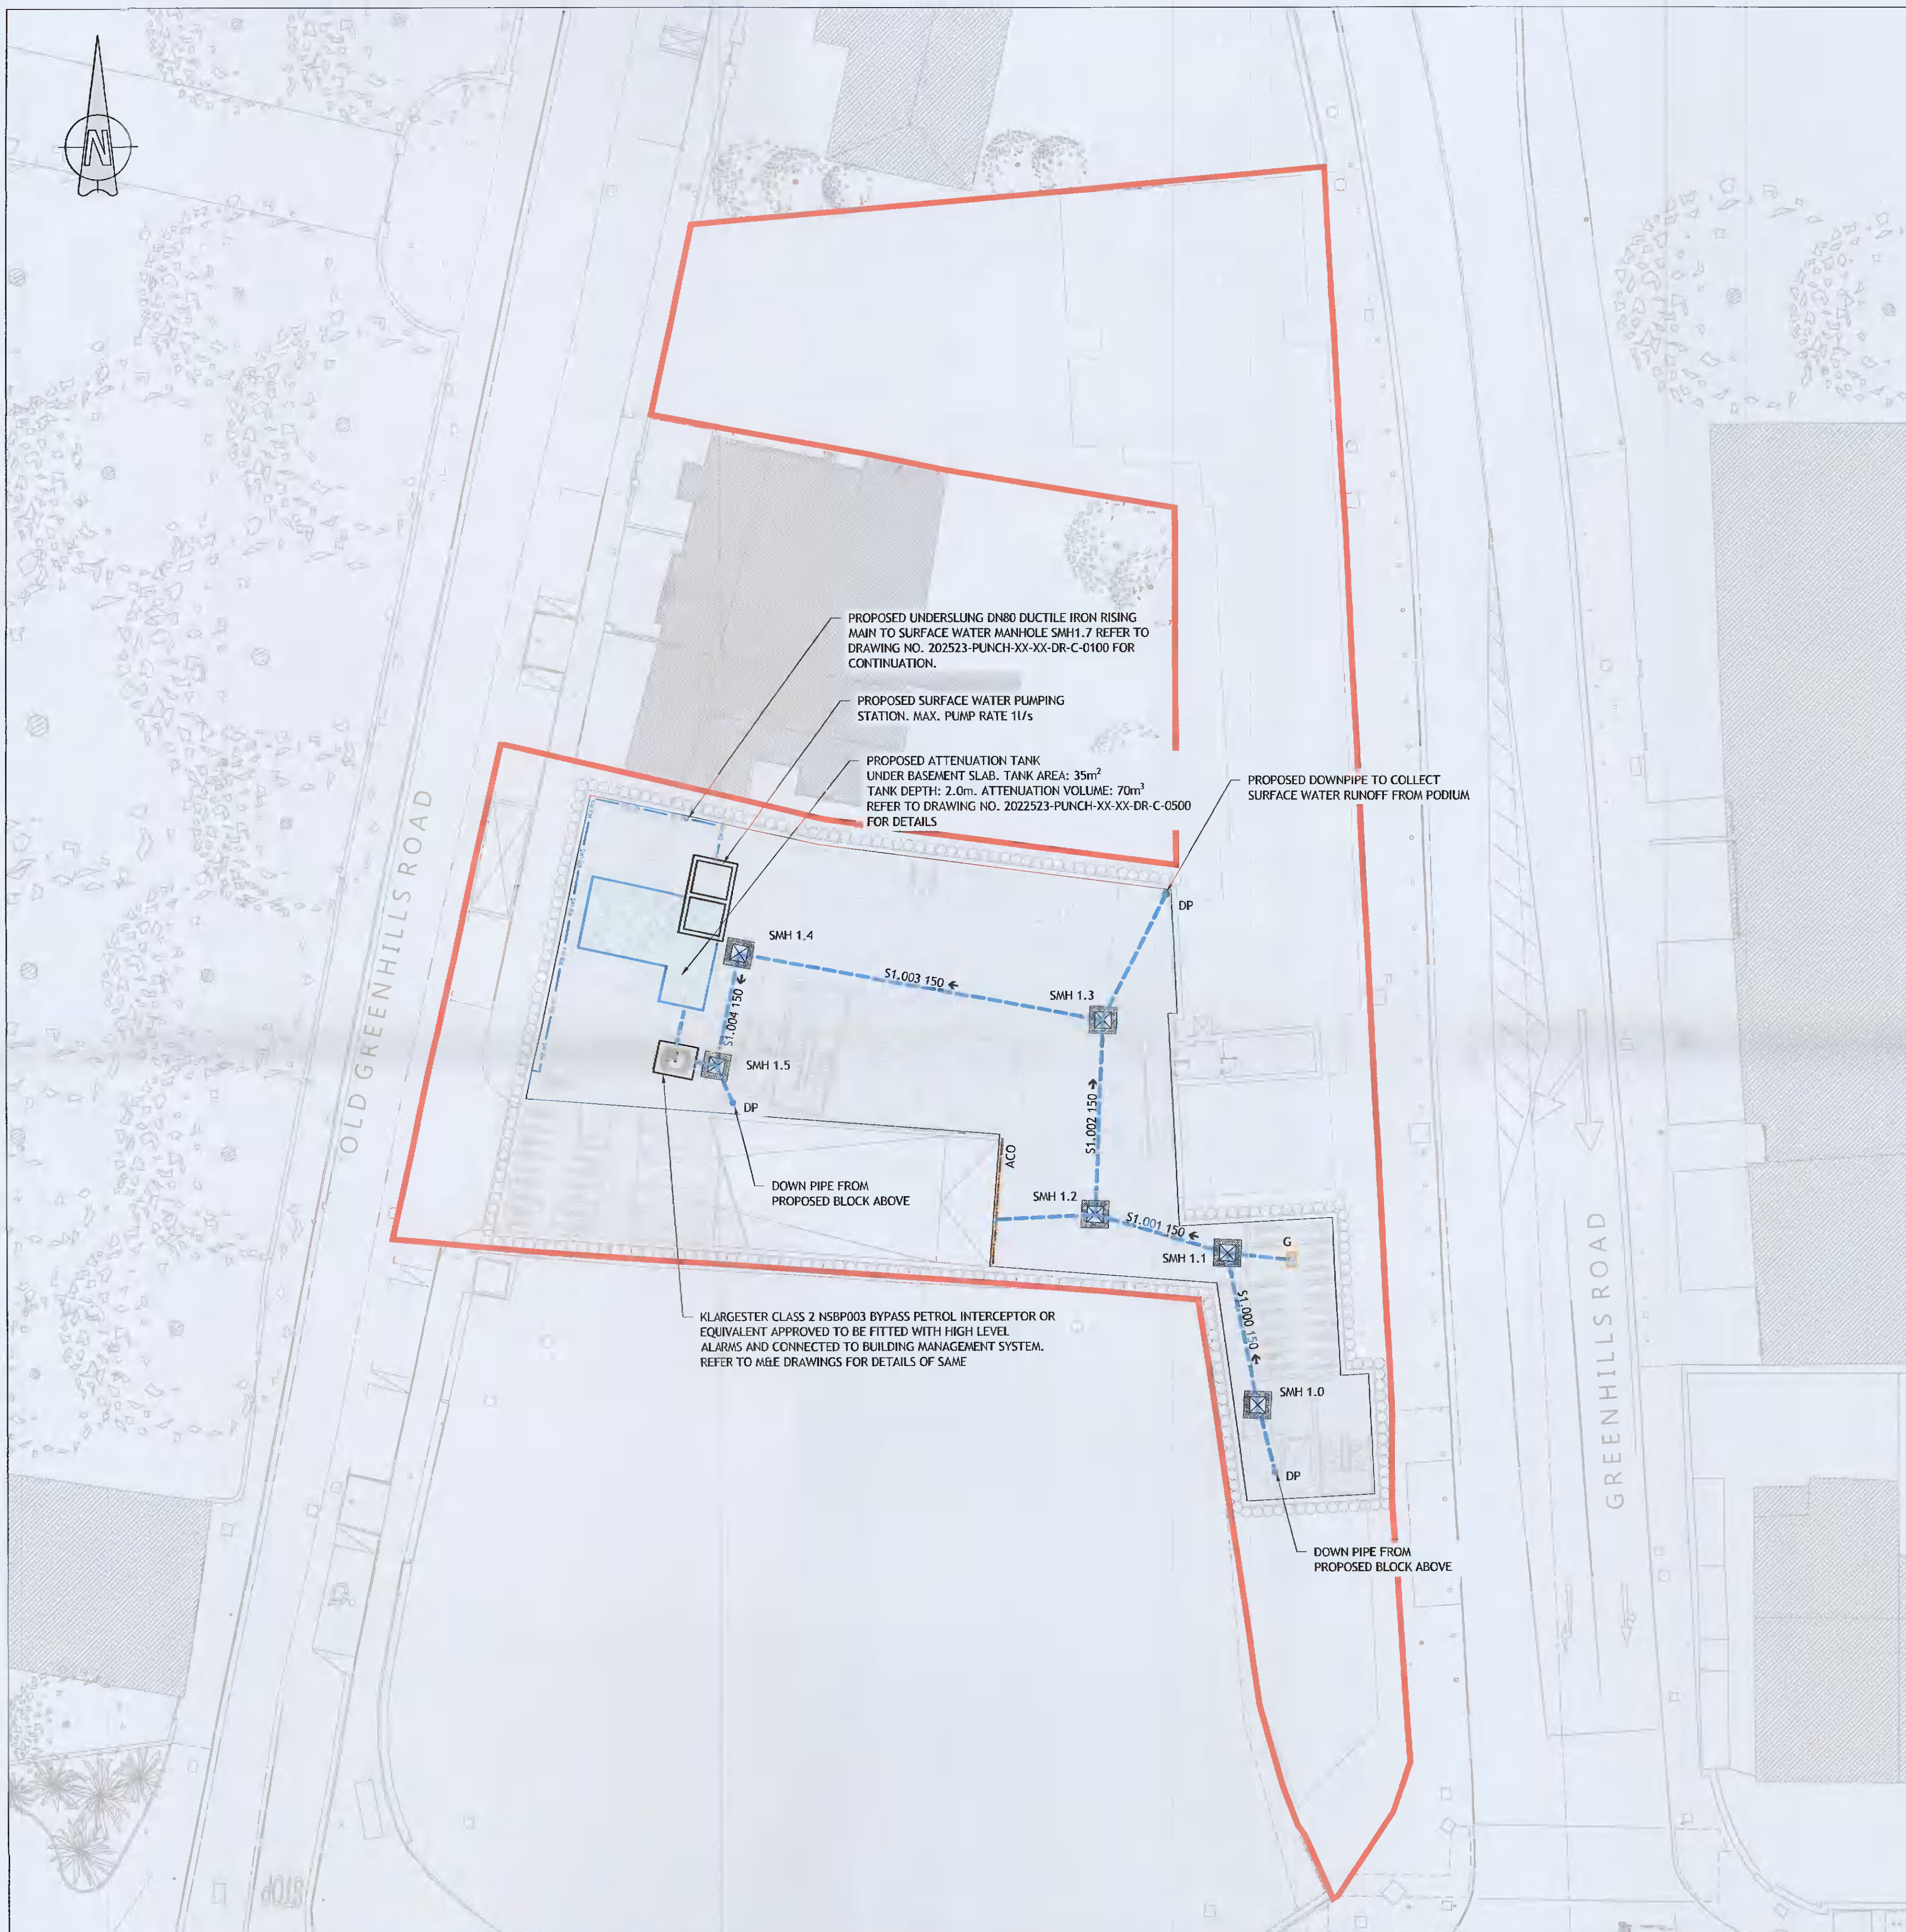

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 Consultants to be informed immediately of any discrepancies before work proceeds.
 COLOUR DRAWING



Rev	Amendment	By	Date	Rev	Amendment	By	Date
C01	PLANNING ISSUE	IBS	14/05/2021				
C02	FI RESPONSE	DAP	04/11/2021				

Rev	Amendment	By	Date

Client:



Project: GREENHILLS ROAD DEVELOPMENT, TALLAGHT, DUBLIN 24			
Title: PROPOSED BASEMENT DRAINAGE LAYOUT			
Drawn: IBS	Date: MARCH 2021	Technician Check: IBS	Engineer Check: MR
Project No: 202253	Model No: 202253-PUNCH-XX-XX-N2-C-0101	Drawn Status: AO PLANNING	Scale: 1:200
Date: 202253-PUNCH-XX-XX-DR-C-0101			Revision No: C02