




EXISTING FRONT ELEVATION
(SCALE 1:50)

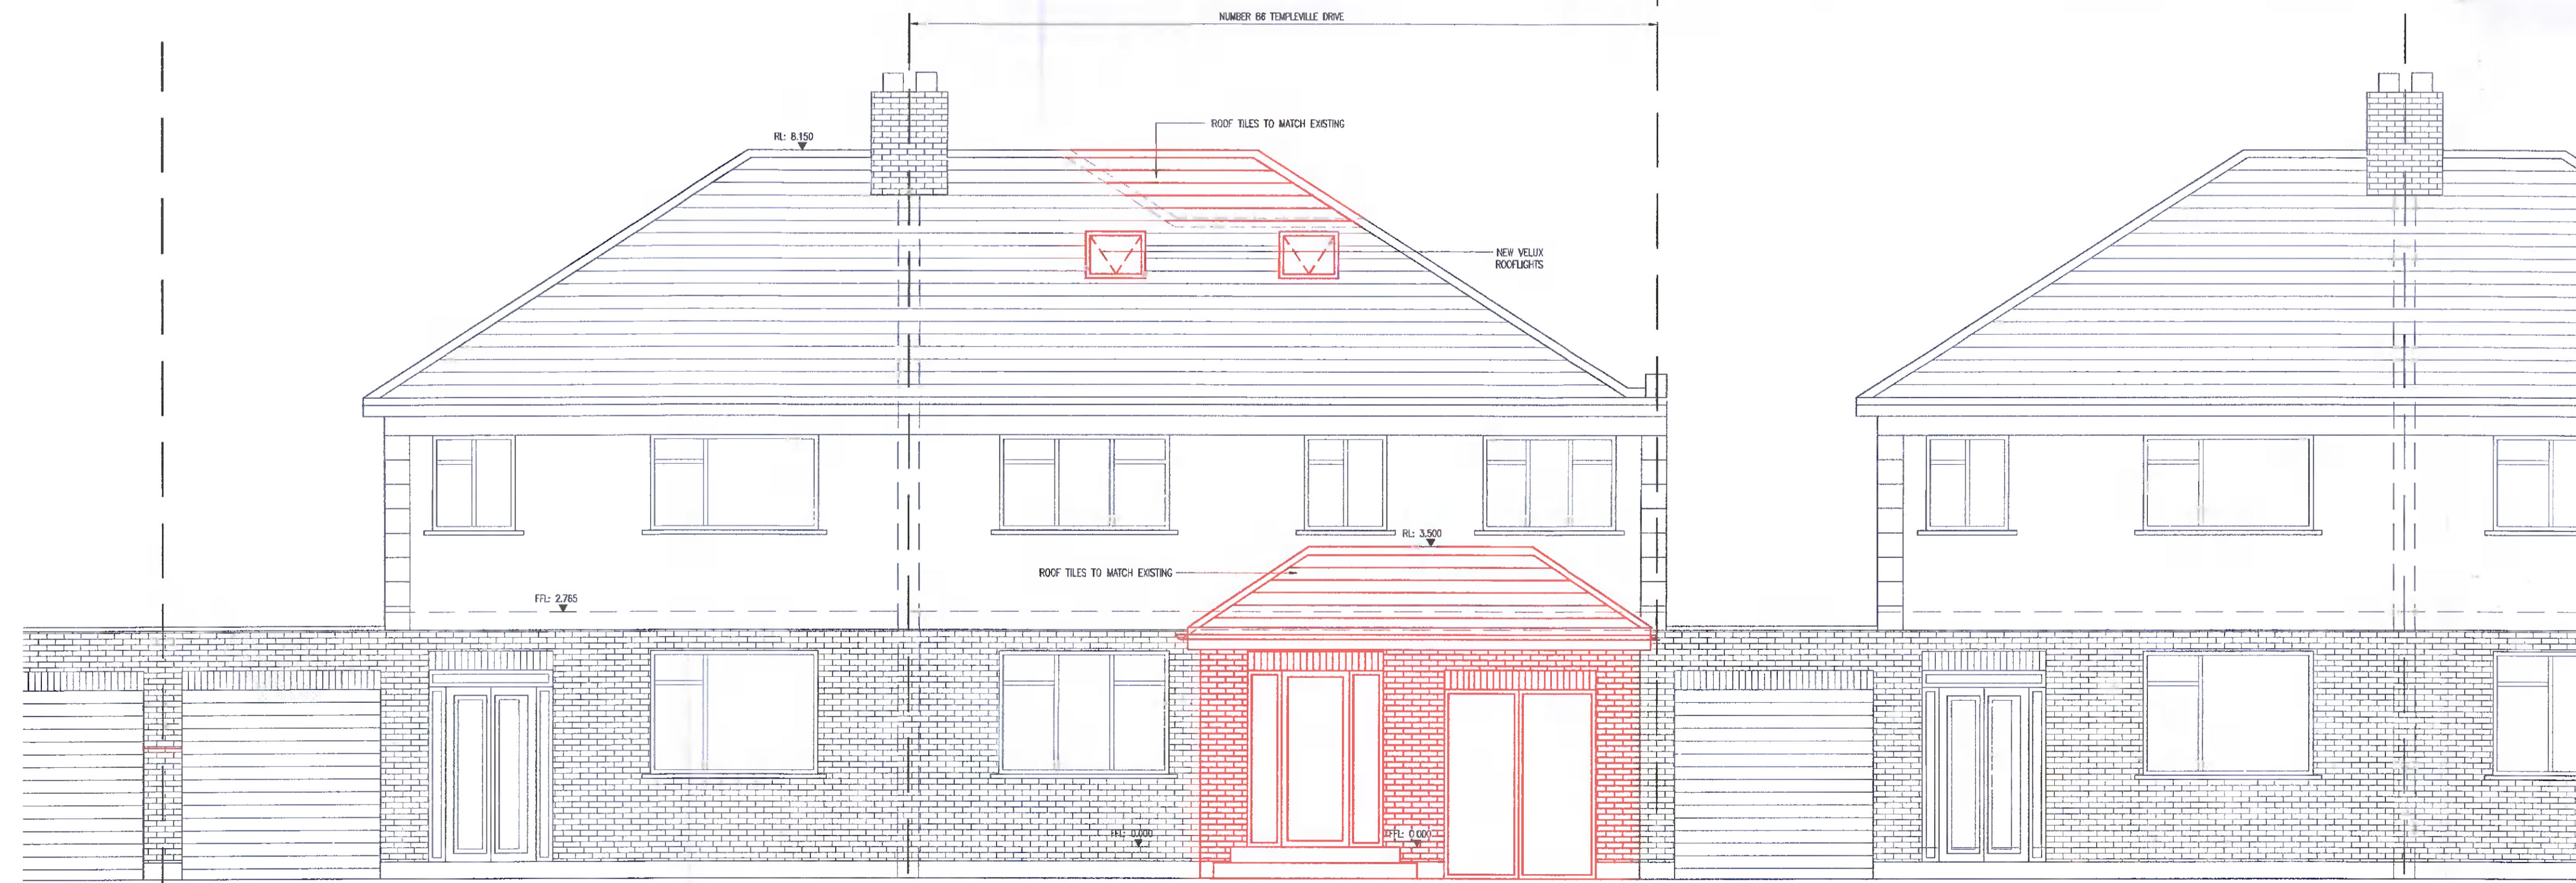

PROPOSED FRONT ELEVATION
(SCALE 1:50)

1. FIGURED DIMENSIONS ONLY TO BE TAKEN FROM THIS DRAWING. ALL DIMENSIONS TO BE CHECKED ON SITE.
2. ALL LEVELS RELATE TO DATUM 0.000m ON THE GROUND FLOOR F.F.L (F.F.L = T.B.C.)
3. ALL FOUNDATIONS TO BE TAKEN DOWN ONTO SOLID GROUND & TO BE AGREED WITH THE ENGINEER ON SITE. THE DEPTH OF THE LEAN MIX CONCRETE UNDER THE FOUNDATIONS WILL BE ADJUSTED ACCORDINGLY.
4. BLOCKWORK: BLOCKWORK TO BE 7 N/mm² THROUGHOUT
5. CONCRETE GRADES IN ACCORDANCE WITH IS EN 206-1:2002:

	COMPRESSIVE STRENGTH CLASS	MAX. NOMINAL UPPER AGG. SIZE	SUMP CLASS	EXPOSURE CLASS
FOUNDATIONS	C28/35	D20	S2	XC2
GROUND FLOOR SLAB	C28/35	D20	S2	XC1
LEAN MIX UNDER FND	C8/10	D20	S2	XC2
SCREED	C28/35	D10	S2	XC1
ROOF SLAB	C28/35	D20	S2	XC1

6. REFER TO ARCHITECTS DRAWING FOR BLOCKWORK SETTING OUT WHERE THEY ARE NOT INDICATED ON THESE DRAWINGS

Rev.	Date	Drawn By	Checked By	Revision

Status
FOR PLANNING

Client
VINA KESSOPERSADH

Project
86 TEMPLEVILLE DRIVE

Drg. Title
EXISTING AND PROPOSED FRONT ELEVATION

ETG CONSULTING STRUCTURAL ENGINEERS LTD.
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Drawn By	EG	Scale	AS SHOWN
Checked By	EG	Date	11.05.21
Drg.No.	E1045 - 106	Rev.	-