

1. FIGURED DIMENSIONS ONLY TO BE TAKEN FROM THIS DRAWING. ALL DIMENSIONS TO BE CHECKED ON SITE.
2. ALL LEVELS RELATE TO DATUM 0.000m ON THE GROUND FLOOR F.F.L (F.F.L. = T.B.C.)
3. ALL FOUNDATIONS TO BE TAKEN DOWN ONTO SOLID GROUND & TO BE AGREED WITH THE ENGINEER ON SITE. THE DEPTH OF THE LEAN MIX CONCRETE UNDER THE FOUNDATIONS WILL BE ADJUSTED ACCORDINGLY.
4. BLOCKWORK: BLOCKWORK TO BE 7 N/mm<sup>2</sup> THROUGHOUT
5. CONCRETE GRADES IN ACCORDANCE WITH IS EN 206-1:2002:

	COMPRESSIVE STRENGTH CLASS	MAX. NOMINAL UPPER AGG. SIZE	SLOPE EXPOSURE CLASS	CLASS
FOUNDATIONS	C28/35	D20	S2	XC2
GROUND FLOOR SLAB	C28/35	D20	S2	XC1
LEAN MIX UNDER FND.	C8/10	D20	S2	XC2
SCREED	C28/35	D10	S2	XC1
ROOF SLAB	C28/35	D20	S2	XC1

6. REFER TO ARCHITECTS DRAWING FOR BLOCKWORK SETTING OUT WHERE THEY ARE NOT INDICATED ON THESE DRAWINGS

Rev.	Date	Drawn By	Checked By	Revision

Status  
**FOR PLANNING**

Client  
**VINA KESSOPERSADH**

Project  
**86 TEMPLEVILLE DRIVE**

Drg. Title  
**EXISTING AND PROPOSED REAR ELEVATIONS**


**ETG CONSULTING STRUCTURAL ENGINEERS LTD.**

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Drawn By	EG	Scale	AS SHOWN
Checked By	EG	Date	11.05.21
Drg.No.	E1045 - 107	Rev.	-



**EXISTING REAR ELEVATION**  
(SCALE 1:50)

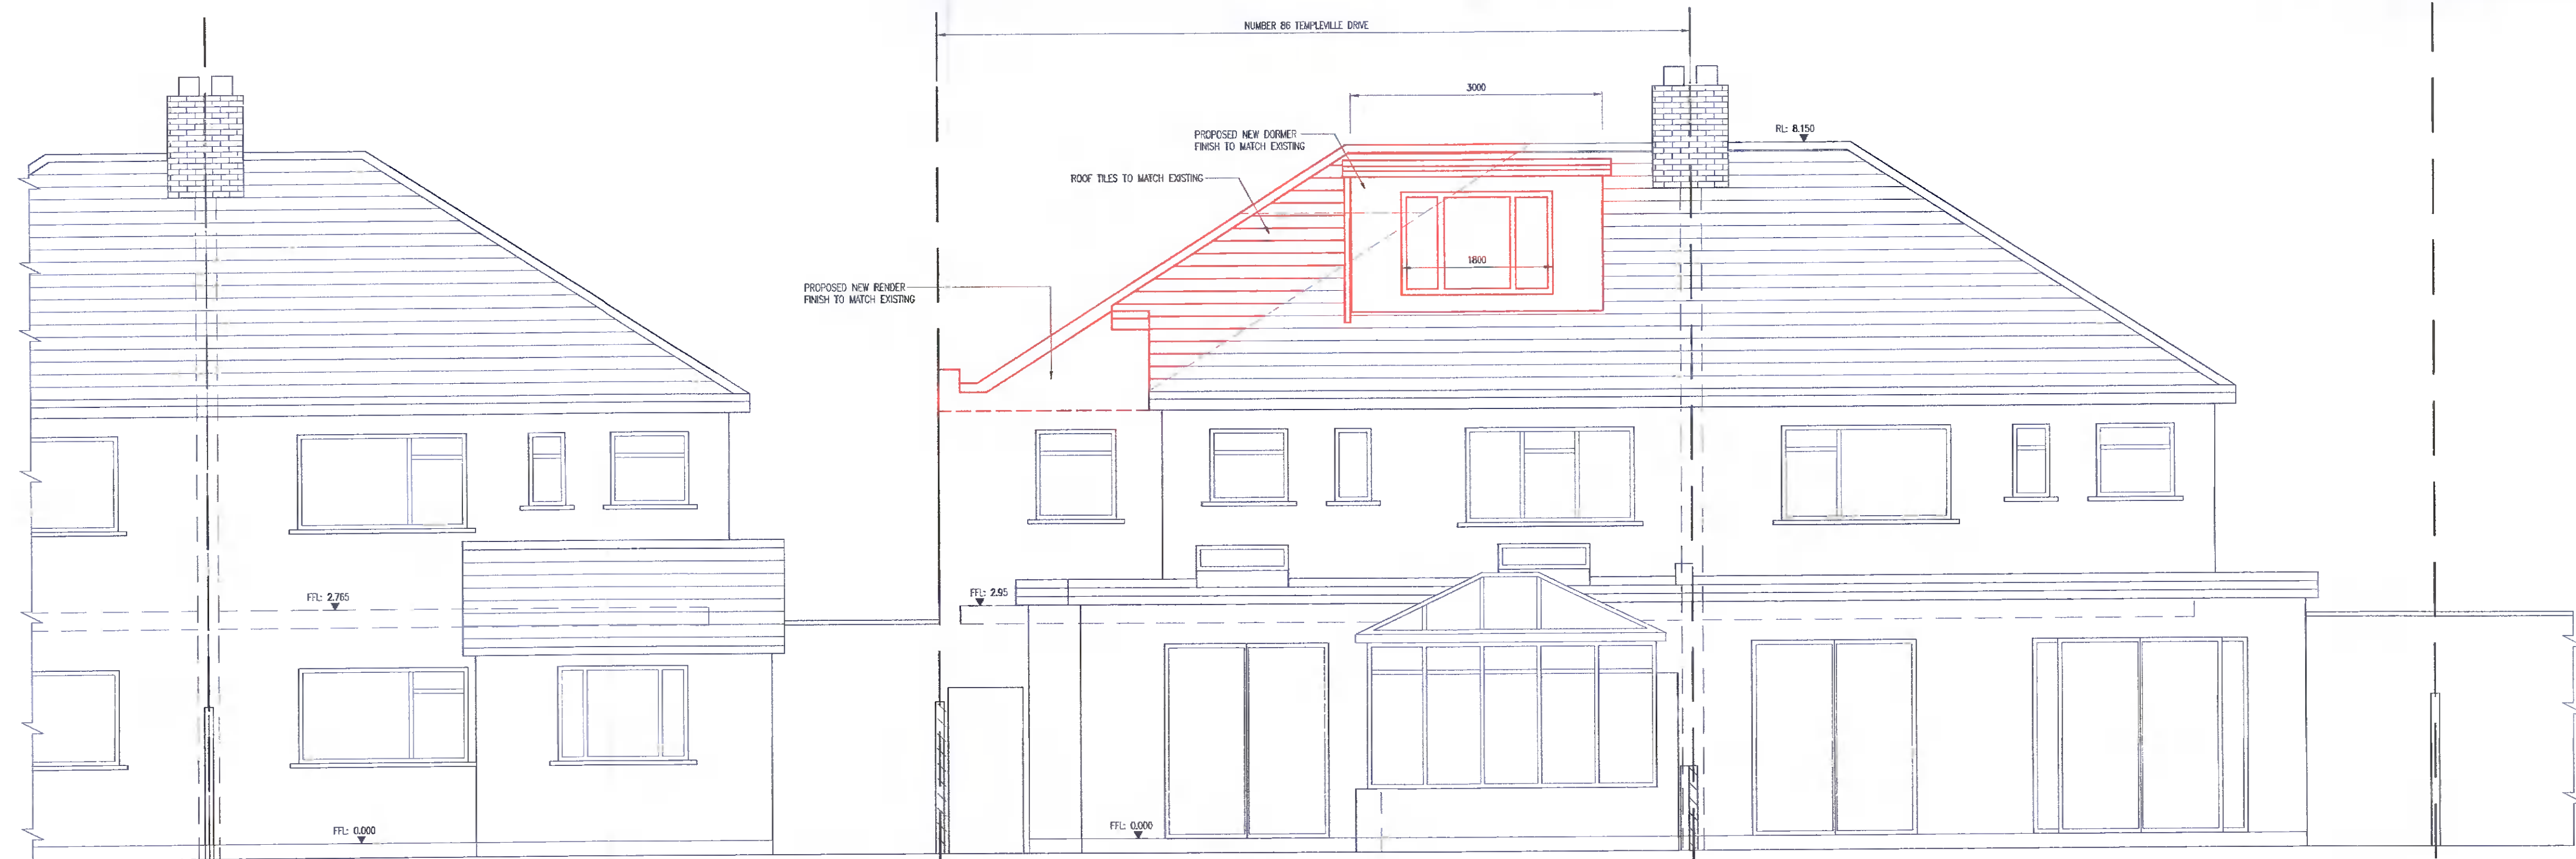

**PROPOSED REAR ELEVATION**  
(SCALE 1:50)