


RECOMMISSIONING OF SEWER PIPES SHALL BE BY THE FOLLOWING PROCEDURE FOR RECOMMISSIONING:

- ALL EXISTING AND PROPOSED SEWER PIPES TO BE REMOVED FROM THE RECOMMENDATION RANGE(S) BY AN APPROVED CONTRACTOR.
- ONCE THE TANK IS PUMPED OUT THE TANK AND APPROVED DUMP SITES, AGRICULTURAL LAND TO DESIGNER AND REPAIR/REPLACE THE TANK.
- THE TANK WILL BE FULLY REPAIRED WITH A RECONSTITUTED SOIL (REFER TO PREVIOUS PREPARATION, FLOW PAPER FROM THE NEW PROPOSED COORDINATE) AND THE SOIL REPLACED WITH A RECONSTITUTED SOIL (REFER TO PREVIOUS PREPARATION, FLOW PAPER FROM THE NEW PROPOSED COORDINATE) AND THE SOIL REPLACED WITH A RECONSTITUTED SOIL (REFER TO PREVIOUS PREPARATION, FLOW PAPER FROM THE NEW PROPOSED COORDINATE).
- THE TANK WILL BE FULLY REPAIRED WITH A RECONSTITUTED SOIL (REFER TO PREVIOUS PREPARATION, FLOW PAPER FROM THE NEW PROPOSED COORDINATE) AND THE SOIL REPLACED WITH A RECONSTITUTED SOIL (REFER TO PREVIOUS PREPARATION, FLOW PAPER FROM THE NEW PROPOSED COORDINATE).
- THE TANK WILL BE FULLY REPAIRED WITH A RECONSTITUTED SOIL (REFER TO PREVIOUS PREPARATION, FLOW PAPER FROM THE NEW PROPOSED COORDINATE) AND THE SOIL REPLACED WITH A RECONSTITUTED SOIL (REFER TO PREVIOUS PREPARATION, FLOW PAPER FROM THE NEW PROPOSED COORDINATE).

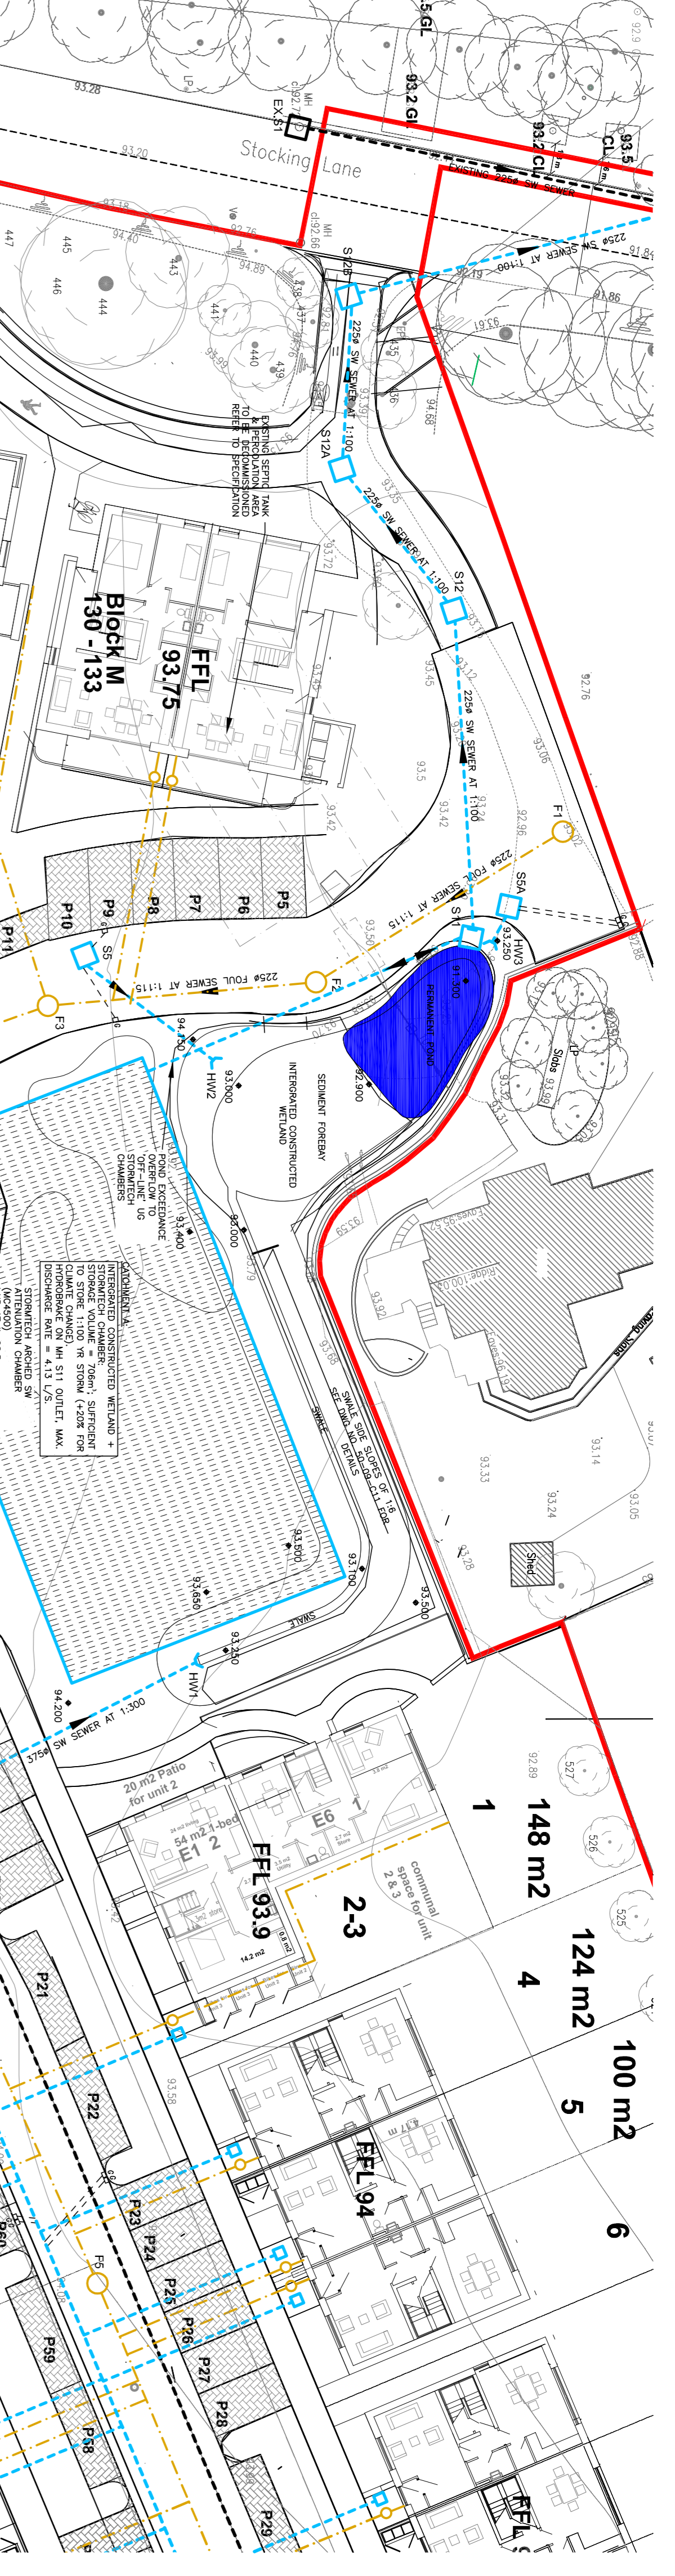

NOTES

1. ALL FOUL SEWERS ARE TO BE CONCRETE CONCRETE SEWER PIPES WITH SPIGOT AND SOCKET JOINTS AND RUBBER RING FITTINGS SHALL COMPLY WITH IS EN 1916 (2002), BS 5911, PART 1 (2002 - 2010) AND BS 5911-2 (2002 - 2010). ALL PIPES AND FITTINGS SHALL HAVE GASKET TYPE JOINTS OF SPIGOT AND SOCKET OR REBATED FORK PIPE DIAMETERS (REFER AND ABOVE)

DRAINAGE LEGEND:

- PROPOSED SURFACE WATER PIPE
- PROPOSED SURFACE WATER MANHOLE
- PROPOSED ROAD GUTTER
- PROPOSED SW HEADWALL
- EXISTING SURFACE WATER PIPE
- EXISTING SURFACE WATER MANHOLE
- EXISTING SURFACE WATER PIPE
- PROPOSED FOUL WATER PIPE
- PROPOSED FOUL WATER MANHOLE
- EXISTING FOUL PIPE
- EXISTING FOUL MANHOLE
- PERMEABLE PAVING

SOIL BENCHMARK

NAME	CL	EL	L	DIST	FULL	PIPE	DEPTH
S1	64.800	91.195	1.00	1.00	2.00	1.80	1.80
S2	64.800	91.195	1.00	1.00	2.00	1.80	1.80
S3	64.800	91.195	1.00	1.00	2.00	1.80	1.80
S4	64.800	91.195	1.00	1.00	2.00	1.80	1.80
S5	64.800	91.195	1.00	1.00	2.00	1.80	1.80
S6	64.800	91.195	1.00	1.00	2.00	1.80	1.80
S7	64.800	91.195	1.00	1.00	2.00	1.80	1.80
S8	64.800	91.195	1.00	1.00	2.00	1.80	1.80
S9	64.800	91.195	1.00	1.00	2.00	1.80	1.80
S10	64.800	91.195	1.00	1.00	2.00	1.80	1.80
S11	64.800	91.195	1.00	1.00	2.00	1.80	1.80
S12	64.800	91.195	1.00	1.00	2.00	1.80	1.80
S13	64.800	91.195	1.00	1.00	2.00	1.80	1.80
S14	64.800	91.195	1.00	1.00	2.00	1.80	1.80
S15	64.800	91.195	1.00	1.00	2.00	1.80	1.80
S16	64.800	91.195	1.00	1.00	2.00	1.80	1.80
S17	64.800	91.195	1.00	1.00	2.00	1.80	1.80
S18	64.800	91.195	1.00	1.00	2.00	1.80	1.80
S19	64.800	91.195	1.00	1.00	2.00	1.80	1.80
S20	64.800	91.195	1.00	1.00	2.00	1.80	1.80
S21	64.800	91.195	1.00	1.00	2.00	1.80	1.80
S22	64.800	91.195	1.00	1.00	2.00	1.80	1.80
S23	64.800	91.195	1.00	1.00	2.00	1.80	1.80
S24	64.800	91.195	1.00	1.00	2.00	1.80	1.80
S25	64.800	91.195	1.00	1.00	2.00	1.80	1.80
S26	64.800	91.195	1.00	1.00	2.00	1.80	1.80
S27	64.800	91.195	1.00	1.00	2.00	1.80	1.80
S28	64.800	91.195	1.00	1.00	2.00	1.80	1.80
S29	64.800	91.195	1.00	1.00	2.00	1.80	1.80
S30	64.800	91.195	1.00	1.00	2.00	1.80	1.80
S31	64.800	91.195	1.00	1.00	2.00	1.80	1.80
S32	64.800	91.195	1.00	1.00	2.00	1.80	1.80
S33	64.800	91.195	1.00	1.00	2.00	1.80	1.80
S34	64.800	91.195	1.00	1.00	2.00	1.80	1.80
S35	64.800	91.195	1.00	1.00	2.00	1.80	1.80
S36	64.800	91.195	1.00	1.00	2.00	1.80	1.80
S37	64.800	91.195	1.00	1.00	2.00	1.80	1.80
S38	64.800	91.195	1.00	1.00	2.00	1.80	1.80
S39	64.800	91.195	1.00	1.00	2.00	1.80	1.80
S40	64.800	91.195	1.00	1.00	2.00	1.80	1.80

Client MCCABE DURNAY BARRIES

Project Title HOUSING DEVELOPMENT AT STOCKING LANE, BALLBOODEN DUBLIN 16

Drawing Title FOUL & SW DRAINAGE LAYOUT PLAN SHEET 1 OF 2

Architect MATT BARNES

Scale 1:250(A3)

Date JUNE 2017

DRAWN A. WATSON

CHECKED C. O'CONNOR

Rev | Description | Date

AD	07.09.21	NEW LAYOUT PLAN	AM	COB
AC	28.10.20	SM&E SECTION REVISION 16	AM	COB
AB	12.10.20	NEW LAYOUT, SM&E SECTION REVISION 14	AM	COB
AA	08.09.20	NEW LAYOUT	AM	COB

Drawn MATT BARNES

Checked C. O'CONNOR

Scale 1:250(A3)

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