



PROPOSED SURFACE WATER DRAINAGE LAYOUT
1:500 @ A1

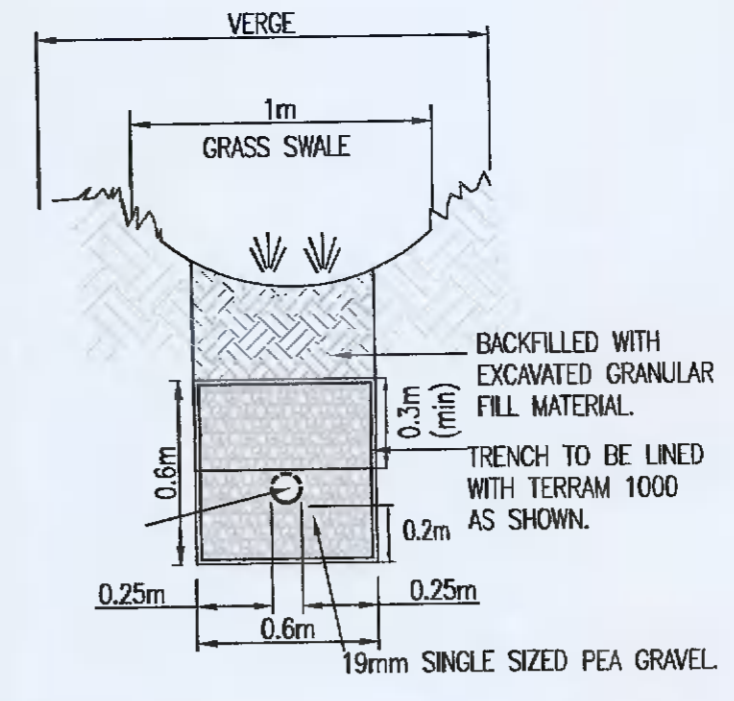

TYPICAL SECTION THROUGH PROPOSED SWALE/ FILTER DRAIN
SCALE 1:25 @ A1

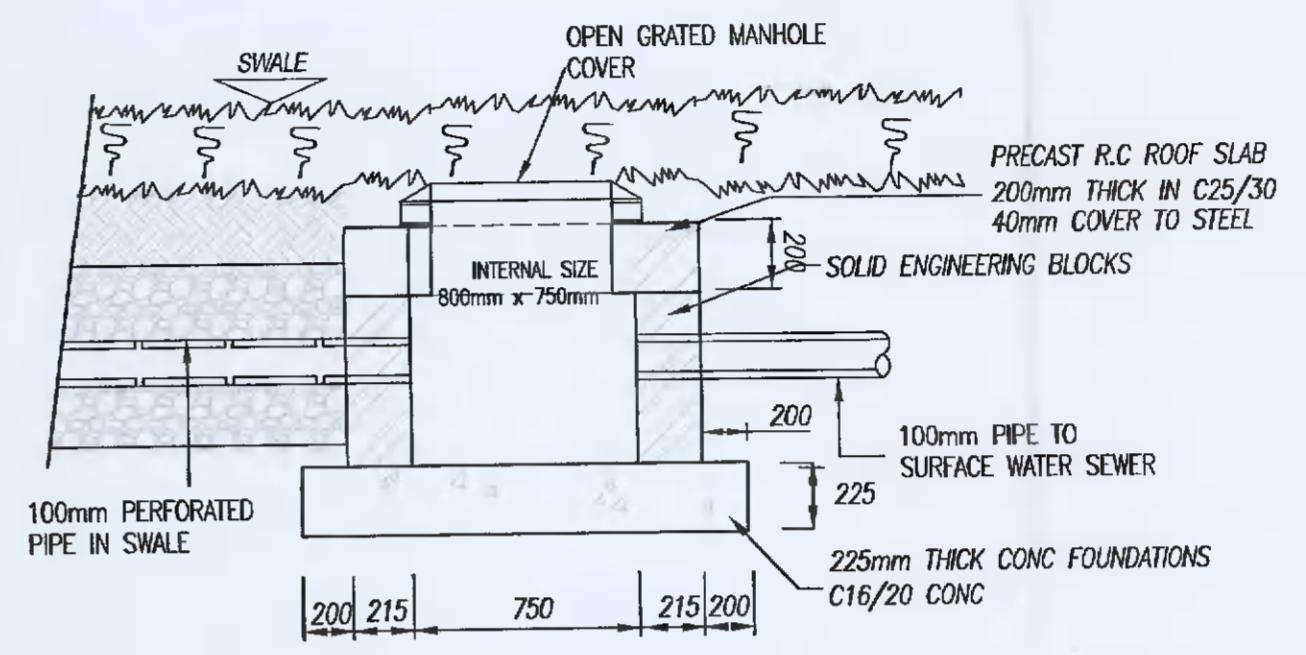


OUTLET MANHOLE IN SWALES

- NOTES:**
- DO NOT SCALE. USE FIGURED DIMENSIONS ONLY.
 - THIS DRAWING IS TO BE READ IN CONJUNCTION WITH ALL OTHER RELEVANT ARCHITECTURAL AND ENGINEERING DRAWINGS.

LEGEND:

LEGEND:

- SITE BOUNDARY
- EXISTING SURFACE WATER SEWER WITH PIPE SIZE, GRADE, MANHOLE REF. AND INVERT LEVEL
- PROPOSED SURFACE WATER SEWER WITH PIPE SIZE, GRADE, MANHOLE REF. AND INVERT LEVEL
- PROPOSED ROAD GULLY
- PROPOSED OUTFALL MANHOLE
- PROPOSED FILTER DRAIN
- PROPOSED CONCRETE CHANNEL
- INDICATES NSBPO03 PETROL INTERCEPTOR

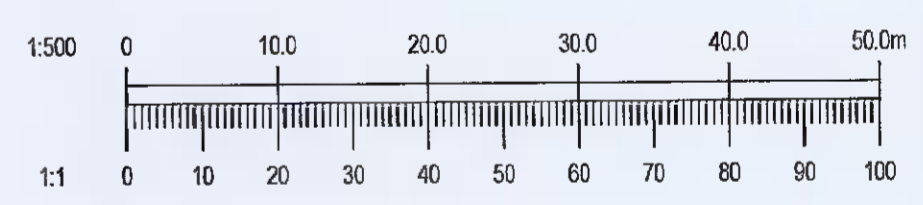

REV.	DATE	AMENDMENT	DRN	APPD

STATUS FOR PLANNING ONLY
NOT FOR CONSTRUCTION

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CLIENT GO-AHEAD IRELAND

ARCHITECT

PROJECT GO-AHEAD BUS DEPOT,
BALLYMOUNT ROAD,
DUBLIN 12

TITLE PROPOSED SURFACE WATER DRAINAGE LAYOUT

DRAWN	DESIGNED	APPROVED	DATE
CF	EN	BG	JULY '21
SCALE	JOB NO.	DRG. NO.	REVISION
1:500 @A1	17-130	P200	

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