



TYPICAL TARMAC ROAD CROSS-SECTION
SCALE 1:20

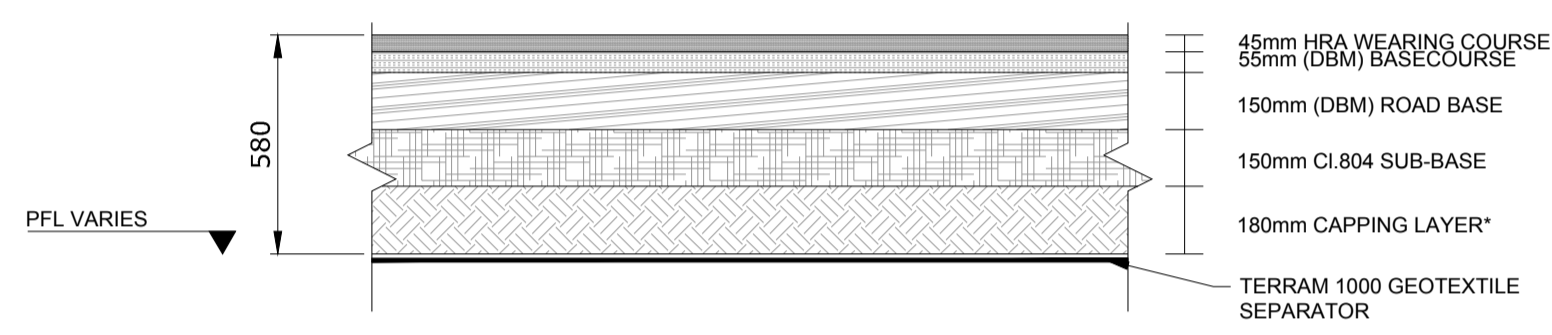


A TYPICAL TARMAC ROAD CONSTRUCTION
SCALE 1:20

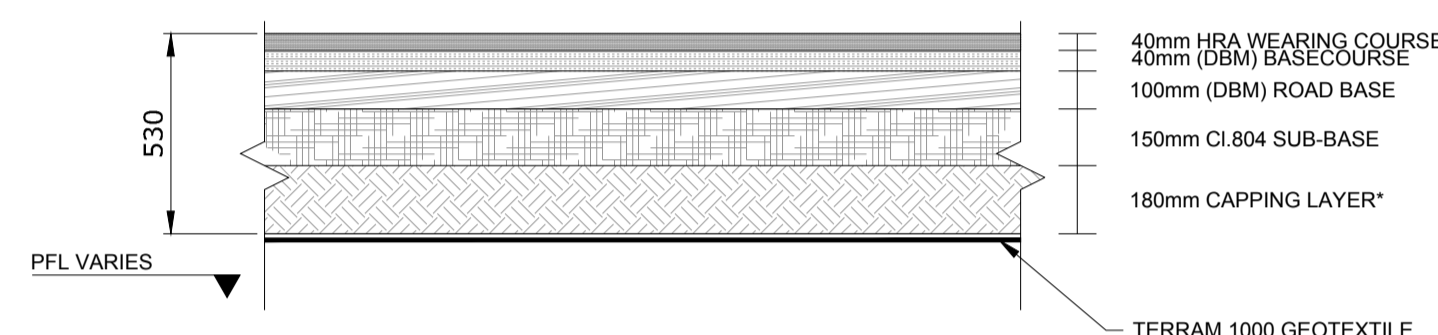

B TYPICAL CARPARK CONSTRUCTION
SCALE 1:20

*NOTE: CAPPING LAYER IS DEPENDENT ON CBR TESTS.

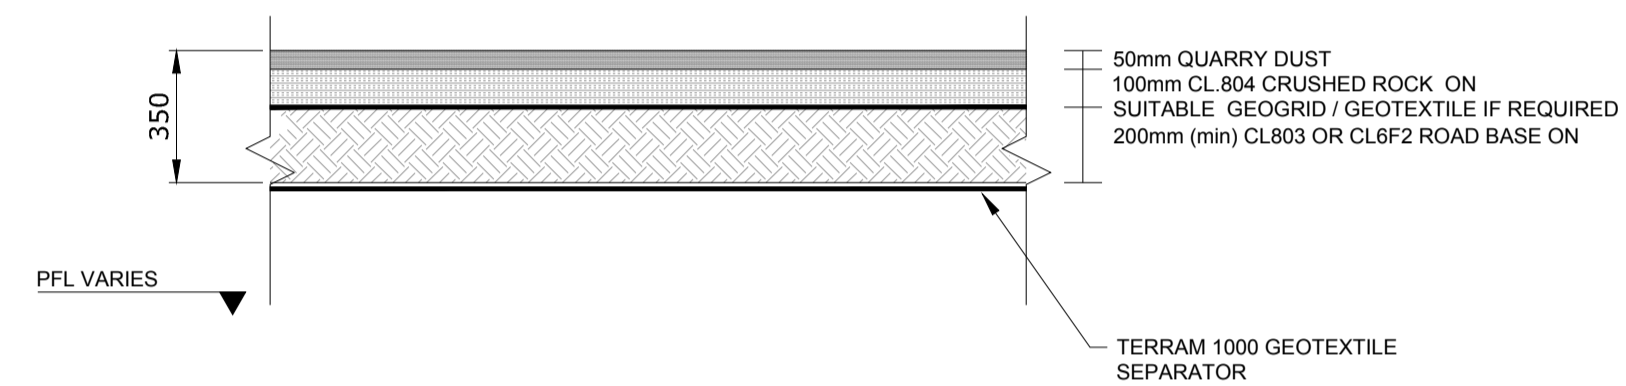

C TYPICAL GRAVEL ROAD CONSTRUCTION
SCALE 1:20

NOTES:

- FIGURED DIMENSIONS ONLY TO BE TAKEN FROM THIS DRAWING.
- ALL DRAWINGS TO BE CHECKED BY THE CONTRACTOR ON SITE.
- ENGINEER/EMPLOYERS REPRESENTATIVE, AS APPROPRIATE, TO BE INFORMED BY THE CONTRACTOR OF ANY DISCREPANCIES BEFORE ANY WORK COMMENCES.
- THE CONTRACTOR SHALL UNDERTAKE A THOROUGH CHECK FOR THE ACTUAL LOCATION OF ALL SERVICES/UTILITIES, ABOVE AND BELOW GROUND, BEFORE ANY WORK COMMENCES.
- ALL LEVELS SHOWN RELATE TO ORDNANCE SURVEY DATUM AT MALIN HEAD.

Rev	Date	Description	By	Chkd.
A	18.06.21	PLANNING ISSUE	MN	MMcC



Project:
PROFILE PARK POWER PLANT

Title:
TYPICAL CAR PARK & ROAD CONSTRUCTION DETAILS

Scale @ A1: **As Shown**

Prepared by: **M. Nolan** Checked: **M. McCarthy** Date: **June 2021**


Project Director: **S. Tinnelly**

Drawing Status: **Planning**

TOBIN
CONSULTING ENGINEERS


Block 10-4, Blanchardstown Corporate Park,
Dublin 15, Ireland.
tel: +353-(0)1-8030406
fax: +353-(0)1-8030409
e-mail: dublin@tobin.ie
www.tobin.ie

Drawing No.: **11069-2020** Revision: **A**

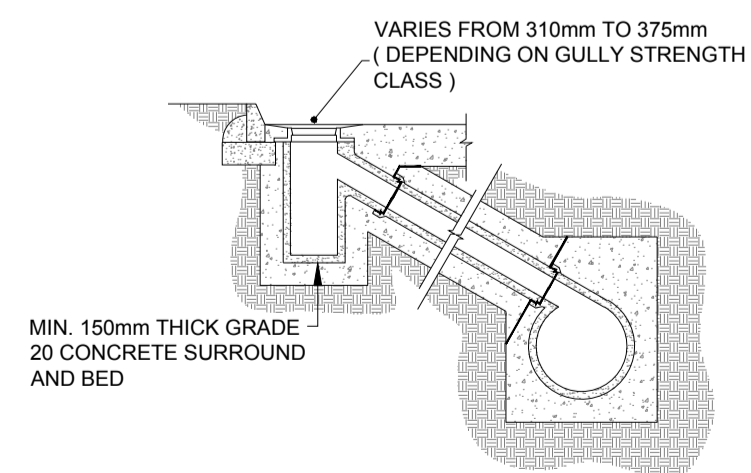


NOTE 1 : TRAPPED GULLIES TO BE USED WHERE CONNECTED TO A COMBINED SEWER
NOTE 2 : FOR STRENGTH CLASS OF GULLY REFER TO EN 124 : 1994, CLAUSE 5

TYPICAL GULLY CONSTRUCTION
SCALE 1:20

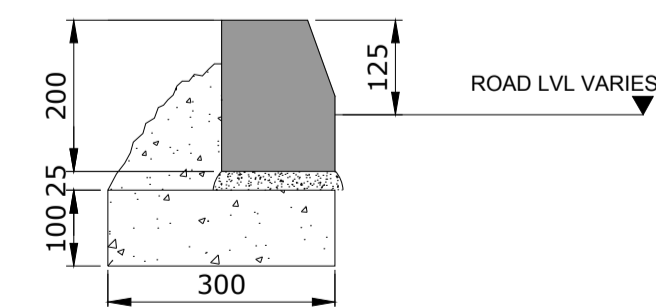

TYPE 2 - EDGE RESTRAINT CARPARK/LIGHT VEHICLES

TYPICAL EDGE RESTRAINT DETAILS
SCALE 1:10

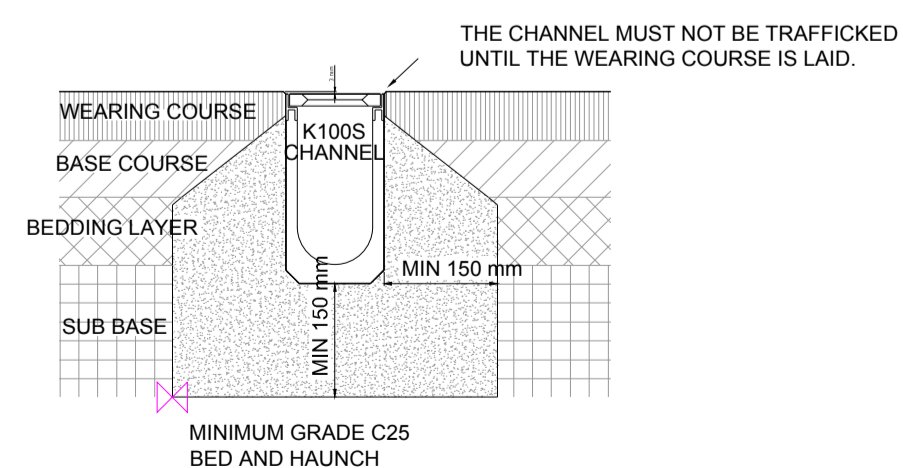

INSTALLATION EXAMPLE FLEXIBLE PAVEMENT
SCALE 1:10