


**LEGEND:**

- PROPOSED SURFACE WATER DRAIN ---
- PROPOSED SURFACE WATER MANHOLE
- PROPOSED ACO CHANNEL DRAIN --- ACO ---
- PROPOSED ATTENUATION TANK
- PROPOSED DOWNPIPE FROM GROUND FLOOR ABOVE ● DP  
G
- PROPOSED GULLY
- PROPOSED DN80 SURFACE WATER RISING MAIN --- SW RM ---
- EXTENT OF PROPOSED DEVELOPMENT ---

**NOTES:**

1. REFER TO DRAWING NO. 202253-PUNCH-XX-XX-DR-C-0100 FOR GROUND FLOOR DRAINAGE LAYOUT.
2. REFER TO DRAWING NO. 202253-PUNCH-XX-XX-DR-C-0100 FOR PROPOSED MANHOLE AND PIPE SCHEDULES.

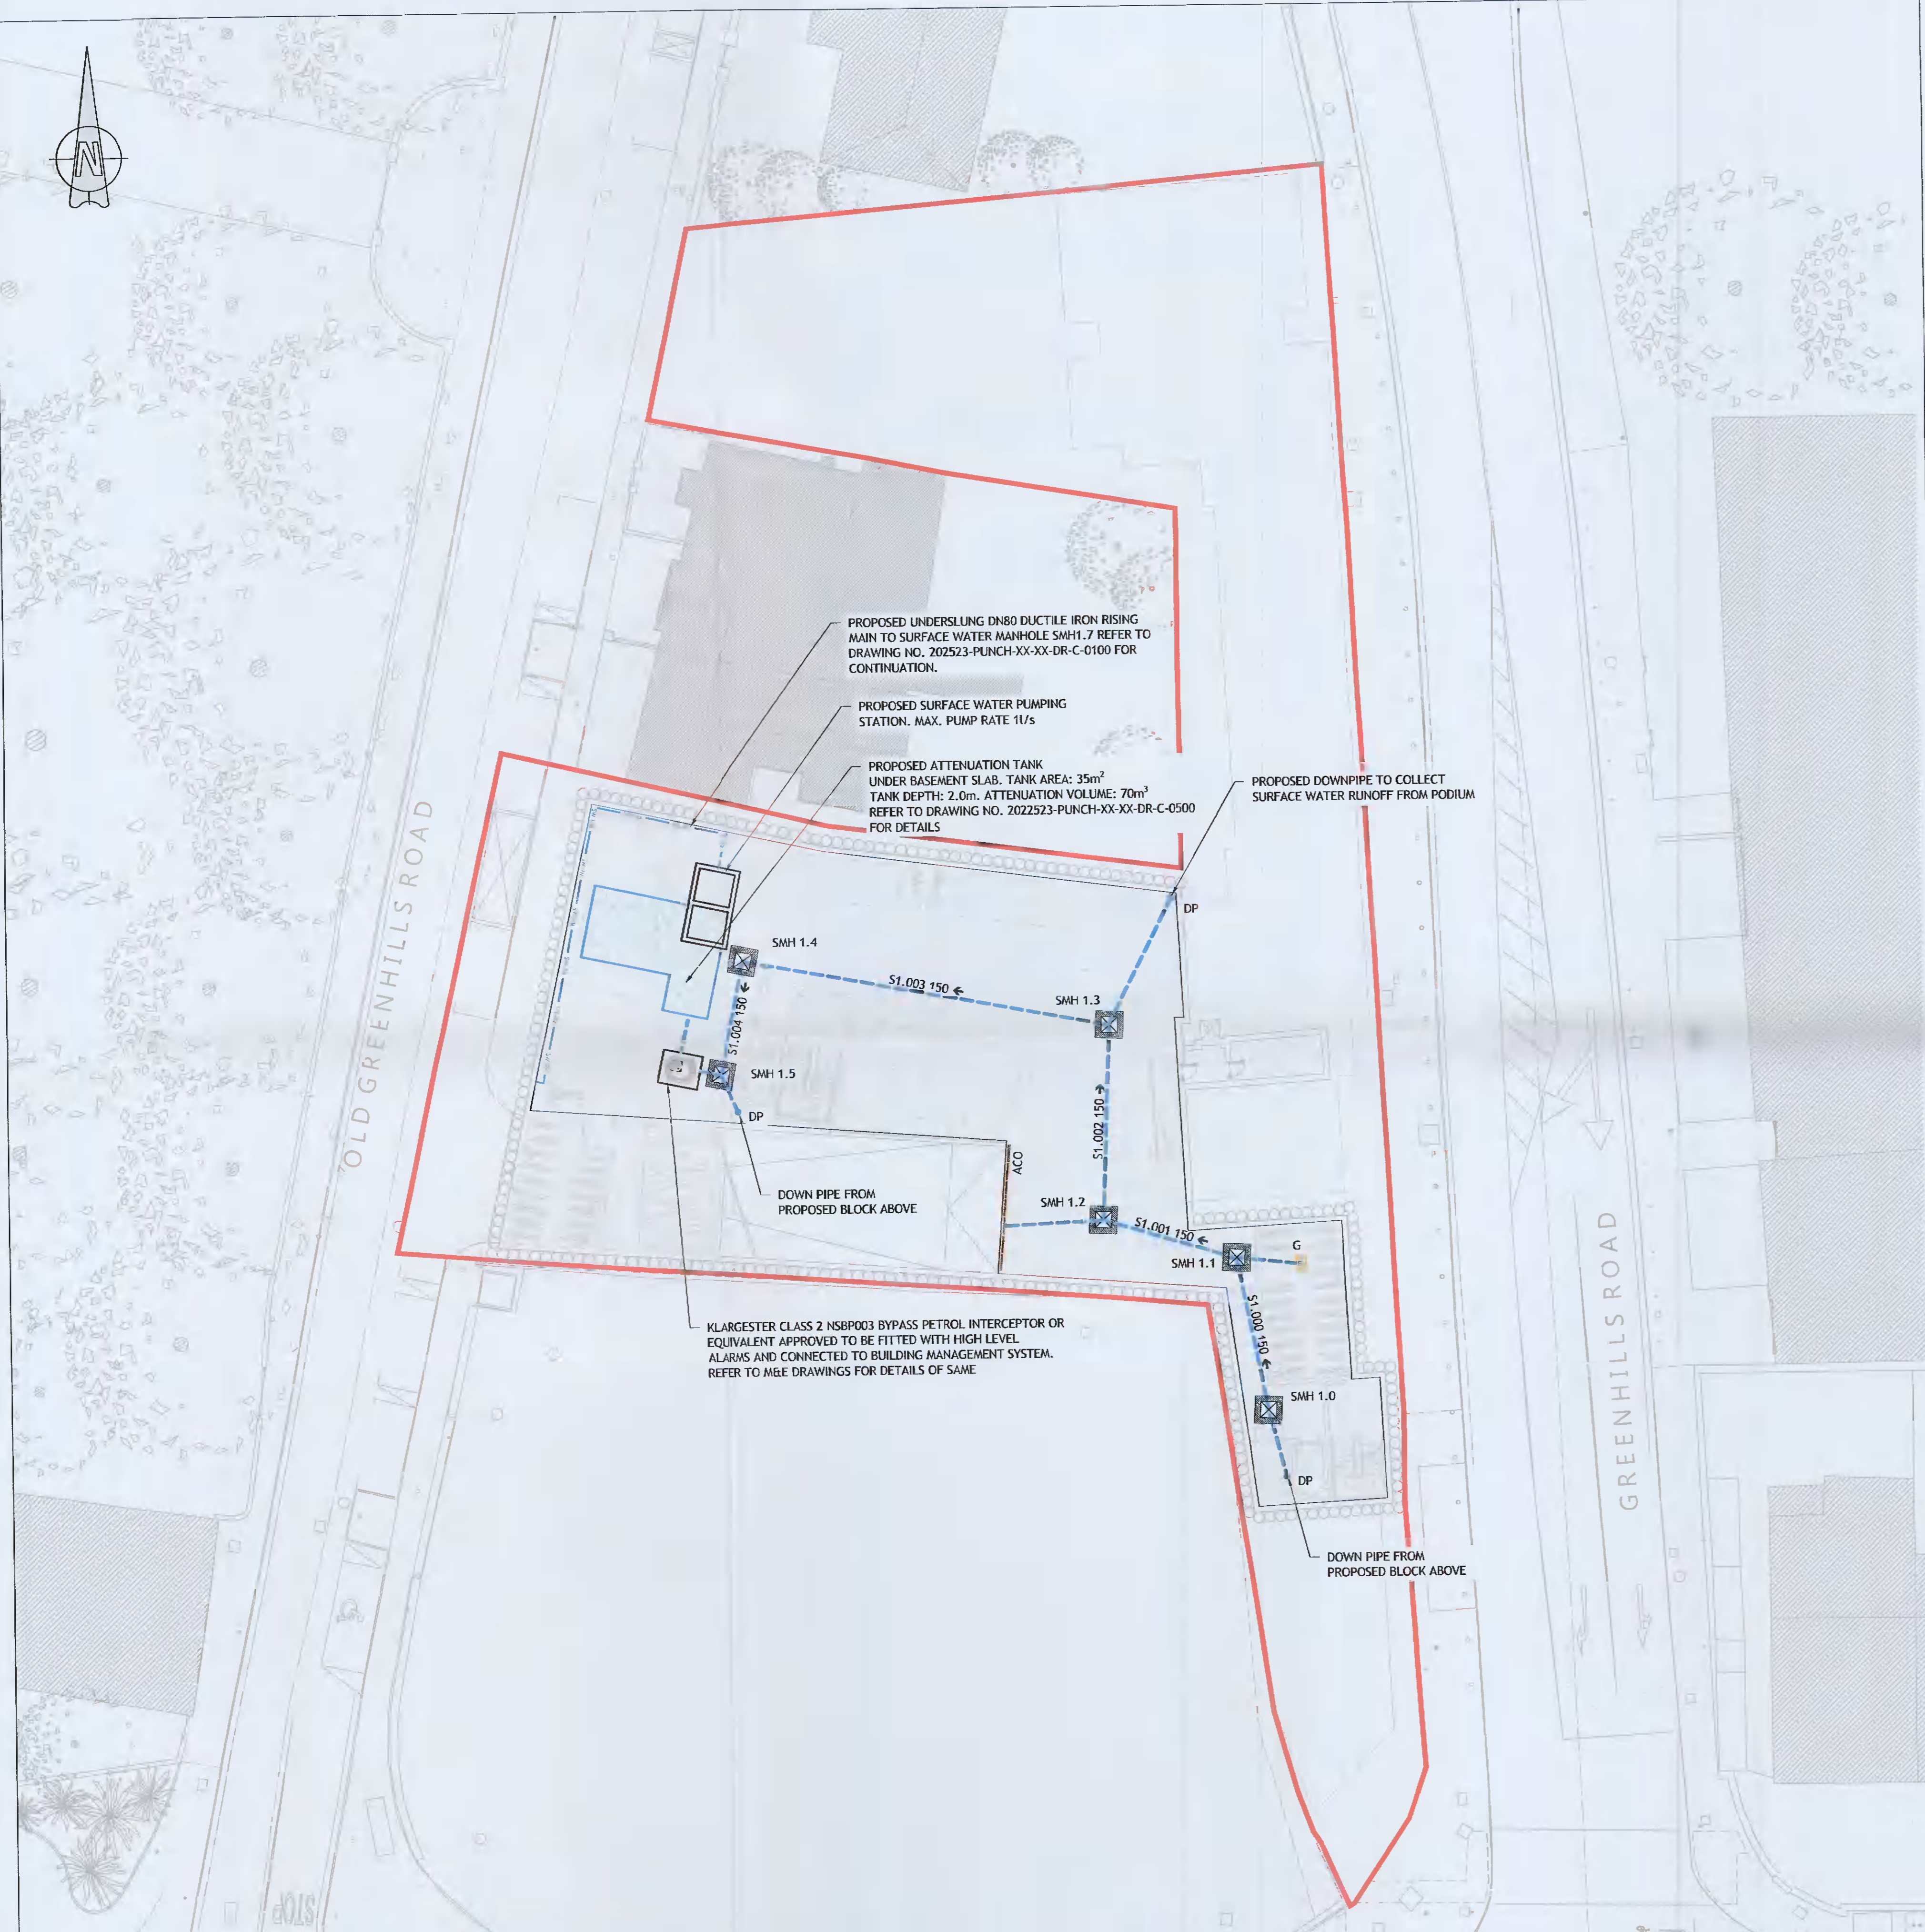

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 Figured dimension only to be taken from this drawing.  
 Consultants to be informed immediately of any discrepancies before work proceeds.



Rev	Amendment	By	Date	Rev	Amendment	By	Date	Client:
CD1	PLANNING ISSUE	IBS	14/05/2021					



Project: GREENHILLS ROAD DEVELOPMENT, TALLAGHT, DUBLIN 24			
Title: PROPOSED BASEMENT DRAINAGE LAYOUT			
Drawn: IBS	Date drawn: MARCH 2021	Technician Check: IBS	Engineer Check: MR
Project No: 202253	Revision: 202253-PUNCH-XX-XX-H2-C-0101	Revision Status: AD PLANNING	Approved:
Scale: 1:200	Doc No: 202253-PUNCH-XX-XX-DR-C-0101	Revision No: C01	