BYE	LM	APPLICATION	FEE

EF. NO.:	914/0995		1 <u></u>	CERTI	FICATE NO.	.: 154	140B
	Extersion to	tadory) USQ 12	<u> </u>		o de espa-	
APPLICANI	,	erryoted	Products 1	Jd			· **
	1	2	3	4	5	6	7
CLASS	DWELLINGS/AREA LENGTH/STRUCTURE	RATE	AMT. OF FEE REQUIRED	AMT. LODGED	BALANCE DUE	RED. FEE APPL.	AMIT, CF PED, FEE
A	Dwelling (Houses/Flats)	@ £55					
	Demochia Ext	a =30]		1

i '			· · · · · · · · · · · · · · · · · · ·	 		
А	Dwelling (Houses/Flats)	@ £55				· · · · · · · · · · · · · · · · · · ·
В	Domestic Ext. (Improvement/ Alts.)	@ £30	A			1
С	Building for office or other comm. purpose	@ £3.50 ; per M ² or £70	763	763		
D	Building or other structure for purposes of agriculture	@ £1.00 per M ² in excess of 300 M ² Min. £70				
E	Petrol Filling Station	@ £200				
F	Dev. of prop. not coming within any of the forgoing classes	£70 or £9 per .1 hect. whichever is the greater				

Column 1 Certified:	Signed:	y y	Grade: D/H	San	:e: <u>21/2</u>	49
	Signed:		Grade:(Dat	20 6	71
Columns 2,3,4,5,6 &	7 Certified:	Signed:	Grade:	3 · O :	Date	
Columns 2,3,4,5,6 &	7 Endorsed:	Signed:	Grade:		Dane. <u> </u>	

lektronik dan karpatak keperta	सम्बद्धाः संभागः च कृत्यम् वेदान्यकः	ky ac property by Sid and Side and second	راي د ادام تا خيمتان ولايتيامه بهتايي بوساخ مدير ا	r de l'ambient de l'Architecture de l'Architectu	2568	γ	, a
91910995	Xtetiou Voes Roo W. Corn	٠ ــــــــــــــــــــــــــــــــــــ	CES.	GIFICATE N			<u>.</u>
.:	X tent 100	to 14	day				
OFOSAL: TOTAL	law Roa	a du	<u>火ンL </u>	-1+d		7) ja 146158 222-23-3-5-	· <u>·</u>
CATION STORY	cen	igated	T KOCU OD			"我就许好是"。 ————————————————————————————————————	T
FLICANT		() 	/	30 5 T			1
		· 175 (图			- 3600	GACT STATEMENT TO A CO.	
		E4T EF	LCDGED.	EALANCE	EXLANCE AND DEED TO THE PERSON OF THE PERSON		3
DHELLINGS/AREA		FEE RES	Coced	, , , <u>, , , , , , , , , , , , , , , , </u>			-
LENGTH/STRUCT	-						
lauriines religion	EE52			न्द्रकृतसम्बद्धाः च			
			Lating Marie 1872				
		1					
1	250p C#T/F						
	EF BOOK			1			
,	Hin.E40 .	A		:]			
. <u>-</u>	 √ <u>2</u> 21.75 per		301.0	d		· ·	:
218.0~~	MF co £45	481.50	381.5	- <u>-</u>			•
2/0:0	-t	. 	1	t		•	:
X .: 57-71	ract. of			[inger H an e jaransae	
						e di Livini	
 	[BEI] PEF					•	
•	rect tr	=	-				
	<u></u> -					+	· -
-	: \$205 pst	•	<u>agilla (.)</u>	- · · · · · · · · · · · · · · · · · · ·			2
,			· · · · · · · · · · · · · · · · · · ·				garan sala Janata
=					0) 		
s t x maires	=						
	್ (ಹಾಗಿ ಫೆ.ವಿ. ವಿ. ೨೭೨ಕ್ಷಿ						
 	<u> </u>						
				ar distriction			₹-1-1- \ \
							100 mm
							武 第二章
		14		7	1	4/4/	71
			22 Z4 ZG	** C - **			1/6/
			SAK KY				1-6-17-1-
		ZEASIONES		C.			Fig. 1
				Maranes V			
2.57 C 55-6	E173Endoss						
企业的基础的							

LOCATION GOVERNMENT (FLANNING AND DEVELOPMENT) ACTS, 1963 TO 1982

ASSESSMENT OF FINANCIAL CONTRIBUTION

ΞS.	FEF.	:	918	1995
-----	------	---	-----	------

DAT. REG.:

ERVICES INVOLVED: WATER/FOUL SEMEN/SURFACE WATER -

FER OF SITE:

LOCK APEA OF FRESENT PROPOSAL: 2347FA

E-STFEED Eff:

HEXED EY:

ETHOD OF ASSESSMENT:

THAL ASSESSMENT

AAAGER'S CROEKED NOW F/ DATED

DITERED IN CONTRIBUTIONS REGISTER:

E.E. OP. P.T. CONTROL ASSISTANT CRAFT

Date: 25th June 1991

PLANNING DEPT.

DEVELOPMENT CONTROL SECT

Register Reference: 91A/0995

Development : single storey extension comprising an engineering

workshop and office at the rear

LOCATION :

: Killeen Road

Applicant

: Killeen Corrugated Products Ltd.

App. Type

: PERMISSION/BUILDING BYE-LAW APPROVA

Planning Officer : M.GALVIN

Date Recd. : 17th June 1991

Attached is a copy of the application for the above development . Your COUNCIL report would be appreciated within the next 28 days.

Yours faithfully

Date 13.08.91

•

PRINCIPAL OFFICER

Insufficient afoination in relation to essistance of sanitary accommodation, wash hand basis, druking water supply and vertilation of engineers office to external air. Julie Velly Exo 6/8/91.

sel Hed

SUPER.ENVIRON. HEALTH OFFICER, 33 GARDINER PLACE, DUBLIN 1.

CUD.

P 3677 91

COMHAIRLE CHONTAE ATHA CLIATH

Record of Executive Business and Manager's Orders

Register Reference : 91A/0995 Date Received: 17th June 1991

Correspondence : Brian O'Halloran & Associates,

Name and

: 23, Herbert Place,

Address

Dublin 2

: Single storey extension comprising an engineering

workshop and office at the rear

Location

: Killeen Road

Applicant: Killeen Corrugated Products Ltd.

App. Type : Permission

Zoning : 🐔

(MG/BB)

Report of Dublin Planning Officer dated 2nd August, 1991.

This is an application for permission for a single storey extension comprising an engineering workshop and office at the rear of Killeen Corrugated Paper Products Premises at Killeen Road for Killeen Corrugated Paper Products Ltd.

The proposed sitewhich has an area of 16,945 sq. metres is located to the west of Killeen Road in an area zoned E "to provide for industry and related uses".

Existing building on site have a total floor area of 7702 sq. metres (stated) and comprise productions, dispatch, workshop and office accommodation.

Planning permission has previously been granted for various extensions/additions and alterations to entrance of this site under the following: REG PET 'S TA 318, TA 319, TA 421 SH 724, TA 1621 NA 928, NA 1655, XA 254, XA 490

The current application provides for the construction of a 218 sq. metre single storey extension to be located to the rear of the existing production area to the west of the site. This is to accommodate an engineering workshop and office. Lodged plans indicate a flat roofed building.

COMHAIRLE CHONTAE ATHA CLIATH

Record of Executive Business and Manager's Orders

Reg.Ref: 91A/0995

Page No: 0002

Location: Killeen Road

SIte coverage at this existing site is already high i.e. 47 % CFF-0x

However, it is considered that a smaller scale extension of the order of that

proposed is generally acceptable.

Roads Department report no objection.

Sanitary Services Department recommend refusal on the basis that the proposed building encroaches on the surface water culvert. They note that the existing building is located on the culvert and recommend that it is considered that it is considered to the culvert and recommend that it is considered to the culvert and recommend that it is considered to the culvert for the Camac River is large.

I recommend that a decision to REFUSE PERMISSION be made under the Local Government (Planning and Development) Acts, 1963-1990 for the following (/) Reason:

REASONS FOR REFUSAL

01 The proposed development involves the construction of a 218 sq. metre extension over an existing surface water culvert. This would be prejudical to public health and contrary to the proper planning and development of the area; Could proper to the transfer of the area;

person à coupir la state na régain s'intré

5

·- ·

COMHAIRLE CHONTAE ÀTHA CLIATH

Record of Executive Business and Manager's Orders

Reg.Ref: 91A/0995

The second secon
Page No: 0003
Location: Killeen Road
for Dublin Planning Officer Endorsed:
Order: A decision pursuant to Section 26(1) of the Local Government (Planning and Development) Acts, 1963-1990 to REFUSE PERMISSION for the above proposal for the () reasons set out above is hereby made. Dated: ASSISTANT CITY AND COUNTY MANAGER (If the Dublin City and County Manager dated 26th July 1991.

DM.G.



Register Reference: 91A/0995

Date : 25th June 1991

PLANNING DEPT.

DEVELOPMENT CONTROL SECT

Development : Single storey extension comprising an engineering

workshop and office at the rear

LOCATION

: Killeen Road

Applicant

: Killeen Corrugated Products Ltd.

App. Type

: PERMISSION/BUILDING BYE-LAW APPROVAL

Planning Officer : M.GALVIN

Date Recd. : 17th June 1991

Attached is a copy of the application for the above development . Your report would be appreciated within the next 28 days.

Yours faithfully,

PUBLIN Co. COUNCIL

Date received in Sanitary Services -. 5.10L 1991....

FOUL SEWER Suntficient information.

Internal drainage arrangements for draining with

Apillage within the work shop have not been indicated.

DUBLIN COFFECER SIL

Not with standing that the exciting building is constituted over the surface water outwest, the approved to further extend over this entered in net acceptable.

SENIOR ENGINEER, SANITARY SERVICES DEPARTMENT, 46/49 UPPER O'CONNELL STREET, DUBLIN 1

Register Reference: 91A/0995 Date: 25th June 1991

PLANNING DEPT. DEVELOPMENT CONTROL SECT. Date
lecomment legel.
VATER SUPPLY. From free to information to dool with the file is no writery air layer submitting of the properties of the
ENDORSED POLITY DATE 21/2/2

Mary Yalvin.

DUBLIN COUNTY COUNCIL

REG. REF:

91A/0995.

DEVELOPMENT:

Single storey ext. comprising an engineering

workshop and office at the rear.

LOCATION:

Killeen Road.

APPLICANT:

Killeen Corrugated Products Ltd.

DATE LODGED:

17.5.91.

No Roads objection.

DEVELOPMENT CONTROL CECT / 3.35

TB/BMcC 8.7.91.

SIGNED:_	Ask	ENDORSED:	·
DATE:_	8/7/91	DATE:	· · · · ·

Dublin County Council Comhairle Chontae Atha Cliath

Planning Department

Fax. (01)724896



Bloc 2, Ionad Bheatha na hEireann, Block 2, Irish Life Centre, Sraid na Mainistreach Iacht, Lower Abbey Street, Baile Atha Cliath 1. Dublin 1. Telephone. (01)724755

NOTIFICATION OF DECISION TO REFUSE PERMISSION LOCAL GOVERNMENT (PLANNING AND DEVELOPMENT) ACTS 1963-1990.

Decision Order Number: P/ 3677 /91 Date of Decision: August 1991

Register Reference: 91A/0995 Date Received: 17th June 1991

Applicant : Killeen Corrugated Products Ltd.

Development : Single storey extension comprising an engineering

workshop and office at the rear

Location : Killeen Road

Time Extension(s) up to and including :

Additional Information Requested/Received:

In pursuance of its functions under the above mentioned Acts, the Dublin County Council, being the Planning Authority for the County Health District of Dublin, did by order dated as above make a decision to REFUSE PERMISSION in respect of the above proposal.

For the Reasons set out on the attached Numbered Pages.

NUMBER OF REASONS: -ATTACHED.

Signed on behalf of the Dublin County Council.....

for Principal Officer

Date: 1.51.8/

Brian O'Halloran & Associates, 23, Herbert Place, Dublin 2

NOTES

- 1. An appeal against the decision may be made to An Bord Pleanala. The applicant may appeal within one month from the date of receipt by him of this notification. ANY OTHER PERSON may appeal within twenty one days beginning on the date of this decision.
- 2. An appeal shall be in writing and shall state the subject matter and grounds of appeal. It should be addressed to:-

An Bord Pleanala, Blocks 6 and 7 Irish Life Centre, Lower Abbey Street, Dublin 1.

- 3.An appeal lodged by an applicant or his agent with An Bord Pleanala will be invalid unless accompanied by the prescribed fee.
- (a) An appeal against a decision relating to commercial development by the person by whom the application was made must be accompanied by a fee of £100 (one hundred Pounds).
- "Commercial Development" means development for the purposes of any professional, commercial or industrial undertaking, development in connection with the provision for reward of services to persons or undertakings, or development consisting of the provision of two or more dwellings, but does not include development for the purposes of agriculture.
- (b) An appeal other then an appeal mentioned at (a) above, including third party appeal must be accompanied by a fee of £50 (fifty pounds)
- (c) A party to an appeal making a request to An Bord Pleanala for an Oral Hearing of an appeal must, in addition to the prescribed fee, pay to An Bord Pleanala a fee of £50 (fifty pounds).
- (d) A person who is not a party to an appeal must pay a fee of £15 (fifteen pounds) to An Bord Pleanala when making submissions or observations to An Bord Pleanala in relation to an appeal.
- **4.**If the Council makes a decision to grant permission/approval and there is no appeal to An Bord Pleanala against this decision, PERMISSION/APPROVAL will be granted by the Council as soon as may be after the expiration of the period for the taking of such an appeal. If every appeal made in accordance with the Acts has been withdrawn, the Council will grant the PERMISSION/APPROVAL after the withdrawal.
- **5.** Approval of the Council under the Building Bye-Laws must be obtained and the terms of the approval must be complied with in the carrying out of the work before any development which may be permitted is commenced.

Dublin County Council Comhairle Chontae Atha Cliath

Planning Department

Reg.Ref. 91A/0995
Decision Order No. P/ 3677 /91
Page No: 0002



Bloc 2, Ionad Bheatha na hEireann, Block 2, Irish Life Centre, Sraid na Mainistreach Iacht, Lower Abbey Street, Baile Atha Cliath 1. Dublin 1. Telephone. (01)724755 Fax. (01)724896

REASONS FOR REFUSAL

01 The proposed development involves the construction of a 218 sq. metre extension over an existing surface water culvert. This would be prejudical to public health and contrary to the proper planning and development of the area, and could endanger the health and safety of persons occupying the structure or an adjoining structure.

NOTES

- 1. An appeal against the decision may be made to An Bord Pleanala. The applicant may appeal within one month from the date of receipt by him of this notification. ANY OTHER PERSON may appeal within twenty one days beginning on the date of this decision.
- 2. An appeal shall be in writing and shall state the subject matter and grounds of appeal. It should be addressed to:-

An Bord Pleanala,
Blocks 6 and 7
Irish Life Centre,
Lower Abbey Street,
Dublin 1.

- 3.An appeal lodged by an applicant or his agent with An Bord Pleanala will be invalid unless accompanied by the prescribed fee.
- (a) An appeal against a decision relating to commercial development by the person by whom the application was made must be accompanied by a fee of £100 (one hundred Pounds).
- "Commercial Development" means development for the purposes of any professional, commercial or industrial undertaking, development in connection with the provision for reward of services to persons or undertakings, or development consisting of the provision of two or more dwellings, but does not include development for the purposes of agriculture.
- (b) An appeal other then an appeal mentioned at (a) above, including third party appeal must be accompanied by a fee of £50 (fifty pounds)
- (c) A party to an appeal making a request to An Bord Pleanala for an Oral Hearing of an appeal must, in addition to the prescribed fee, pay to An Bord Pleanala a fee of £50 (fifty pounds).
- (d) A person who is not a party to an appeal must pay a fee of £15 (fifteen pounds) to An Bord Pleanala when making submissions or observations to An Bord Pleanala in relation to an appeal.
- **4.**If the Council makes a decision to grant permission/approval and there is no appeal to An Bord Pleanala against this decision, PERMISSION/APPROVAL will be granted by the Council as soon as may be after the expiration of the period for the taking of such an appeal. If every appeal made in accordance with the Acts has been withdrawn, the Council will grant the PERMISSION/APPROVAL after the withdrawal.
- 5. Approval of the Council under the Building Bye-Laws must be obtained and the terms of the approval must be complied with in the carrying out of the work before any development which may be permitted is commenced.

Dublin Council Comhairle Chontae Atha Cliath

Planning Department

Block 2, Irish Life Centre,



Building Control Department, Liffey House, Tara Street, Dublin 1. Telephone:773066 Sraid na Mainistreach Iacht, Lower Abbey Street, Baile Atha Cliath 1. Dublin 1. Telephone. (01)724755 Fax. (01)724896

Bloc 2, Ionad Bheatha na hEireann,

Register Reference: 91A/0995 Date: 18th June 1991

LOCAL GOVERNMENT (PLANNING AND DEVELOPMENT) ACTS, 1963 TO 1990

Dear Sir/Madam,

DEVELOPMENT: Single storey extension comprising an engineering

workshop and office at the rear

LOCATION : Killeen Road

APPLICANT : Killeen Corrugated Products Ltd.

APP. TYPE : PERMISSION/BUILDING BYE-LAW APPROVAL

With reference to above, I acknowledge receipt of your application received on 17th June 1991.

Yours	faithfully,	
••••		•

PRINCIPAL OFFICER

Brian O'Halloran & Associates, 23, Herbert Place, Dublin 2



Planning Application Form/ Bye - Law Application Form

1	Application for Permission Outline Permission Approval Place in appropriate box. Approval should be sought only where an outline permission was previously granted. Outline permission may not be sought fretention of structures or continuances of uses.	
2	Postal address of site or buildingKilleen_Road,_Dublin_12 (If none, give description sufficient to identify).	<u> </u>
3	Name of applicant (Principal not Agent). Killeen. Corrugated. Products. Limited	<i></i>
_	Address Killeen Road, Dublin 12	******
4	Name and address of Brian O'Halloran & Associates person or firm responsible 23, Herbert Place, Dublin 2 Tel. No. 764017	
5	Name and address to which Brian O'Halloran & Associates notifications should be sent 23, Herbert Place, Dublin 2	283
6	Brief description of	462
- 7	Method of drainage To. Public Sewer. 8. Source of Water Supply From .Public Main	
rish	In the case of any building or buildings to be retained on site, please state: (a) Present use of each floor or use when last used. Ground. Floor. — Production. Facilities. Existing. Offices. Ground. (b) Proposed use of each floor. As (a) above	& 1st F1
	Does the proposal involve demolition, partial demolition TUBLIN 12 Application is being made to Dublin County or change of use of any habitable house or part thereof?	
. جمعه 11 أ	al Area of Site Series on the Construct a 16,945.	iq. m.
6/9/	b) Floor area of proposed development	šq. m.
		iq. m.
12	State applicant's legal interest or estate in site i.e. freehold, leasehold, etc.) Freehold	30+13*******
13	Are you now applying also for an approval under the Building Bye Laws? Yes X No Place / in appropriate box.	
14	Please state the extent to which the Draft Building Regulations have been taken in account in your proposal:	
	t is the policy of this Office to take account of Building Regulations.	
15	List of documents enclosed with)A404412774
10	Gross floor space of proposed development (See back)	
	No of dwellings proposed (if any)	*45*41*5155
	Fee Payable £.1,144,50 Basis of Calculation 218 x £1.75 & 218 x £3.50	
	Signature of Applicant (or his Agent) Brigh O'Halloran & Associates Date 10th June 1991	
	Application Type PIB FOR OFFICE USE ONLY Register Reference 91A 0995 Amount Received £ 3 16. 0. 2	
	Amount Received £ 2 16.0. L 1 1 C Receipt No	

LOCAL GOVERNMENT (PLANNING & DEVELOPMENT) REGULATIONS 1977 to 1984.

Outline of requirements for applications for permission or Approval under the Local Government (Planning & Development) Acts 1963 to 1983. The Planning Acts and Regulations made thereunder may be purchased from the Government Publications Sales Office, Sun Alliance House, Molesworth Street, Dublin 2.

- Name and Address of applicant.
- Particulars of the interest held in the land or structure, i.e. whether freehold, leasehold, etc.
- The page of a newspaper, circulating in the area in which the land or structure is situate, containing the required statutory notice. 3. The newspaper advertisement should state after the heading Co. Dublin.
 - (a) The address of the structure or the location of the land.
 - The nature and extent of the development proposed. If retention of development is involved, the notice should be worded accordingly. Any demolition of habitable accommodation should be indicated.
 - The name of the applicant.
 - NB. Applications must be received within 2 weeks from date of publication of the notice.
- Four (4) sets of drawings to a stated scale must be submitted. Each set to include a layout or block plan, proposed and existing services to be shown on this drawing, location map, and drawings of relevant floor plans, elevations, sections, details of type and location of septic tank (if applicable) and such other particulars as are necessary to identify the land and to describe the works or structure to which the application relates (new work to be coloured or otherwise distinguished from any retained structures). Buildings, roads, boundaries and other features bounding the structure or other land to which the application relates shall be shown on site plans or layout plans. The location map should be of scale not less than 1: 2500 and should indicate the north point. The site of the proposed development must be outlined in red. Plans and drawings should indicate the name and address of the person by whom they were prepared. Any adjoining lands in which the applicant has an interest must be outlined in blue.
- In the case of a proposed change of use of any structure or land, requirements in addition to 1, 2, & 3 are:
 - (a) a statement of the existing use and the proposed use, or, where appropriate, the former use and the use proposed.
 - (b) (i) Four (4) sets of the drawings to a stated scale must be submitted. Each set to consist of a plan or location map (marked or coloured in red so as to identify the structure or land to which the application relates) to a scale of not less than 1:2500 and to indicate the North point. Any adjoining lands in which the application has an interest must be outlined in blue.
 - (ii) A layout and a survey plan of each floor of any structure to which the application relates.
 - (c) Plans and drawings should indicate the name and address of the person by whom they were prepared.
- Applications should be addressed to: Dublin County Council, Planning Department, Irish Life Centre, Lr. Abbey Street, Dublin 1, Tel. 724755.

CLASS

NO.

2.

3.

4.

5.

6.

7.

8.

9.

10.

SEPTIC TANK DRAINAGE: Where drainage by means of a septic tank is proposed, before a planning application is considered, the applicant may be required to arrange for a trial hole to be inspected and declared suitable for the satisfactory percolation of septic tank effluent. The trial hole to be dug seven feet deep at or about the site of the septic tank. Septic tanks are to be in accordence with I.I.R.S. S.R. 6:75.

INDUSTRIAL DEVELOPMENT:

The proposed use of an industrial premises should, where possible, be stated together with the estimated number of employees, (male and female). Details of trade effluents, if any, should be submitted.

Applicants to comply in full with the requirements of the Local Government (Water Pollution) Act,1977 in particular the licencing provisions of Sections 4 and 16.

CLASS

Е

DESCRIPTION NO. DESCRIPTION £32.00 each Dwelling (House/Flat) Provision of dwelling — House/Flat. В Domestic Extension £16.00 Domestic extensions/other improvements. (improvement/alteration) £40.00 minimum Provision of agricultural buildings (See Regs.) Building — Office/ £1.75 per sq. metre (Min. £40.00) C Other buildings (i.e. offices, commercial, etc.) Commercial Purposes Agricultural D Use of land (Mining, deposit or waste) £25.00 per 0.1 ha (Min £250.00) Buildings/Structures £25.00 per 0.1 ha Use of land (Camping, parking, storage) (Min. £40.00) £25,00 per 0.1 ha Provision of plant/machinery/tank or

(Min. £40.00)

(Min. £100.00) other structure for storage purposes. £100.00 Petrol Filling Station. £10.00 per m² Advertising Structures. (min £40.00) £25,00 per 1,000m Electricity transmission lines. (Min. £40.00) £5.00 per 0.1 ha Any other development. 11.

PLANNING APPLICATIONS

£30.00 each £3,50 per m² (min. £70.00) £1.00 per m² in excess of 300 sq. metres (min. - £70.00) (Max. - £300.00) Petrol Filling Station £200.00 £9.00 per 0.1 ha Development or (£70.00 min.) Proposals not coming within any of the foregoing classes.

BUILDING BYE-LAW APPLICATIONS

Min. Fee £30.00 Max. Fee £20,000

£55.00 each


Cheques etc. should be made payable to: Dublin County Council.

Gross Floor space is to be taken as the total floor space on each floor measured from the inside of the external walls. For full details of Fees and Exemptions see Local Government (Planning and Development) (Fees) Regulations 1984.

The state of the s	Marie Caracian Caracian Commence	Lessing Articles and Article	Ŕ	ECEI	PT C	ODE	
46/49 UPPER O'CONNELL	CLIATH isous of STREET of tendered is	this re	coint in th		no:	en eu	The same of the sa
RIC. EL. EX. 381.50	feg	N	41	.25	5 	2 (4) 60 63	The second second
to an appropriate to the second secon	[7]] day of	I	oe	,	· · · · · · · · · · · · · · · · · · ·	197.	
From Killer corresponded products	11-0	************				· · · · · · · · · · · · · · · · · · ·	
380000010022 passage			'#!			1 e	
he sum of three hundred and eight	/ One Pe	ence, being.	La l	ζ. _Γ	Plan	ound	ds
M 1 1 0 110-	nie D	S. Princi	CARÉY	· •	955 L	,	44

	A CODE
COMHAIRLE CHONI	TAE ATHA CLIATH
DUBLIN COUNT 46/49 UF	PPER O CONNELL STREET
CHECULE TO A STATE OF THE STATE	TOURING 1
Beceived this	day of
Trom LETTER COLLICAP	
the the speak	F PIZ F FFFFFFFFFFFFFFFFFFFFFFFFFFFFFFFF
The sum of Research	A Downess
	Pence Deing Lac La
opolication of	
	S CAREY Cashier Principal Officer

Dublin County Council, Planning Department, Irish Life Centre, Lower Abbey Street, Dublin, 1.

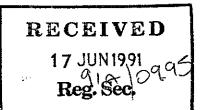

BOHH

23 HERBERT PLACE DUBLIN 2 IRELAND TEL 01 · 764017 FAX 01 · 762963

Attention Planning Officer & Building Bye-Law Inspector

TO'C/JM/90/51 17th June, 1991

Re

Planning and Building Bye-Law Application for Proposed Single Storey Extension to Existing Factory at Killeen Road, Dublin, 12 by Killeen Corrugated Products Limited

Dear Sirs

On behalf of our Clients, Killeen Corrugated Products Limited, Killeen Road, Dublin 12, and in accordance with the Local Government (Planning and Development) Acts, 1963:1983, we hereby make application for Planning Permission to construct a single storey extension comprising an Engineer's Office, an Engineering Workshop and an Electrician's Shop at the rear of their premises at Killeen Road.

We hereby also make a Building Bye-Law Application for the proposed extension.

In support of our Application, we enclose herewith the following documentation:

- 1.0 DOCUMENTS PREPARED BY BRIAN O'HALLORAN & ASSOCIATES
- 1.1 4 No. copies Architectural Drawings:

90/51/01 Site Plan, Site Location Map and Location Map 1:300, 1:2500 & 1:20000 (Site Outlined in Red)

90/51/02 Floor Plan and Elevations @ 1:100

90/51/03 Section and Details @ 1:50 & 1:10

- 1.2 4 No. copies of Outline Specification.
- 1.3 Dublin County Council Planning & Bye-Law Application Form completed.

- 2.0 DOCUMENTS PREPARED BY KML CONSULTING ENGINEERS
- 2.1 2 No. copies drawings:

91 051/SK.05

Drainage Details 1:100

91.051/01

Typical Manhole Details N.T.S.

- 2.2 2 No. copies structural calculations.
- 2.3 2 No. copies of certificate in respect of structure.
- 3.0 Page 27 of the Irish Press of Tuesday, June 4th 1991, with the Planning Notice for this Development outlined in red.
- 4.0 The gross floor area in relation to the Planning Applications is 218 M^2 , Class No. 4, which at a rate of £1.75 amount;s to £381.50.

The gross floor area in relation to the Building Bye-Law Application is 218 M², Class No. C, which at a rate of £3.50 amounts to £763.00.

We therefore submit a cheque in the sum of £1,144.50.

We trust the above documentation complies with your requirements. If you require further information, please contact the undersigned.

Yours faithfully,

Tom O'Connor

BRIAN O'HALLORAN & ASSOCIATES

Encl/..



RECEIVED



PL/MM/91.051

7th June, 1991

Brian O'Halloran & Associates, 23 Herbert Place, Dublin 2.

Attention: Mr. Martin Meehan

Dear Sirs,

Re: Workshop at Killeen Corrugated Products

We hereby certify that the structure for the above building will be designed in accordance with all relevant current standards and codes of practice and that the construction will be supervised by a Chartered Engineer.


Yours faithfully,

KML CONSUTLING ENGINEERS

Directors: Kevin J. McLoughlin, BE, CEng, DCT, FIStructE, MICE, FIEI, M.ConsEI (Managing) John A. Lombard, CEng, MIStructE, MIEI, Dip. Proj. Man.
Consultant: Prof. P.J. Dowling, PhD, DIC, FEng, FICE, FIStructE, FRINA.

Associate: Vincent Barrett, BSc (Eng), MSc, DIC, MIStructE, MIEI, CEng. Associate Companies: RML (London), FML (Overseas). Kevin McLoughlin Associates Ltd. Registered No. 122166. Registered Office: 20 Terenure Road West, Dublin 6, Ireland.

PIPE TO PENETRATE CULVERT WALL TO BE SURROUNDED IN CONCRE, 1.4.47.24. 1.2.48.44. 1.4.1. CONC. SURROUND 100 p. F.F.L. 48.39.

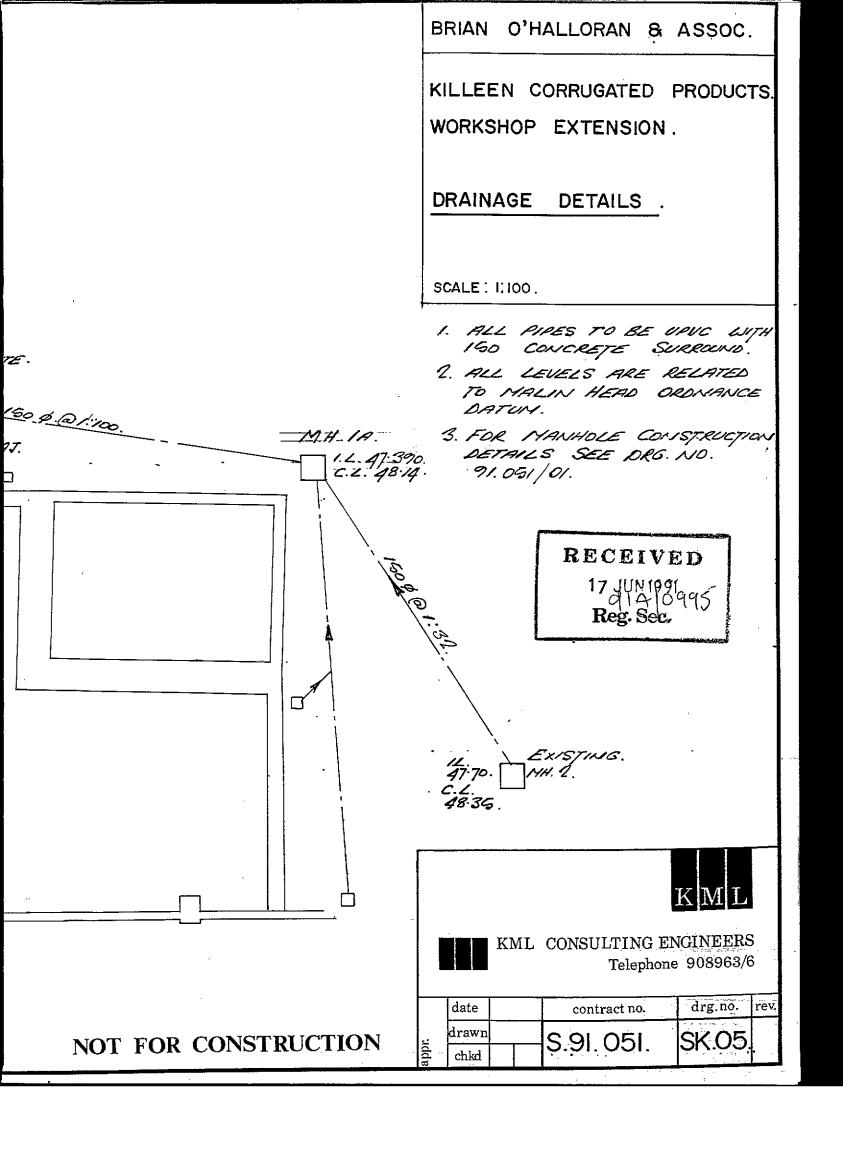

RECEIVED
17 WN1991
17 Sed OQAS

BRIEF OUTLINE SPECIFICATION OF WORK

FOR .

SINGLE STOREY EXTENSION TO EXISTING FACTORY

AT

KILLEEN ROAD, DUBLIN 12

FOR

KILLEEN CORRUGATED PRODUCTS LIMITED.

June 1991

Brian O'Halloran & Associates Architects 23 Herbert Place Dublin 2.

Job Ref. 90/51

FINISHES

All floor, walls and ceiling finishes in offices and workshops to be

as desired by the client and in accordance with current

regulations.

SITE

Shall be excavated/filled to required levels to suit existing

buildings and drainage.

DRAINAGE

Excavate for and lay surface water drains to appropriate falls,

complete with manholes, gulley traps and road gullies as required.

FOUNDATIONS

Excavate for and pour reinforced concrete foundations to Engineers

design and detail.

FLOOR SLAB

Is dust proofed and power floated concrete slab 150 thick

reinforced with C283 mesh 1000 guage Visqueen on 150 thick

blinded hardcore.

ROOF

To be Trocal on insulation on Tegral metal decking on universal

beams to Engineers design and detail.

EXTERNAL WALLS

Outer leaf to be standard 100mm solid blockwork, 100mm cavity

with 50mm insulation, and the inner leaf to be 215mm standard solid blockwork topped with a U block edge beam to Engineers

design and detail.

INTERNAL WALLS

To be 100mm thick standard solid blockwork finished as built.

DOORS

External door and frame to be metal. 3 No. doors to existing

production area to be 1 hour fire rated metal doors and frames.

WINDOWS

3 No. windows to be double glazed Aluminium frame.

INTERNAL GLAZED

SCREENS

1 No. screen between office/workshop to be Aluminium frame double glazed 1 No. screen between office/existing production area

to be metal frame 1 hour fire rated.

Architects:

Brian O'Halloran & Associates, 23 Herbert Place,

Dublin 2.

June, 1991

Structural Calculations for Proposed Extension to Killeen Corrugated Products Killeen Road, Dublin 12



CONSULTING ENGINEERS
Civil and Structural

Contract Killon C	omuated	Produc	Job ref.	_
Part of structur	,		Calc. Sheet No.	
Drawing ref.	Calculations by	Checked by	Date 4/6/91	_

Members ref.	CALCULATIONS	OUTPUT
		-
)	Design Codes of Practice	 []
	This structure was designed in accordance wi the following Design Codes of Practice:	
,	BS6399 Design loading for Buildings	
	Bsvve; Port 2 - The Use of Structural Steel in Buildings	
	CP3; Chapter V; Part 2 - Wood loading on Buildings	37
	IS325; Part 1 - The Structural Use of Unrang	forced
-		
i		and the second of the second o
		MARK TELEVISION OF THE PERSON

CONTENTS

1.0	General Loading
2.0	Load takedown
3.0	Foundations
4.0	Masonry
5.0	Roof
6.0	Lintols

1.0 General Loading




CONSULTING ENGINEERS

Civil and Structural

	Contract Kilkon (a	rugated	Product	Job re - S	ef. .91.0 <i>51</i>	
1	Part of structure)		Caic.	Sheet No.	
	General	loading	a		1 < }	
	Drawing ref.	Calculations by	Checked by	Date	31/5/01	

Members ref.	CALCULATIONS		<u>.</u>	01	ОТРИТ
	General looding				
				Cuncle	ative
			Qu	Gu	_ Qu,
		(ku/m²)	(ky/m2)	Curul Gu (Ku/m')	(ku/mi)
	D Roof		*****		
			: ·		
}	Trocal Roofing + Insulation	0.50			
	Metal Decking -	0.10			
	ا يان	0.10			
	Suspended Coiling =	_0.20_			
1	Spice	0.25			
		<u> </u>			
	Access for maintenance only		0.75		
	- Access in your orange only		 		
]	1	1
	Total for Roof =			~ ~ ~	
	Total For Roof =		<u>,</u>	0.85	0:75
			1	<u> </u>	
	@ Cavity Wall		 		
	100 Brick outer baf	s.o,			
	100 Cavity		 		ļ
	_ zis Block inner loof	_ K·30			
	215 Block incor loaf I face of Plaster	25.0			
_	Total for Guity Woll =			6.55	
			·	,	1
					. 220
					- :
	A MARIE TO THE PARTY OF THE PAR				
	The state of the s	* * * :	.a. u		
					
	The state of the s		on the second		· · · · · · · · · · · · · · · · · · ·
		W			-
		• • •			

2.0 Load Takedown

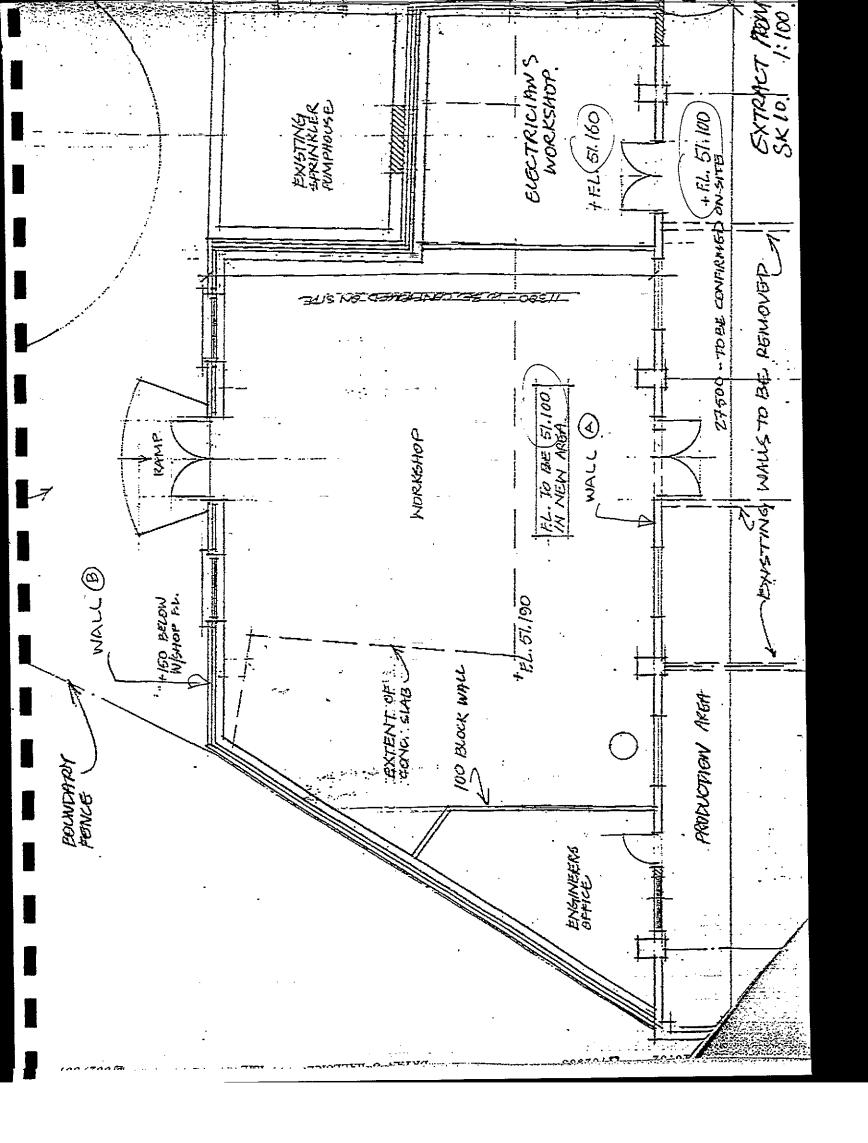


KML

CONSULTING ENGINEERS
Civil and Structural

(Job ref.
۱	Killon Corrugated Products	91.051
	Part of structure	Calc. Sheet No.
	land Talendows	Date / /
	Drawing ref. Calculations by Checked by	31/5/01

nbers	CALCULATIONS		- TRG - E	OU	TPUT
	load Takedown - Existing We	all A			
				concl	ative
	11:57	(ku/m)	Qu (xne/m)	(ku/m)	(ku/m)
	1) Proposed flat roof over 11.5/ Su = 0.85 x 11.5/2 Ou = 0.75 x 11.5/2	y.89	メ・31	×.69	\\\\.\\\\\\\\\\\\\\\\\\\\\\\\\\\\\\\\\
	Or ~ D. Skylos	0.50		5.39	
	Oself-weight of 200 rc wall (h= x, sm)	21.60		26.99	
	Total load at foundation =		and the second s	26.99	K.31
	load Bhadown - Proposed W	all (3)_			
	load Bhadoun - Proposed W	all (B)_ Grand	Q. (FW/m)	Cum (kw/m)	Jativa Q.,
	O Proposed flat roof over Gu: 0.85 X 11.57	Gu		(kw/m)	Q. (w/m
	Dad Directions O Proposed flat rocf over 11.5/2m Gu: 0.85 x 11.5/2 Qu: 0.75 x 11.5/2 The Roof steelwork	Gr. (ku/m)	٧٠٦١.	(kw/m)	(EU/M
	Dad Directions O Proposed flat rocf over 11.5/2m Gu: 0.85 x 11.5/2 Qu: 0.75 x 11.5/2 The Roof steelwork	Gr. (ku/m)	¥.31	(kw/m)	(EU/m
	O Proposed flat roof over 11.5/2m Gu: 0.85 x 11.5/2 Qu: 0.75 x Short stoolwork Gu ~ 0.5kn/m 3 215 Block income toof plus I face of plaster (h: 5.5m)	Gn (kn/m) K.89 0.50.	¥.31	(kw/m) (k.89_	(pu/m
	O Proposed flat rocf over 11.5/2m Gu: 0.85 x 11.5/2 Qu: 0.75 x D Roof stockwork G: ~ 0.5 kn/m (3) 215 Block innor loaf plus face of plaster (h: 5.5 m) Gu: K.SSXS.S.	Gn (kn/m) K.89 0.50.	¥.31	S.39 30.47	(EV/M

3.0 Foundations

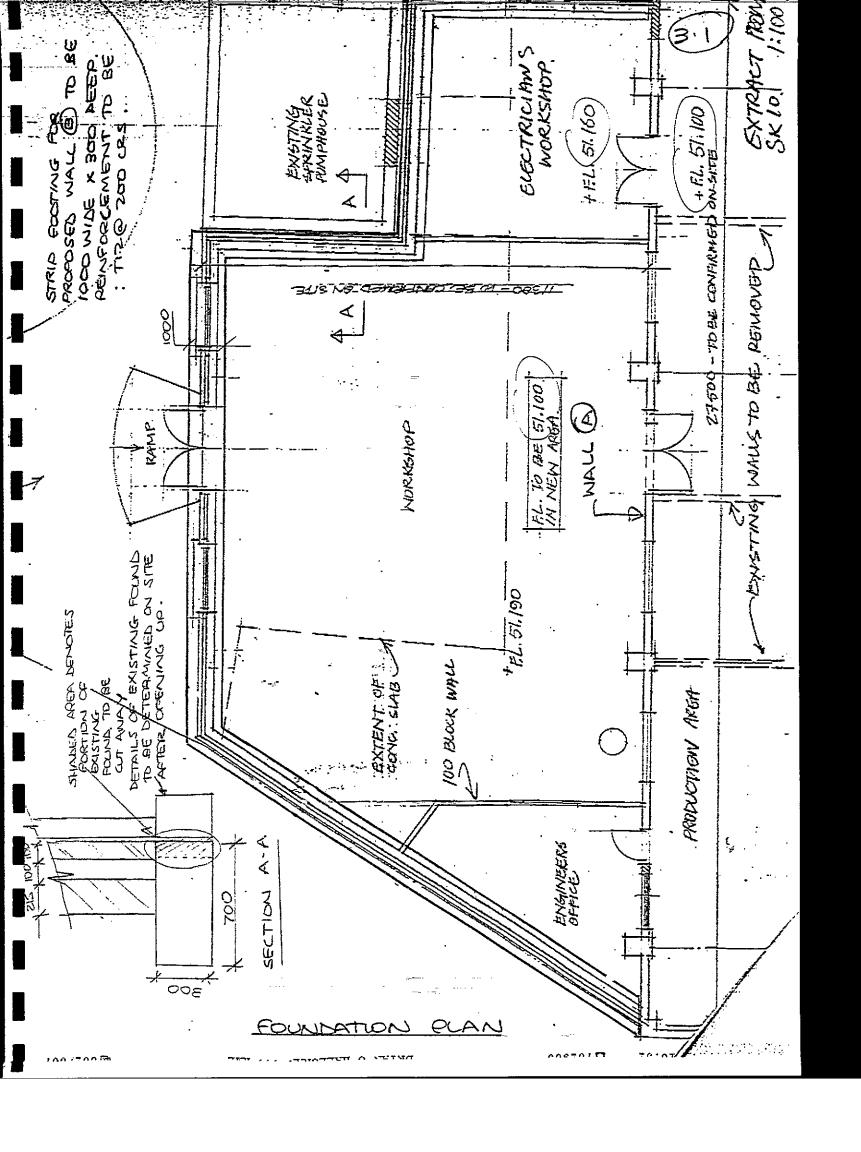



CONSULTING ENGINEERS

Civil and Structural

Contract	arregated	Roducts	Job r	ef. .91.051
Part of structur				Sheet No.
Drawing ref.	Calculations by	Checked by	Date	31/5/91


CALCULATIONS	ОИТРИТ
Foundations	
Ofoundation for Wall (A)	
from load takedoug calculations:	
WUSERVIE WIND	
•	
100	wall A
	0.600 wide strp
load at foundation: G. serv = KI. KZ KW/m Ou serv = K31 KW/m	
Assume on Allowable Bearing Pressure	
) Width of strip required = <u>k1. k2 + k.31</u> = 0.46 m	foundation for
A 1.0m unde stop will be adequate	1.0m wide strip
	Foundations Ofoundation for Wall (A) from load takedown calculations: load at boundation . G. seev : 26.99 km/m Assume a Allowable Booma Ressure of 100 km/m) Width of strip required . 26.99 + K.31 _ 0.31 m 100 A own wide strip will be adequate Ofoundation for Wall (B) From load takedown calculations: load at foundation: G. seev : KI. VZ KM/m Assume an Allowable Booma Pressure of 100 km/m Assume an Allowable Booma Pressure of 100 km/m Width of strip required . 100 m



Contract Killoon (orrepted	Roder	Job ref.
Part of structur	,	:	Calc. Sheet No.
Drawing ref.	Calculations by	Checked by	Date 5/5/91

Members CALCULATIONS ref.	OUTPUT
	Fizezoo

4.0 Masonry

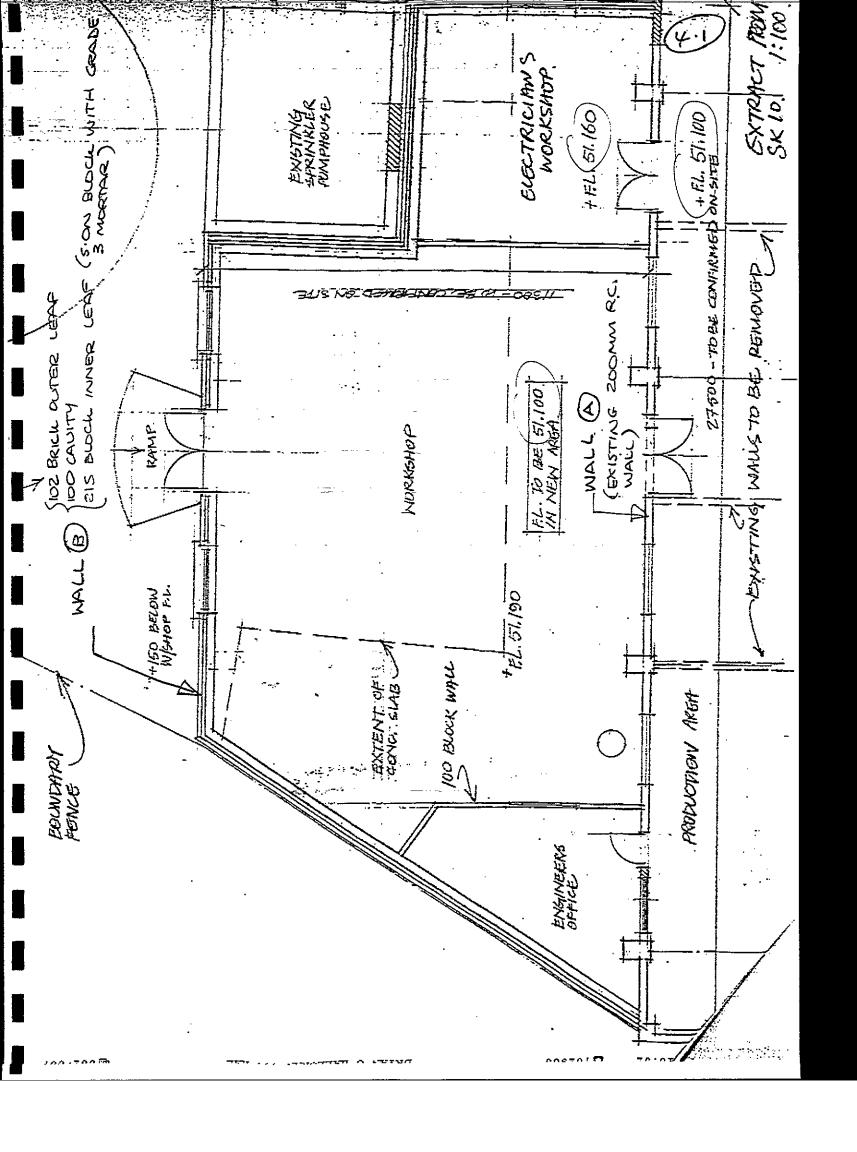



Contract	angatea	Rodu	Job ref.
Part of structur	e		Calc. Sheet No.
Drawing ref.	Calculations by	Checked by	Date 91/5/91

Members ref.	CALCULATIONS	OUTPUT
	Determination of Blackwork Strengths Required for Poposed Wall (B)	
	Obstical loading from load takedoury calculations for wall @:	
	Inner leaf load at foundation Sizer = 30:42 kn/m Quistre = K:31 kn/m	
	Design load at foundation = (1.xx30.x2) + (1.6xx31) = x2.50 m/m	
	Blockwork Strength is determined on the bosis of the Pier formed bolivery adjacent growings:	
	1-65 -1.50 2.20	
	Equivalent load on Por: = 116.49 ku/m	
	hef = x500 = 21 tef 215 Assume that bood at top of wall acts at a distance of 3t in from the booded face of the wall => ex= 1/2-1/3 = 0.17t	
	a distance ξ 3t is from the boded face of the wall \Rightarrow $2x = \frac{1}{2} - \frac{1}{3} = \frac{0.17}{2}$	



Contract	ar nated	Q 1 1	Job ref.
Part of structur	e	17001 C.	Calc. Sheet No.
Drawing ref.	Calculations by	Checked by	Date 31/5/91

Members ref.	CALCULATIONS	ОИТРИТ
<u> </u>		
Q.L.		
學士	8= 0.51	
1000	P - 0.31	, a, the same of the same
	X 35 (Codes)	
	Sm = 3.5 (1bornal Control)	
	2 ()	
	> funeqd = 3.5 × 116.49 = 3.7 N/mm	
	212 X 12,0	مستريب بالم
- 11 - (3)	Require SN Blockup L and Grade 3	
6602(f)		
	Woctor -	****
		2 3 7 T ETT TOTAL
	The state of the s	
	A CONTROL OF THE PARTY OF THE P	
	· · · · · · · · · · · · · · · · · · ·	
<u></u>		:
<u> </u>		
	the state of the s	
	AND THE RESERVE OF THE PARTY OF	
	The state of the s	
		·
		ļ.
		Ş
		\$! !
-		
		<u> </u>



Contract Killean	Strusted	Products	Job ref.
Part of structur	,	NO CONTRACTOR	Calc. Sheet No.
Drawing ref.	Calculations by	Checked by	Date 31/5/81

Members ref.	CALCULATIONS	ОПТРОТ
	3) lateral loading Height of wood ponel = 3.5m.	
	What looding wh = Nf for wind load = 1: X 102 mm Brich aster loof } 100mm Cavity / Guity Wall Construction 215 mm Block inner loof	· · · · · · · · · · · · · · · · · · ·
	215 mm Block inner loof] Que for brick loof at 0.5 max. height of wall (0.5 x 3.5) = 2.0 x 0.5 x 3:5 = 3.5 ku/m load per unit area = 3.5 x 10 = 0.03 x n/mm 102 x 10 = 0.9 x 0.03 x	- · · · · · · · · · · · · · · · · · · ·
	Ju for 6lock baf at 0.5 max. height of wall = K.55 x 0.5 x 3.5 = 7.96 ku/m nclude roof = 0.65 x 11.5/2 = K.9 ku/m load per voit area = 12.86 x 10 ³ = 0.06 n/mm ²	
	Dornal manifacturing and construction.	
	$\omega \cap t \cap \lambda = \lambda \cap \lambda = $	· · · · · · · · · · · · · · · · · · ·
		j



	Contract Killeon G	angated Products	Job ref. . 91.051,
Į	Part of structur	e . ´	Calc. Sheet No.
	Moso	<u> </u>	<u> </u>
	Drawing ref.	Calculations by Checked by	Date 21/5/91

Members ref.	CALCUL	оитрит	
			. ~~
	Brick	Block	
	Z102 = 1.73x106mm3	7215 2 72 70 4 × 10 mm	· .
	fux = 0.4		
	0m = 3.5		<u>.</u>
	gd = 0.031N/mm=		
	MD = [0.K + 0.031 X1.03×106	; - ·	
2-7	= 0.52 KMW	1	
	5.1 = 20M3		· ·
	<u> </u>	<u> </u>	
	Nbr = 0.71x1: K x 0.25	Wbc = 0:21x1: 1x1. 1.01.	
	= 0.19. ku/m=	= 0.80 km/m=	
	3 MA(b) = 0.19 × 3.5°	Ma(b) = 0.8 × 3.5	
	= 0:29 KNW >0:25	10:15 mm >1:01	
	> Unsatisfactory	> Unsatisfactory	
=			
		· · · · · · · · · · · · · · · · · ·	
	and the second of the second o		
(ند

KML

Contract Killeen Cornected Products	Job ref
Part of structure	Calc. Sheet No.
Masonry	4.6
Drawing ref. Calculations by Checked by	Date 31/5/91


Members ref.	CALCULATIONS	оитрит
	Adopting special monufacturing and construction control > Xm = 2:5	
	Brick Block	
	7.02 = 1.73 × 10 000 3 2215 = 7.70 × 10 00 00 3	
	fux = 0:4 fex = 0.25	
1	9d = 0.031 N/mm² 9d = 0.06N/mm²	6
	MP= [5.2 5.0 X1.)3 × 106 MP= [5.2 +0.06] × 2.20 × 10	
	= 0.33 ku m = 1.23 ku m	
	Mpc = 0.01×1.K×0.33 Mpl = 0.01×1.K×1.53	
	1.56 = 0.21 ku/m² = 0.78 ku/m²	215 Block inner
	Ma(b) = 0.21×3.5 ² Ma(l) = 0.78×3.5 ² .	leaf to your country wall
	= 0:32 km < 0:33 = 1.19 km m < 1.23 Satisfactory! Satisfactory!	s.on Block with Grode 3 Mortor
		Special manifactor and construction
		control

KML

Contract		~ · · · · · · · · · · · · · · · · · · ·	Job ref.	
Killeen Co	rucated f	roducts	91.051	
Part of structure	, ,	1.3	Calc. Sheet No.	
Existing	R.C. WO	<u>all</u>	<u> </u>	
Drawing ref.	Calculations by	Checked by	Date = /5/91	
(-38		5/6/91	

Members ref.	CALCULATIONS	оитрит
	Check Ability of Existing RC. Wall to Carry Increased load from Proposed Extension	
	From load taledown cales: Gussev at base = K:31 W/m	
	Ultroate load = (1.xx26.99) + (1.6xx.31) = xx.7 xv/m. Moment at Top of Wall:	·
	Assume that roof bad acts at a distance of 100mm out from the baded face of the wall:	
	N = kr.2 × 103 = 0.22	
	M = k.3 × 10 = 0.10 bh = 1000 × 200 = 0.10 100 Asc = 0.10 (Munyang Steel).	
) Asc regd = 0.xx1000x200 = 600mm?	<u>~</u>
	800 Require TIZEZOO each face vortical Renforcement and TIZEZOO each face Howental Renforcement.	
	By reporting according according to	Existing 200 re wall capable of taking increase

5.0 Roof

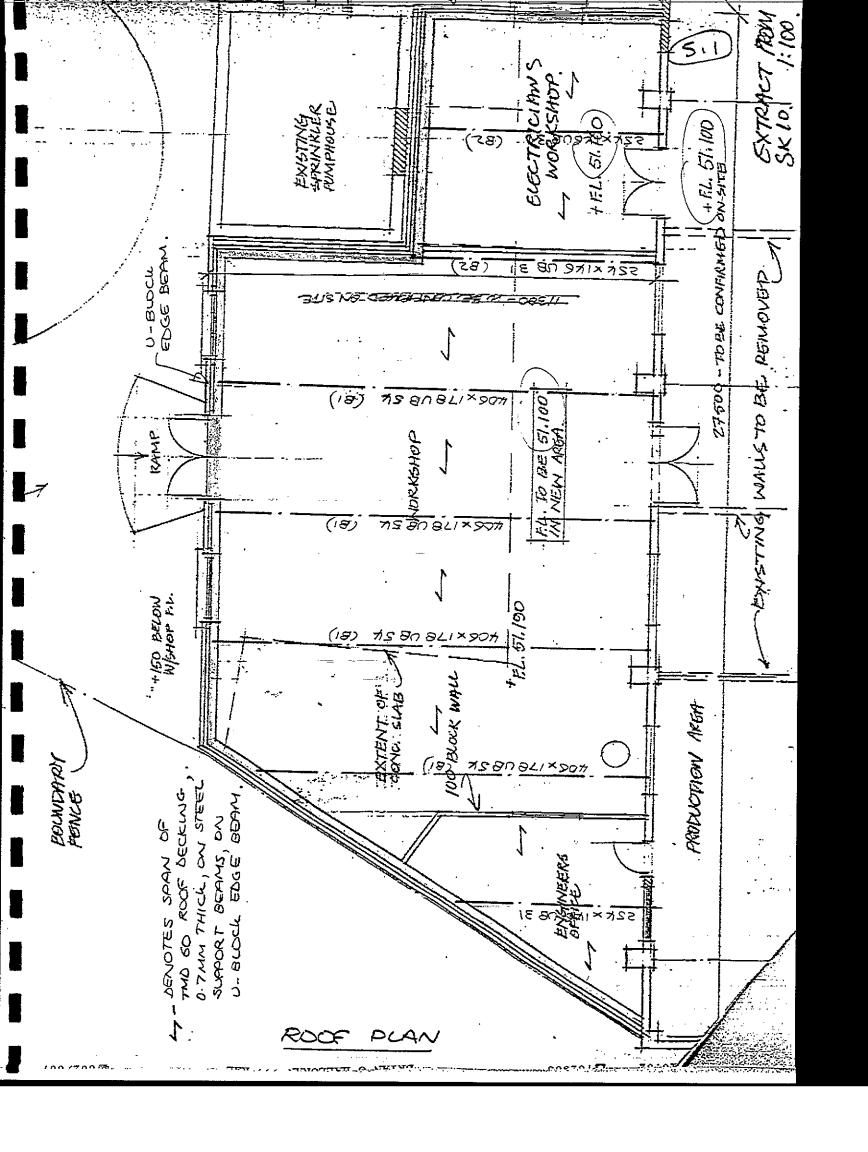



CONSULTING ENGINEERS

Civil and Structural

Contract			Job ref.
1. 11	regated Fr	Boucts	91.051
Part of structur	e		Calc. Sheet No.
Roof			5.2
Drawing ref.	Calculations by	Checked by	Date 31/5/91

mbers	CALCULATIONS	OUTPUT
		1
	o Motal Deckna	
	Max spon of decking = 3.5m (Double spon)	Roof Decking
	Try_TMD-50 decking.	
. Transport	Capacity of decling = 1:51 km/m2 - del.	Double Spoon
o de la constante de la consta		Supports @ 3.5
		ors. mox.
And Paris	@ Support Bean Bl	74, 11
	Spos of Boon ~ 11.5m	
	Loading Gr. Qu. (Ku/m) (Ku/m)	
	(xu/m) (xu/m) O Roof over 7/2 Ok = 0.85 x 7/2 2.6	
	G= 0.85 x 7/2 3.0	
	Qx = 0.75 × 1/2	
	3.02.6	
	Total upu on bean = 3.0+2.6 = 5.6 ku/m	
	Reaction = 5.6 x 11.5 = 32 km	
	Max. moment: 5.6 x 11:5 = 92:6 cm 3	
	Znegd = 92.6×103 = 51× cm3	
	180	- 1 AM. :
	Sall = 11500 = 32mm	
-	360	-
	Ireqd = 5x2.6 × 11500 = 661100 ×	. –
	36KXS10000X35	



Contract Killoon Convocated Products	Job ref.
Part of structure	Calc. Sheet No.
Drawing ref. Calculations by Checked by	Date 31/5/91


	1
Compression florge of boom is fully restrained > Poc = 180 w/mm2	Support Boom BI
A KOG X 178 X SK UB Will be adoquate	K06×178×5KUR
Padstone for BI	A776
Reaction from bean = 32 km, Beam to bear onto 215 mm block inner bof of proposed cavity wall. fur of doclared = 3.64/mm	
=) local losign strongth = 1.25 x 3.6 = 1.3 N/mm	
length of padstone required = 32×103 = 11×mm = 32×103 = 11×mm	Podstone for BI
Provide a kno bog x 215 wide x 215 dp conc-	xxl bng x 215 mid x 215 dp. cone pad store
	, , , , , , , , , , , , , , , , , , ,

KML

Contract Killoo	Corrugated	Product	Job ref.	
Part of structur	e		Calc. Sheet No.	
Drawing ref.	Calculations by	Checked by	Date 31/5/91	j

Members ref.	CALCULATIONS	OUTPUT
	3 Support Boom BZ	
	Span of Bean = 6:5m	
	Laadusq Gu Qu	
	O Roof over 1/2m Grand Str. 10 3.70 O - 0.25 x 7/2	
	$G_{-0.65} \times \frac{7}{2}$ 3.0	
	$Q_{u} = 0.75 \times \frac{7}{2}$	
	Total usc on 620m = 3.0 + 2.6 = 5.6 km/m	
	Reaction = 5.6 × 6.5 = 10 KN	
	2	
	Max Moment = 5.6x6.5 = 29.6km	
		
	$2\log d = 29.6 \times 10^3 = 165 \text{cm}^3$	
	180	
	<u>Sall = 6500 = 18.1 mm</u>	
	ARE ARE ARE	
	Tred : 2x 2.6x 6500 x = 159000 x	,
	Compression flonge of bean is fully	
MAY 1470 M	→ Pbc = 180n/mm²	Support Boom 82
	A 25KXIKEX3LUB will be adequate	52X×1K6"×3108"
		• •
	. See the second	


6.0 Lintols

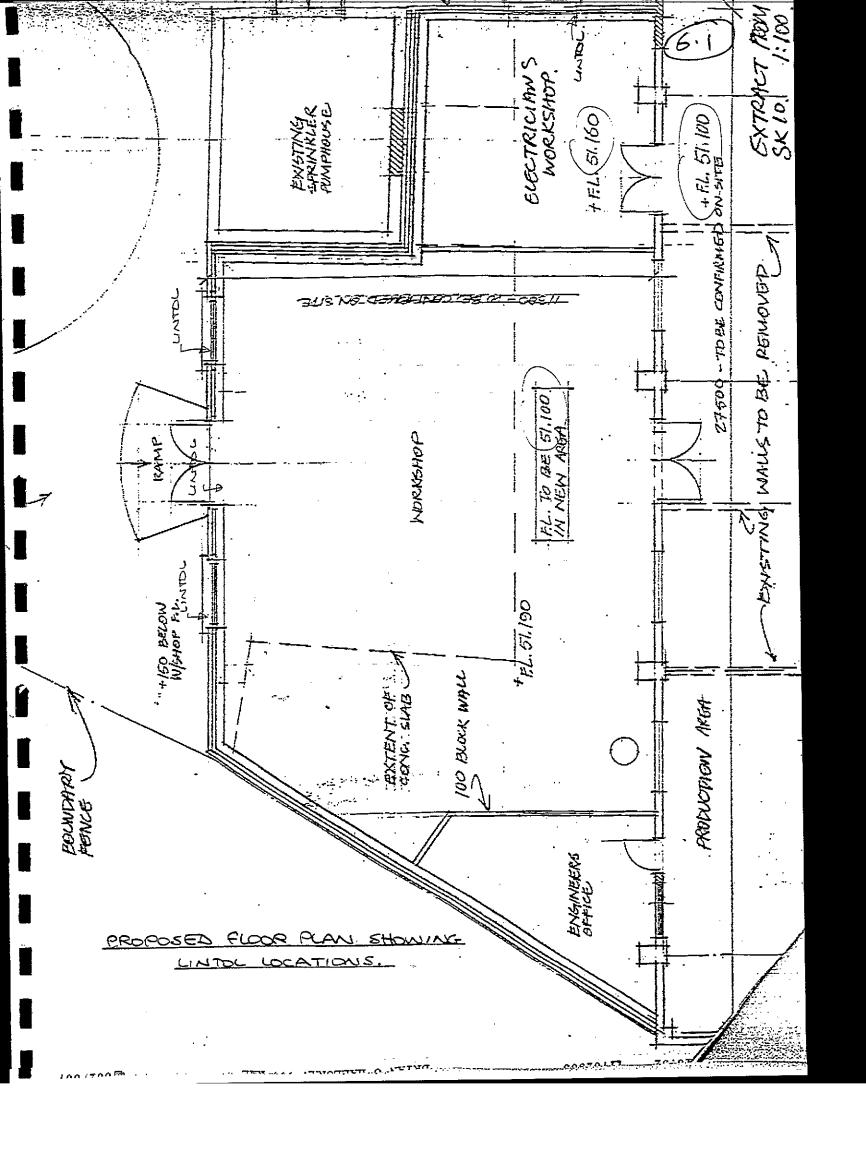





Contract	brugated	Roduct	Job ref. 591, 0.51	_
Part of structur	e		Calc. Sheet No.	_
Drawing ref.	Calculations by	Checked by	Date 31/5/91	,

lembers ef.	CALCULATIONS	OUTPUT
y49		
0d 8		=
	lintols	
	Max spon of liable 2.5m	
		•
	Laading :	P
	DRact over 11.5/2m (kn/m) (kn/m)	
	Qu=0.75 x 113/2 200)	
	G. 26.55 x 2.0 13.10	
	3) Beam self-weight	
	a. ~ 0.5 Ku/m 0.50	
	The second secon	
	18-X5 X:31	
	The state of the s	er er
	Total use on bean = 10. Kg + K31 = 22.0 kg/m	
		i
	Max momont = 22.8 x 2.52 = 12.8 km m	
	Max mangot = 22.8 x 2.52 = 17.8 km m	
	Max mangot = 22.8 x 2.52 = 17.8 km m	
	Max mamont = 22.8 x 2.5 = 17.8 kn m 8 . Zread = 12.8 x 10 = 9900 3 180	
	Max mamont = 22.8 x 2.52 = 17.8 km m 8 2 read = 17.8 x 10 = 99 cm 3 180 Gall = 2500 = 2 mm	
	Max mamont = 22.8 x 2.5 = 17.8 kn m 8 . Zread = 12.8 x 10 = 9900 3 180	
	Max mamont = 22.8 x 2.5 = 12.8 kn m 2 reqd = 12.8 x 10 = 99cm 3 180 Sall = 2500 = 2mm 360	
	Max mamont = 22.8 x 2.52 = 17.8 km m 8 2 read = 17.8 x 10 = 99 cm 3 180 Gall = 2500 = 2 mm	
	Max mamont = 22.8 x 2.5 = 17.8 kn m 8 2read = 17.8 x 10 = 99 cm ³ 18D 6all = 2500 = 2mm 360 Inad = 5 x 22.8 x 2500 = 789 cm 4	
	Max mamont = 22.8 x 2.5 = 17.8 kn m Replace 17.8 x 10	
	Max mamont = 22.8 x 2.5 = 17.8 kn m 8 Zneqd = 17.8 x 10 = 99cm 3 180 Sall = 2500 = 2mm 360 Ineqd = 5 x 22.8 x 2500 = 789cm 384 x 210000 x 7 Try 2No. 178 x 102 x 19 UB Ipou: 2720cm x	
	Max mamont = 22.8 x 2.5 = 17.8 kn m Replace 17.8 x 10	
	Max mamont = 22.8 x 2.5 = 17.8 kn m Zneqd = 17.8 x 10	
	Max mamont = 22.8 x 2.5 = 12.8 km m 8 Zneqd = 17.8 x 10	Trace Lista
	Max mamont = 22.8 x 2.5 = 17.8 kn m Zneqd = 17.8 x 10	Typical listo !
	Max momont = 22.8 x 2.5 = 17.8 km m Zneqd = 17.8 x 10	
66le34	Max mangert = 22.0 x 2.5 = 17.0 km m 8 Zneqd = 17.0 x 10 = 99cm 3	2No. 178×102×
oble 34:	Max mangert = 22.0 x 2.5 = 17.0 km m 8 Zneqd = 17.0 x 10 = 99cm 3	2No. 178×102×
oble 34	Max momont = 22.8 x 2.5 = 17.8 km m Zneqd = 17.8 x 10	Tupical Lintol 2No. 178×102× 1908 to suppose inner leaf + 1 N 178×102×1902;

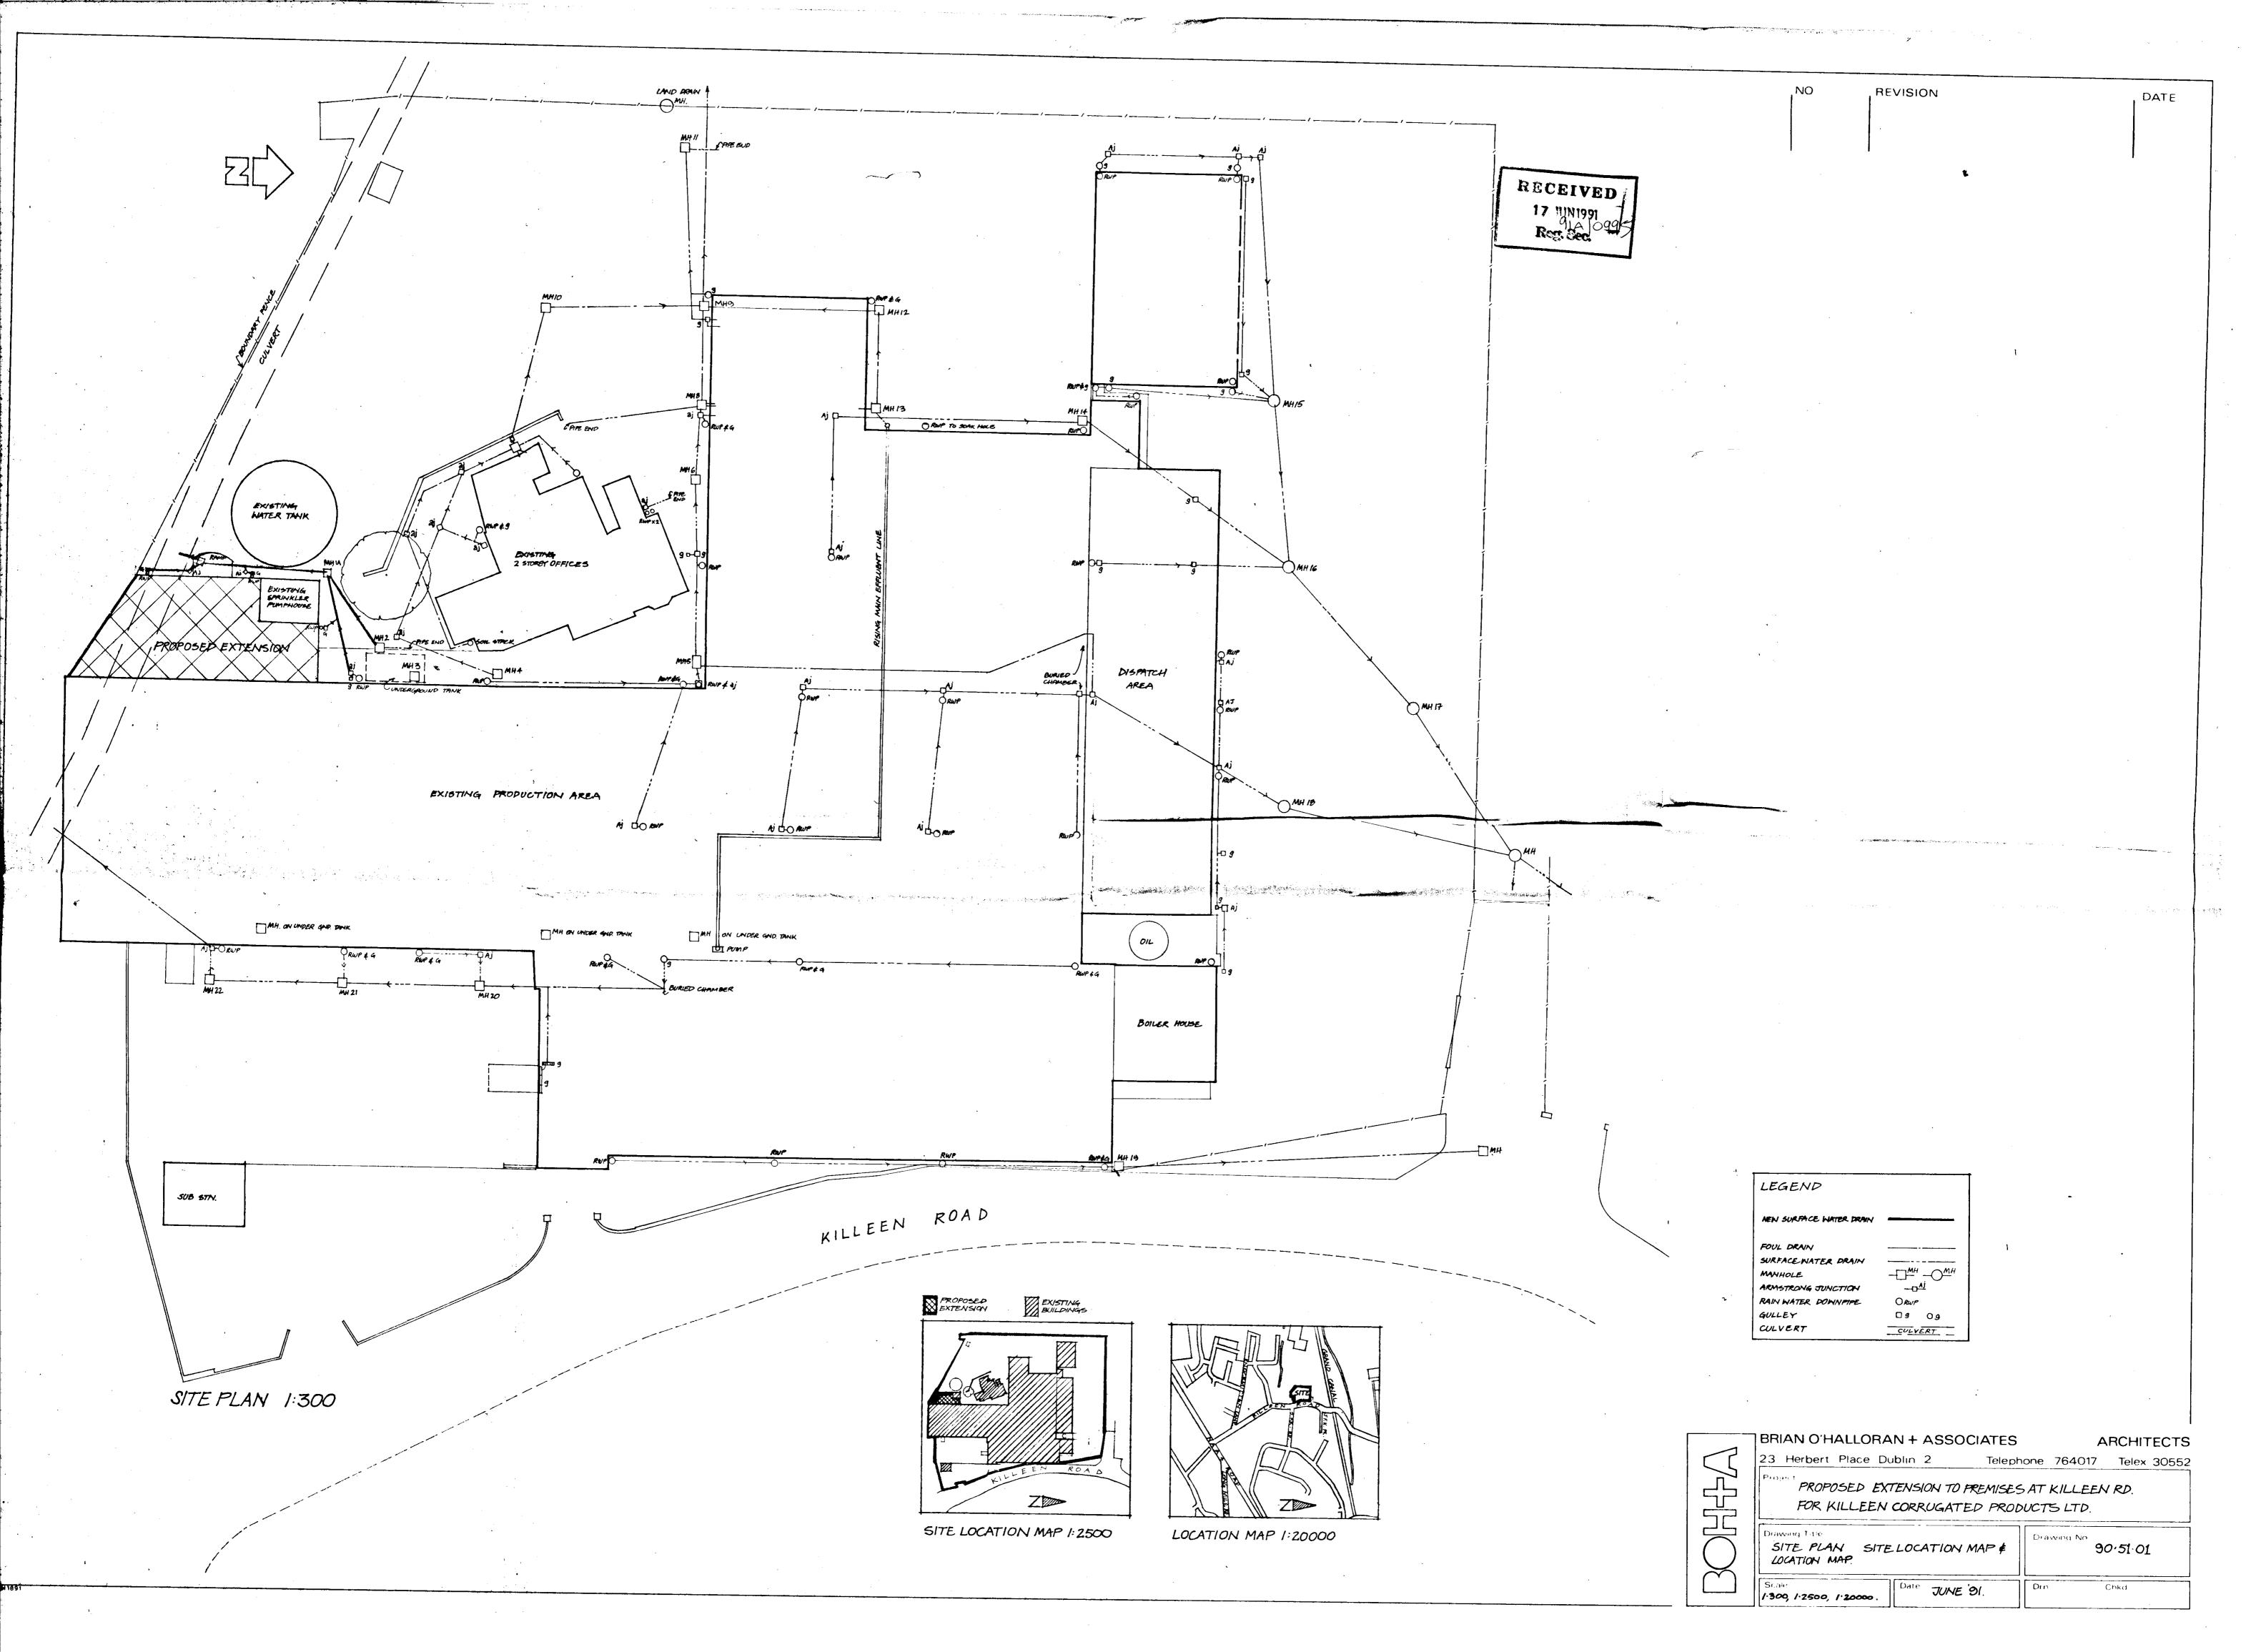

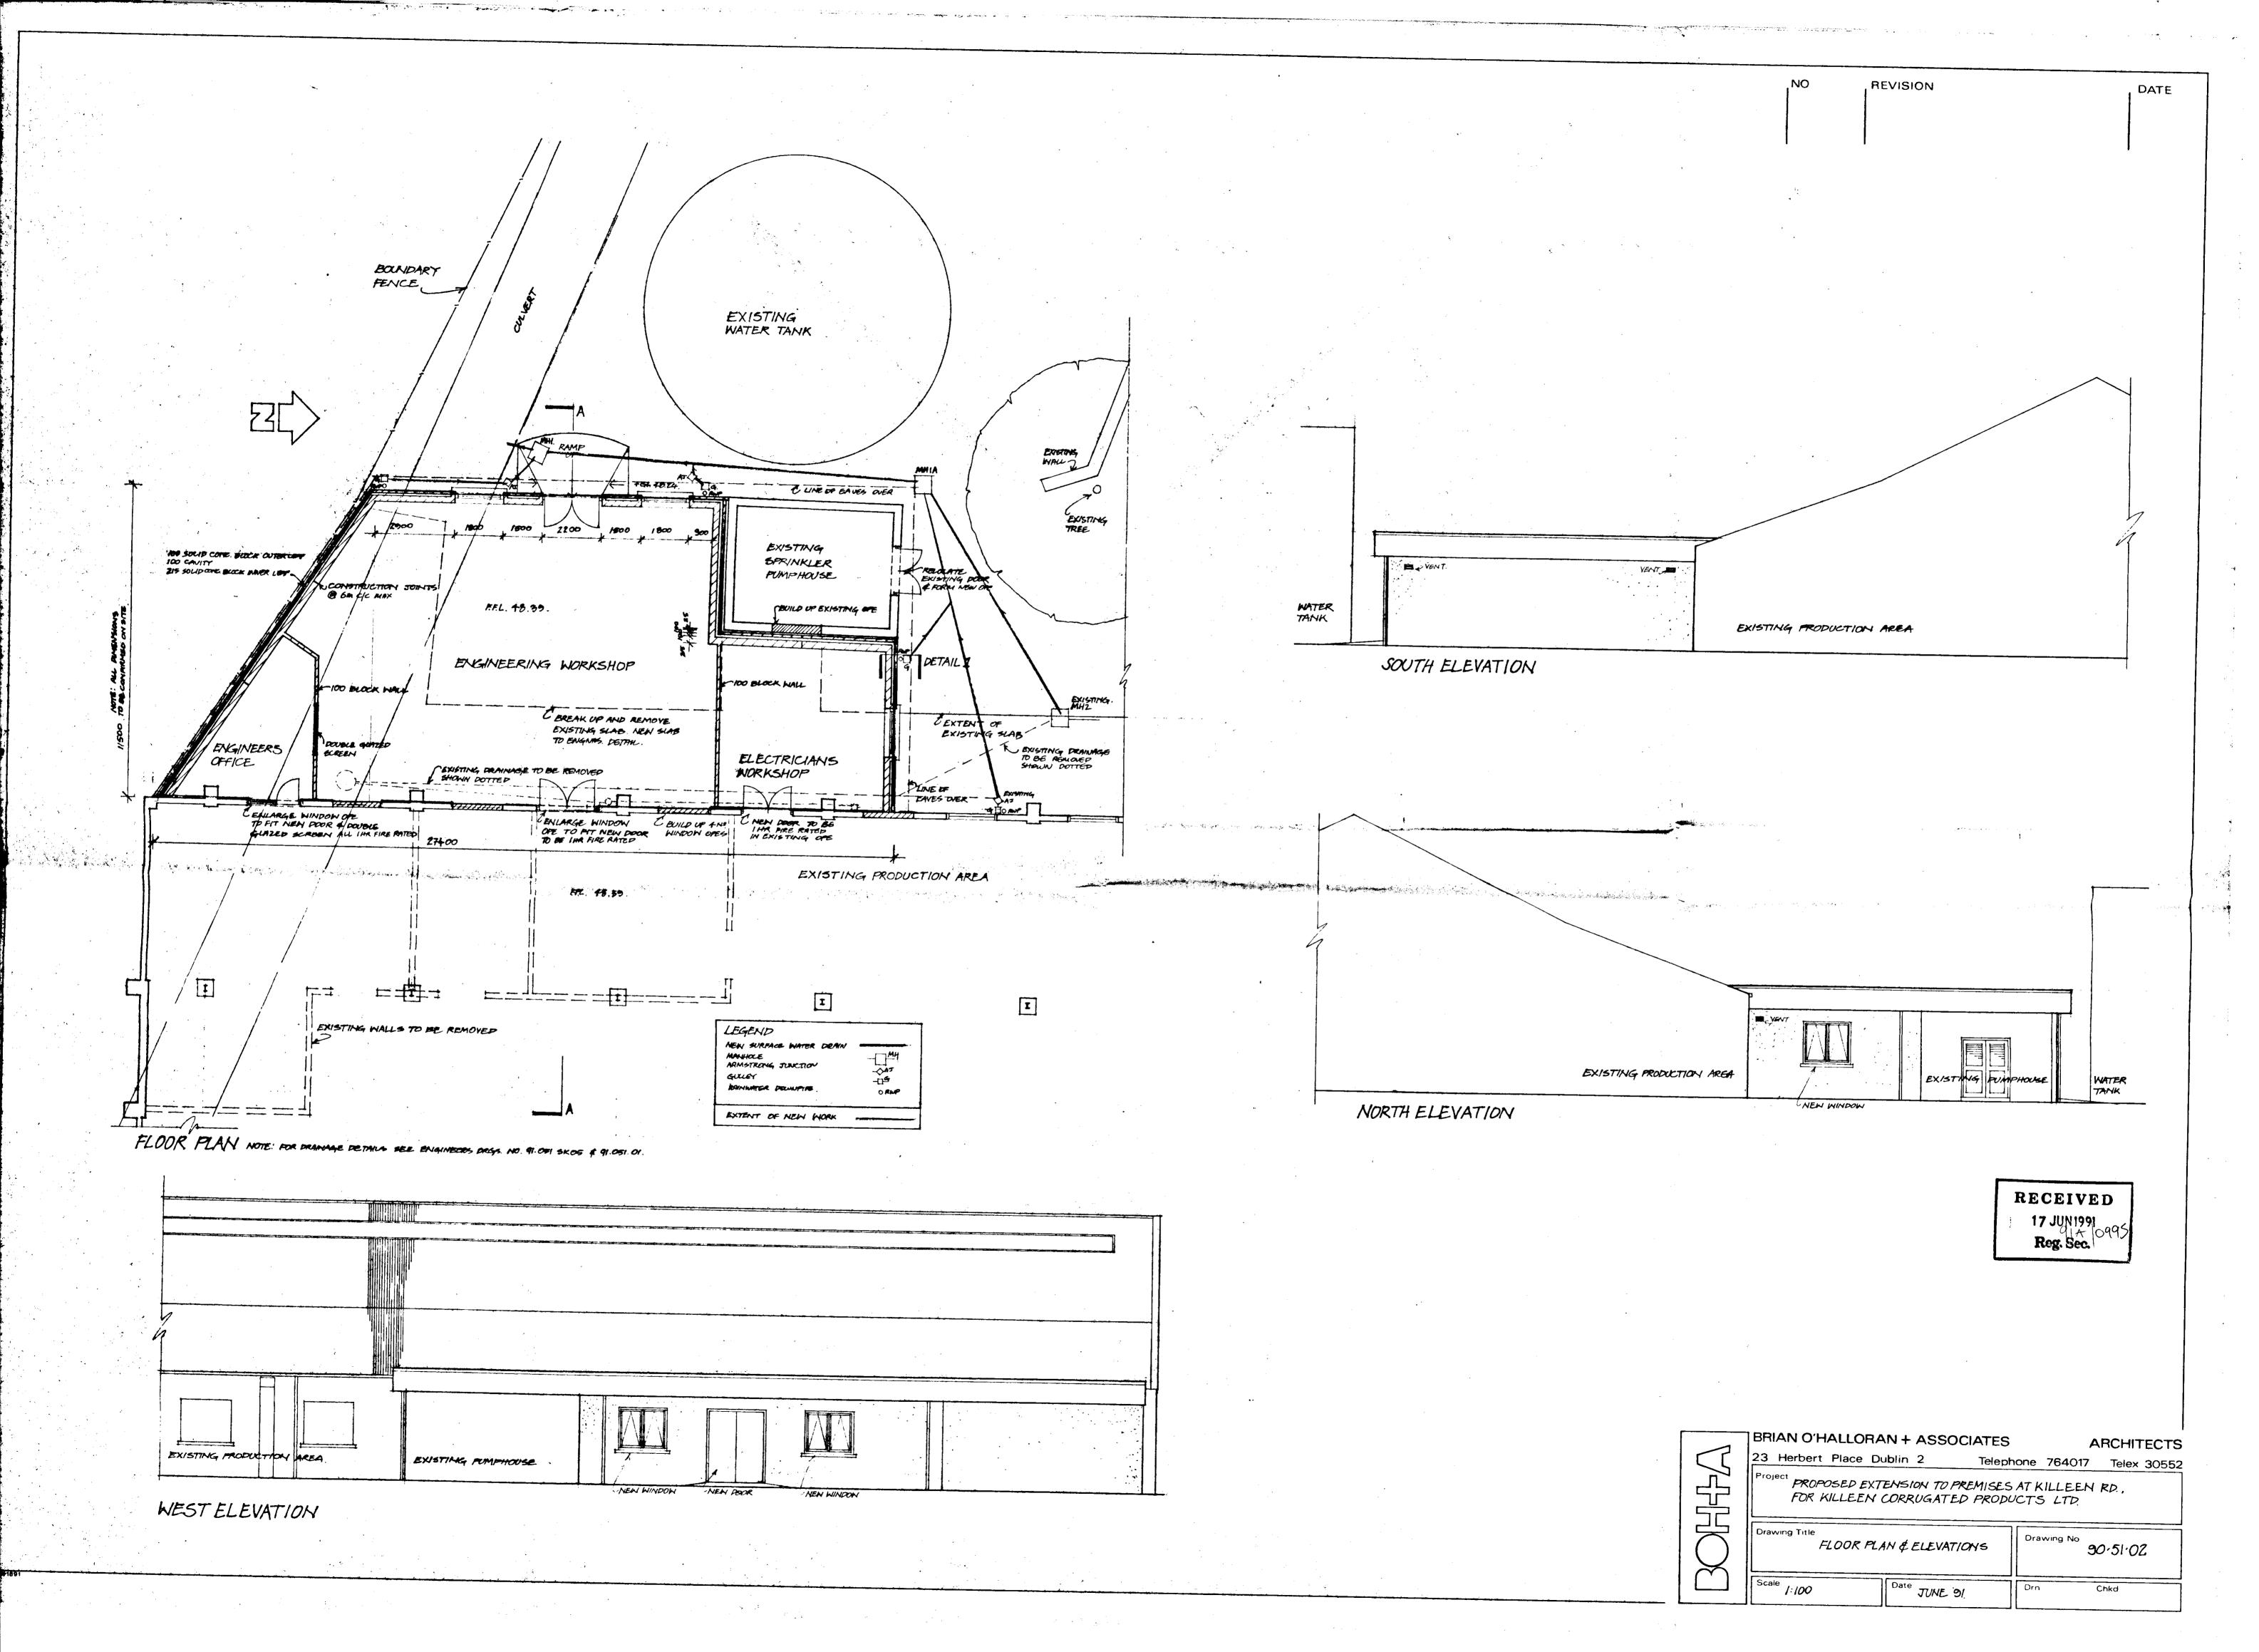

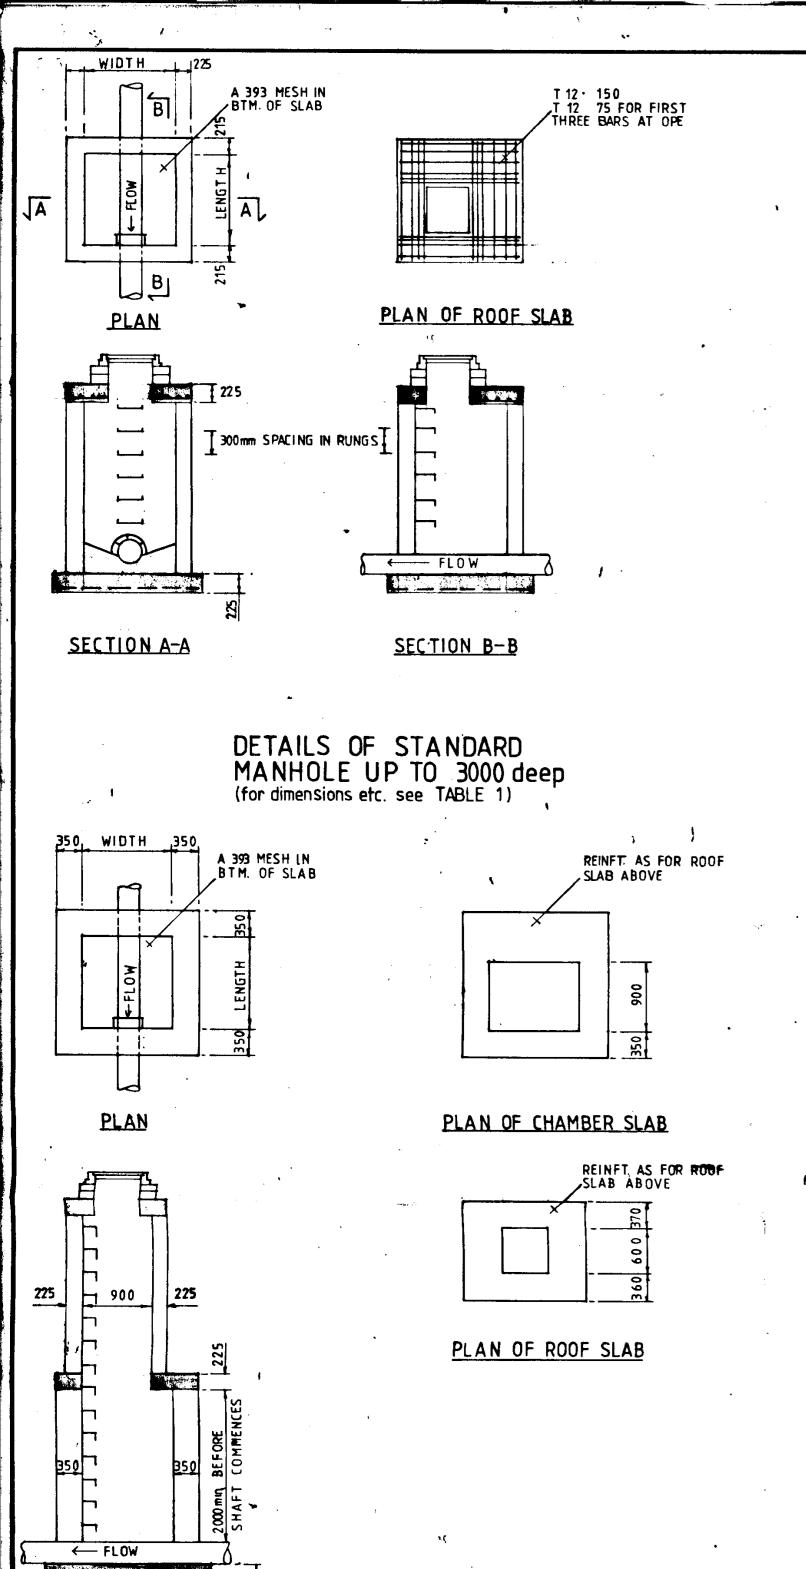

SECTION C-C

DETAILS OF STANDARD

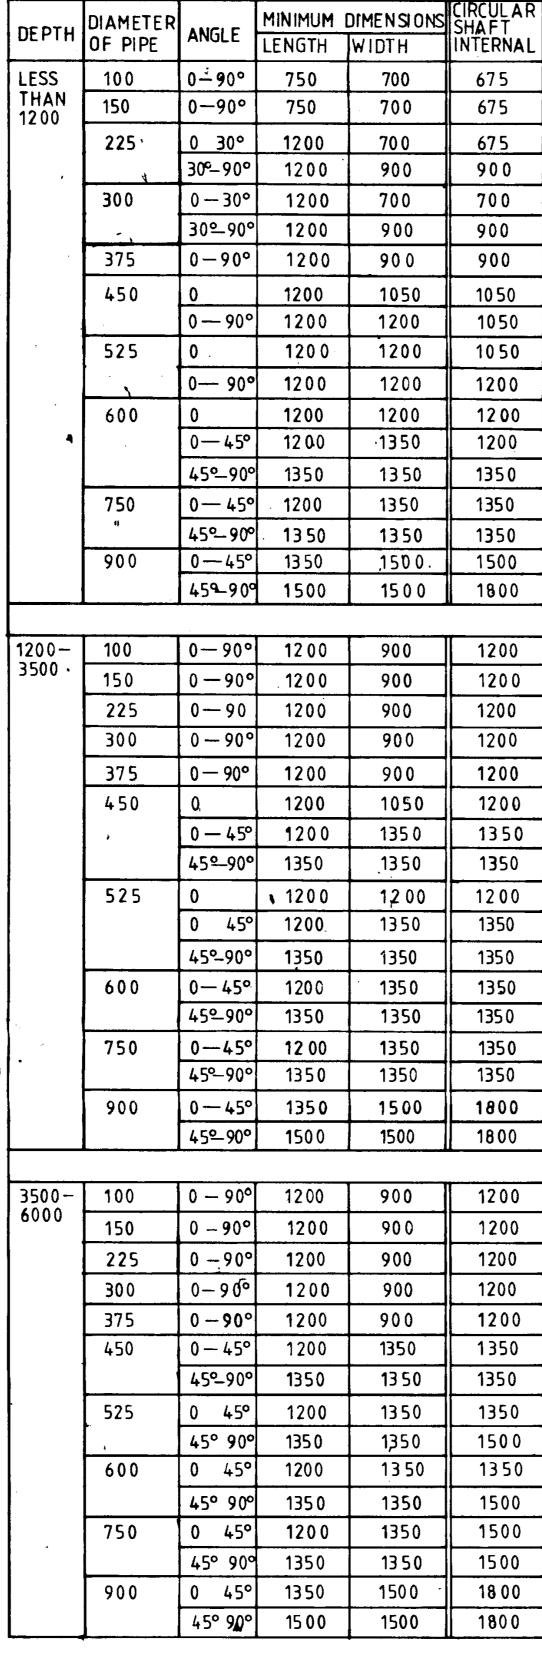


TABLE 1

<u> </u>	.		<u> </u>		
DEPTH	DIAMETER OF PIPE	ANGLE	MINIMUM LENGTH	DIMENSIONS WIDTH	CIRCULAR SHAFT INTERNAL
LESS	100	0 	750	700	675
1200	150	0-90°	750	700	675
	225	0 30°	1200	700	675
	4	30°-90°	1200	900	900
	300	0-30°	1200	700	700
		30°-90°	1200	900	900
	375	0-90°	1200	900	900
	450	0	1200	1050	1050
		0 — 90°	1200	1200	1050
*	525	0.	1200	1200	1050
		0— 90°	1200	1200	1200
•	600	0	1200	1200	1200
4		0—45°	1200	·1350	1200
		45°_90°	1350	1350	1350
	750 "	0— 45°	1200	1350	1350
		45°-90°	. 1350	1350	1350
	900	0 — 45°	13 50	,1500.	1500
		459 <u>-</u> 90°	1500	1500	1800
1200-	100	0-90°	1200	900	1200
3500 •	150	0 — 90°	. 12 0 0	900	1200
	225	0-90	1200	900	1200
	300	0 — 90°	1200	900	1200
	375	0 — 90°	1200	900	1200
	450	0,	1200	1050	1200
	,	0 — 45°	1200	1350	1350
		45 <u>°</u> 90°	1350	1350	1350
	525	0	1200	1,200	1200
		0 45°	1200.	1350	1350
		45°-90°	1350	1350	1350
	600	0-45°	1200	1350	1350
		45°-90°	1350	1350	1350
	750	0-45°	12 00	1350	1350
		45°-90°	1350	1350	1350
	900	0 — 45°	1350	1500	1800
		45°-90°	1500	1500	1800
3500-	100	0 — 90°	1200	900	1200
6000	150	0 - 90°	1200	900	1200
	225	0 - 90°	1200	900	1200
	300	0-96	1200	900	1200
	375	0-90°	•	900	1200
	450	0 — 45°	1200	1350	1350
	1	45°_90°		1350	1350
					1∎

MANHOLE TYPE	DIA OF	DROP	DIA OF DROP	×	
TYPE A	225	0-500	225	-	
В.		500-1000	225	225	
C		- 1000	225	225	
TYPE A	300	0-600	300	-	
В		600-1000	300	300	
C		- 1000	225	300	
TYPE A	375	0 - 750	450	_	
, В	5	750-1200	300	450	
С	•	- 1200	, 300 ·	300	
TYPE A	450	0 - 750	450		
В		750-1200	300	450	ŕ
D	•	- 1200	300	450	
TYPE A	525	0-750	525	_	
· В	:	750 1200	375	525	
D		- 1200	300	375	
TYPE A.	600	0-750	600		
В.		750 1500	375	375	
D		- 1500	375	375	
TYPE A	750	0-750,	600	_	
. В	750 ·	75Ò-1500	450	450	
- D		- 1500	375	450	

TABLE 2

NOTES


- 1 PRECAST CONCRETE MANHOLES SHALL HAVE 150mm CONCRETE SURROUND UNLESS MANUFACTURER CAN SHOW, TO THE ENGINEER'S SATISFACTION THAT PERMANENTLY WATERPROOF JOINTS CAN BE ACHIEVED BY SOME OTHER METHOD
- 2 FOR 750mm Dia. PIPES OR GREATER, USE A SAFETY CHAIN AND PROVIDE 25 mm Dia. GALV. SOLID BAR HANDRAILS AT EDGES OF BENCHING
- 3 STEP RUNGS TO BE PROVIDED IN MANHOLES MORE THAN 1m DEEP
- 4 WALLS TO MANHOLES TO BE AS FOLLOWS: FOUL MANHOLE
- MASS CONCRETE GRADE C30 TO BS 8110 OR SOLID BLOCKWORK FACED WITH ENGINEERING BRICKWORK
- SURFACE WATER MANHOLE
- MASS CONCRETE OR SOLID CONCRETE BLOCKWORK
- 5 MANHOLE COVERS & FRAMES ARE JO BE IN ACCORDANCE WITH IS 261 OR BS 497 Carriageways Grade A

Grade C

Footpaths & Public grassed areas Areas inaccessible to wheeled vehicles


Grade B


- 6 IN MANHOLES WHOSE PIPE DIAMETER IS GREATER THAN 375, ONE BENCHING SHOULD BE AT LEAST 400 WIDE
- 7 BENCHING TO BE OF CLASS C20 CONCRETE FINISHED WITH 2 to 1 SAND / CEMENT MORTAR

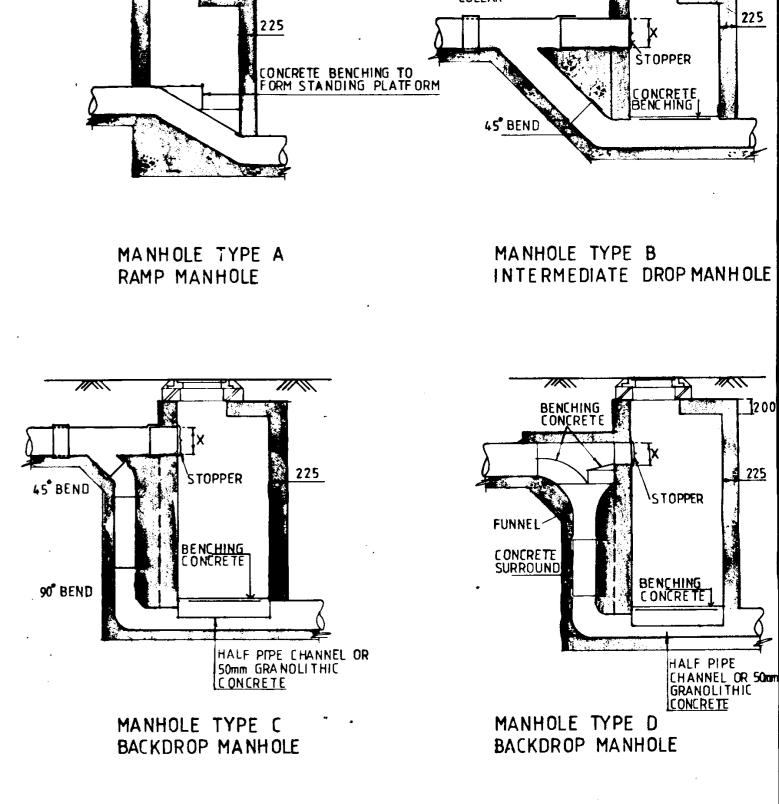

CONCRETE SURROUND TO FRAME AND COVER (TYPICAL)

For dimensions etc. to manholes type A,B,C+D see Table 2

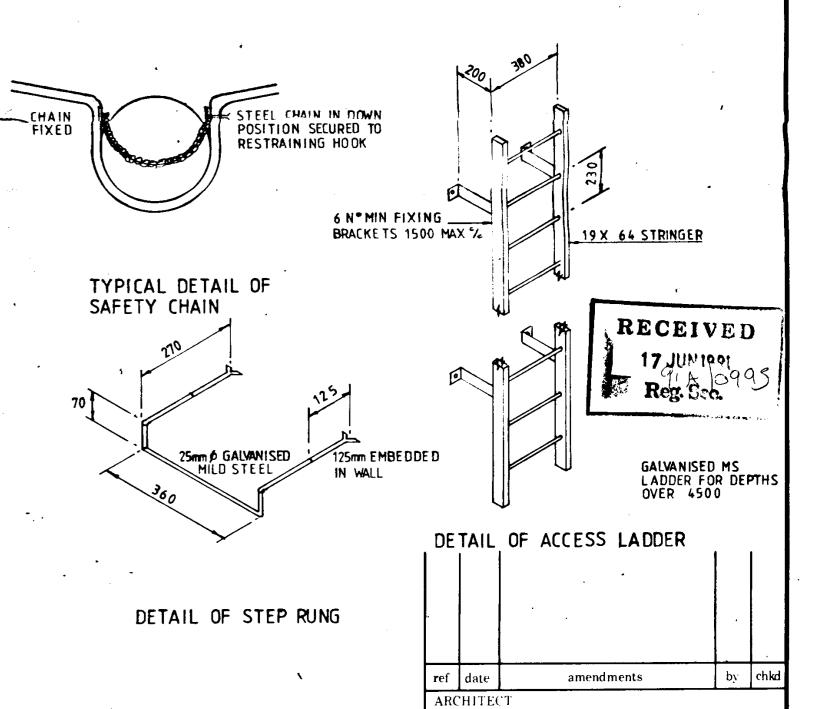

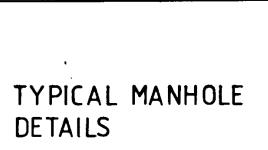

scale NOT TO SCALE

Telephone 908963/6

drg.no.

NOT FOR CONSTRUCTION

