## ASSESSMENT OF FINANCIAL CONTRIBUTION

EG. REF.:

CAT. REG.:

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OTAL ASSESSMENT

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### BYE LAW APPLICATION FEES

REF. NO.:	910847		CERTIFICATE NO.: _	15 340
,,,,,,,,,,,,,,,,,,,,,,,,,,,,,,,,,,,,,,,	Day con	h = tooA d =	shop/Stone	Buildy
PROPOSAL:	Petrol Filly Sta	tion including		0
LOCATION:	Tymon/Bullorlory	Distributor Ro	oad West of	Sicil Josen
ATTLICANT:	R. Maetin	· · · · · · · · · · · · · · · · · · ·		

	1	2		3	4	5	6	7
CLASS	DWELLINGS/AREA LENGTH/STRUCTURE	RATE		OF FEE	AMT. LODGED	BALANCE DUE	RED. FEE APPL.	AME. OF RED. FEE
A	Dwelling (Houses/Flats)	@ £55						
В	Domestic Ext. (Improvement/ Alts.)	@ £30						
С	Building for office or other comm. purpose 105.50	@ £3.50 per M <sup>2</sup> or £70		371.00	1 360 .5	10-5	0	
D	Building or other structurn for purposes of agriculture	@ £1.00 per M <sup>2</sup> in excess of 300 M <sup>2</sup> Min. £70	7					
E	Petrol Filling Station	@ £200	-4	2 <del>00</del>	1200			
F	Dev. of prop. not coming within any of the forgoing classes	£70 or £9 per .1 hect. whichever is the greater						

Column 1	Certified:	Signed:	Jimo		D/TE	Date: 30	15,	191
				<i>M</i> ade:	· ·	Date: _		
	Endorsed:	Signed:		Dive	0.0	29	5/0	7/
Columns	2,3,4,5,6 &	7 Certified:	Signed:	Grade	: 200	Daice: }		,
::olumns	2,3,4,5,6 &	7 Endorsed:	Signed:	Grade		Date:_		· ·

### ICCATION COVERNMENT (FLANKING AND DEVELOPMENT) ACTS, 1983 TO 1982

### ASSESSMENT OF FINANCIAL CONTRIBUTION

REG. REF.:

CONT. REG.:

SERVICES INVOLVED: WATER/FOUL SEMEN SUEFACE WATER

AREA OF SITE:

FLOOR AREA OF PRESENT PROPUSAL: MALLE CARROL SECTION TO

YEASURED EX:

CHECKED BY:

METHOD OF ASSESSMENT: The Common of Marian Conference of the Confe

TOTAL ASSESSMENT

MANAGER'S CROSTED NO: F/

ENTERED IN CONTRIBUTIONS REGISTER: (1) 61/4

PENTIONED CONTROL ASSISTANT GRACE

### Dublin County Council Comhairle Chontae Atha Cliath

### **Planning Department**



Bloc 2, Ionad Bheatha na hEireann, Block 2, Irish Life Centre, Sraid na Mainistreach Iacht, Lower Abbey Street, Baile Atha Cliath 1. Dublin 1. Telephone. (01)724755 Fax. (01)724896

Register Reference: 91A/0847

Date : 30th May 1991

Dear Sir/Madam,

Development : Alterations to the already approved canopy and shop/

store building at the already approved petrol filling

station

LOCATION : Site fronting south side of Tymon/Balrothery

Distributor Road and west of Scoil Iosa at Tymon

North, Tallaght

Applicant : R. Martin

App. Type : PERMISSION/BUILDING BYE-LAW APPROVAL

Date Recd : 24th May 1991

Your application in relation to the above was submitted with a fee of 280.25.

On examination of the plans submitted it would appear that the appropriate amount should be 285.50 .

I should be obliged if you would submit the balance of 5.25 as soon as possible as a decision cannot be made on this application until the correct fee is received.

Yours faithfully,

PRINCIPAL OFFICER

Ryan O'Brien Handy Associates, 6 Percy Place, Dublin 4.

## COMHAIRLE CHONTAE ATHA CLIATH

### DUBLIN COUNTY COUNCIL

	•
INCORRECT FEE WITH BYE LAW APPLICATION	
TELEPHONE: 724755	
EXTENSION: 231/234	PLANNING DEPARTMENT,
FAX.: 724896	IRISH LIFE CENTRE,
	LOWER ABBEY STREET,
Ryan O'Brien Handy Associates,	DUBLIN 1.
6 Percy Place.	——————————————————————————————————————
Dublin 4.	31/5/91
	· 
<del></del> .	
REG. REF.: 91A/0847	
RE: New Petrol Filling Station including	shop/store building at Tymon/Balrothery
Distributor Road, West of Scoil Issa	For R. Martin.
· · · · · · · · · · · · · · · · · · ·	
Dear Sir/Madam,	• •
<b>,</b>	
I refer to your application for Bye Law	approval in respect of the above proposal.
I wish to inform you that the Planning A	uthority will not commence to consider the
application until the appropriate fee is	paid. If no fee or a fee less than the
appropriate fee has been received by the	County Council on the expiration of two
months, commencing on the day the applic	ation is received, the application will be
regarded as having been withdrawn.	
The correct fee for the above mentioned	application is £ <u>185.50</u> .
Please quote the Register Reference No.	stated above when submitting the fee.
AMOUNT LODGED = £180.25	

Yours faithfully,

for PRINCIPAL OFFICER

# COMHAIRLE CHONTAE ATHA CLIATH

## DUBLIN COUNTY COUNCIL

INCORRECT FEE WITH BYE LAW APPLICATION TELEPHONE: 724755		<b>.</b>	•
EXTENSION: 231/234	PLANNING DEPA		
FAX.: 724896	irish life CE Lower Abbey S		
	DUBLIN 1.	illigii,	
Ryan O'Brien Handy Associates,			
6 Percy Place,	74 12 100		
Dublin 4.		1 1	
REG. REF.: 91A/0847	<u>.</u>		
RE: New Petrol Filling Station including	ng shop/store built	ling at Tymon/Bal	<del>rotherry —</del>
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Distributor Road, West of Scoil Is	es for A. Hertin.	- <u>-</u>	
Dear Sir/Madam,	r · · · · · · · · · · · · · · · · · · ·	·	
Dear Sir/Madam,	v approval in respe	ct of the above	proposal.
Dear Sir/Madam,  I refer to your application for Bye Law	v approval in respe Authority will not	ct of the above	proposal. sider the
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for PRINCIPAL OFFICER

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Date : 8/10/91 Register Reference : 914 847 Development: Petrol Filling Station and shop store building : Tynan Babothery Distribution Rd, West of Scon R. Mostur SUBLIN COLIVER COUNCIL 31 pet 1891 ENVIRONMENTAL HEALTH Planning Officer : ' Date Recd. : 245 91 Attached is a copy of the application for the above development . Your report would be appreciated within the next 28 days. PLANNING DEPT. Yours faithfully, DEVELOPMENT CONTROL SECT Date ...... 12.11.91 PRINCIPAL OFFICER I HOVE no objection to his pun provided that 1. Mechanically aided & intime vention be provided to the lattry of the Sanitary accommodation to give 2 air changes per hous. 2. The stores and all parts of me fremises to be alequately Veninlated. 3. Denting water to be supposed directly from the rising Main 4. Compliance room the Pool Figure Recursions 1950/89. 5. Compliance with the snops conditions of Employment Act 1938 Ota Derine - SUPER ENVIRON. HEALTH OFFICER
33 GARDINER PLACE, Jeten wheling DUBLIN 1. 7/11/91

Register Reference : 918 847

Date : 8/10/91

endorsed	DATE
<del></del>	Refer to CPO.
WATER SUPPLY.	No details of water supply submitted
	No details of Hydraul lafout Enternitted
	Applicant to submit these details.
	R.J. Epan
	VS ullin
********	······································

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#### DIBLIN

#### PLANNING AND BUILDING CONTROL DEPARTMAENT

Senior Environmental Health Officer, 33 Gardiner Place.

Register Reference: 91A/0847

Date : 27th May 1991

Development: Alterations to the already approved canopy and shop/ store building at the already approved petrol filling station

: PERMISSION/BUILDING BYE-LAW APPROVAL

LOCATION

App. Type

: Site fronting south side of Tymon/Balrothery

Distributor Road and west of Scoil Iosa at Tymon

North, Tallaght

Applicant : R. Martin

SEVELOPMENT CONTROL S. . . . . .

. ANNING DE.

Planning Officer:

Date Recd. : 24th May 1991

Attached is a copy of the application for the above development .Please ensure that your report is received within 5 weeks from 24th May 1991.

Yours faithfully,

PRINCIPAL OFFICER

Ro attatehed

I have no objection to this plan provided that melamaily aided extract ventilation be previded 1. It the bolly of the Sanitey accommodation to gri Lawi Change per ha.

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DUBLIN COUNTY COUNCIL

7 JUN 1991

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Tomphanie with the Shaps Castilian of Employment act.

#### DUBLIN COUNTY

### PLANNING AND BUILDING CONTROL DEPARTMAENT

Senior Environmental Health Officer, 33 Gardiner Place.

Register Reference: 91A/0847

Date : 27th May 1991

Development : Alterations to the already approved canopy and shop/ store building at the already approved petrol filling

LOCATION

: site fronting south side of Tymon/Balrothery Distributor Road and west of Scoil Iosa at Tymon North, Tallaght

Applicant : R. Martin

: PERMISSION/BUILDING BYE-LAW APPROVAL App. Type

Planning Officer:

Date Recd. : 24th May 1991

PLANNING DEPT.

DEVELOPMENT CONTROL SECT

Attached is a copy of the application for the above development .Please ensure that your report is received within 5 weeks from 24th May 1991.

Yours faithfully,

PRINCIPAL OFFICER

Re attatebeel.

I have no objection to this plan provided that rechanging aided extract ventilation be pravided 1. It the bolly of the Sanitary accommodation to grie Zouri

and all faints of the premier. all store in are allequatedy

Drenky water, is sufflied denictly

DUBLIN COUNTY COUNCIL

7 JUN 1991

ENVIRONMENTAL HEALTH

#### DUBLIN COUNTY COUNCIL

REG. REF:

91A/0847.

DEVELOPMENT:

Alts. to the already approved canopy and

shop/store at petrol filling station.

LOCATION:

Tymon/Balrothery Distributor Road.

APPLICANT:

R. Martin.

DATE LODGED:

24.5.91.

This application is for full permission for alterations to the already approved canopy and shop/store building at the already approved petrol filling station at Tymon/Balrothery Distributor Road and west of Scoil Iosa at Tymon North, Tallaght.

The proposal is for minor alterations with no change to the original access design. No Roads objection subject to the Conditions of the original Report.

- 1) Southeast boundary of screen wall to be relocated on a curve. Details to be agreed with Roads. This is in order to provide better access to the car park extension in the funeral home site.
- 2) Intensity, number and location of light fittings along frontage with public road to be agreed with Roads.
- 3) A Roads contribution of £2,733 towards improvement of road network in the area.

MA/BMcC 25.6.91. PLANNING DEPT.

DEVELOPMENT CONTROL SECT

Bate ... 27.06.91

Time ... 10.30

SIGNED: Michael Attains	ENDORSED:	E Nadde_
DATE: 26-49/		26 m/mag1

ON 9135

CONTRIBUTION:

Roads:

3 Sers:

Other:

Open Space:

Standard: 1980

# COMHAIRLE CHONTAE ATHA CLIATH

# Record of Executive Business and Manager's Orders

alterations to

Permission for already approved canopy and shop/store building at the already approved petrol filling station, at site fronting south side of Tymon/Balrothery Distributor Road and west of Scoil SECURITY: Bond / C.I.F.: Iosa at Tymon North, Tallaght. Caşh:

Ryan O'Brien Handy Assocs., 6 Percy Place,

Dublin 4.

Reg. Ref. App. Recd:

Floor Area: Site Area:

Zoning:

91A/0847

24.05.1991

103 sq. m 1,350 sq. m.

Report of the Dublin Planning Officer, dated 17 July 1991

alterations to This is an application for PERMISSION for already approved canopy and shop/store at the already approved petrol filling station, at the site fronting south side of Tymon/Balrothery Distributor Road and west of Scoil Iosa at Tymon North, Tallaght.

The area in which the site is located is zoned with the objective "to provide for new residential communities" in accordance with approved Action Area Plans (A1). The use proposed is acceptable in such a zoning.

The history of the site is as follows:-

90A-625 -Permission granted for the Petrol Filling Station (Not yet built).

90A/622 - Permission for housing on adjacent site.

90A/623 - Permission for Funeral Home on adjacent site.

The main changes in the current proposal are with regard to elevational treatment of the shop area and canopy. The floor area has been rearranged and very slightly enlarged. The previous proposal was for a rendered finish with lined courses, and plastic coated metal decking on the roof.

The current proposal is for a structure of solid appearance, using a forticrete split fluted block, which the architect informs me will be white. The new 'set' canopy will be in light grey polyester powder coated aluminium, with white illuminated lettering.

The Roads Department have no objection to the proposal, subject to 3 conditions.

I recommend that a decision to GRANT PERMISSION be made under the Local Government (Planning and Development) Acts, 1963-1990 subject to the following ( ) conditions:-

# COMHAIRLE CHONTAE ATHA CLIATH

## Record of Executive Business and Manager's Orders

alterations to

Permission for already approved canopy and shop/store building at the already approved petrol filling station, at site fronting south side of Tymon/Balrothery Distributor Road and west of Scoil Iosa at Tymon North, Tallaght.

#### CONDITIONS

- 1. The development to be carried out in its entirety in accordance with the plans, particulars and specifications lodged with the application, save as may be required by the other conditions attached hereto.
- 2. That before development commences, approval under the Building Bye-Laws be obtained, and all conditions of that approval be observed in the development.
- 3. That the south east boundary of screen wall to be relocated on an curve and details of this change to be agreed with County Council Roads Department. This is in order to provide better access to the car park extension in the adjoining funeral house site.
- 4. Intensity, number and location of light fittings along frontage with public road to be agreed with Roads Apply a bubble to come a
- 5. A Roads Contribution of £2,733. shall be paid towards the improvement of the road network in the area.
- That planting strips shall be suitably stocked and maintained at all times.
- That all other conditions of the permission granted by Order No.
  P/4768/90 (Reg. Ref. 90A/625) shall be

complex with apply. nave as may be required by ey other conditions attached to

this permission-

REASONS FOR CONDITIONS

- 1. To ensure that the development shall be in accordance with the permission and that effective control be maintained.
- 2. In order to comply with the Sanitary Services Acts, 1878-1964.
- 3. In the interest of the proper planning and development of the area.
- 4. In the interest of the proper planning and development of the area.
- 5. In the interest of the proper planning and development of the area.
- 56. In the interest of the proper planning and development of the area.
- In the interest of the proper planning and development of the area.

CONDITIONS CONTINUED OVERLEAF

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### COMHAIRLE CHONTAE ÁTHA CLIATH

# Record of Executive Business and Manager's Orders

Permission for already approved canopy and shop/store building at the already approved petrol filling station, at site fronting south side of Tymon/Balrothery Distributor Road and west of Scoil Iosa at Tymon North, Tallaght.

CONDITIONS

That a financial contribution in the sum of £1,980. be paid by the proposer to the Dublin County Council towards the cost of provision of public services in the area of the proposed development and which facilitate this development; this contribution to be paid before the commencement of development on the site.

That a financial contribution in the sum of £2,733. be paid by the proposer to the Dublin County Council towards the cost of road improvements in the area of the proposed development and which facilitate this development; this contribution to be paid before the commencement of development on the site.

The provision of such services in the area by the Council will facilitate the proposed development. It is considered reasonable that the developer

reasonable that the developer should contribute towards the cost of providing the services.

The provision of such services in the area by the Council will facilitate the proposed development. It is considered reasonable that the developer should contribute towards the cost of providing the services.

Note-Compliance with one are more of the conditions of this permission may result in material alterations to the development as unhally proposed, and accordingly, may require the submission of a furthe planning application.

luj

# COMHAIRLE CHONTAE ATHA CLIATH

## Record of Executive Business and Manager's Orders

Permission for already approved canopy and shop/store building at the already approved petrol filling station, at site fronting south side of Tymon/Balrothery Distributor Road and west of Scoil Iosa at Tymon North, Tallaght.

(GB/BB)

Endorsed:-\_\_\_

for Principal Officer

For Dublin Planning Office

Order:-

A decision pursuant to Section 26(1) of the Local Government (Planning and Development) Acts, 1963-1990, to GRANT PERMISSION for the above proposal subject to the ( $\zeta$ ) conditions set out above is hereby made.

Dated:

2V July, 1991.

ASSISTANT CITY & COUNTY MANAGER

to whom the appropriate powers have been delegated by Order of the Dublin City and County Manager, dated 8th July, 1991.

Geraldhia B.

#### DUBLIN COUNTY COUNCIL

REG. REF:

91A/0847.

**DEVELOPMENT:** 

Alts. to the already approved canopy and

shop/store at petrol filling station.

LOCATION:

Tymon/Balrothery Distributor Road.

APPLICANT:

R. Martin.

DATE LODGED:

24.5.91.

This application is for full permission for alterations to the already approved canopy and shop/store building at the already approved petrol filling station at Tymon/Balrothery Distributor Road and west of Scoil Iosa at Tymon North, Tallaght.

The proposal is for minor alterations with no change to the original access design. No Roads objection subject to the Conditions of the original Report.

- 1) Southeast boundary of screen wall to be relocated on a curve. Details to be agreed with Roads. This is in order to provide better access to the car park extension in the funeral home site.
- 2) Intensity, number and location of light fittings along frontage with public road to be agreed with Roads.
- 3) A Roads contribution of £2,733 towards improvement of road network in the area.

MA/BMcC 25.6.91.

0111

SIGNED: Merhael Arthur	ENDORSED:_	E Madden
DATE: 26-6-9/	DATE:	26 ch / une g1

# Dublin County Council Comhairle Chontae Atha Cliath

### **Planning Department**



Bloc 2, Ionad Bheatha na hEireann, Block 2, Irish Life Centre, Sraid na Mainistreach lacht, Lower Abbey Street, Baile Atha Cliath 1. Dublin 1. Telephone. (01)724755 Fax. (01)724896

Mr. J. Carson, Liffey House, Dublin 2.

Our Ref.

Your Ref.

Date 15.10.91

Re: Development at Tymon Worth, Tolleight

Reg. Ref. No. : 91A 847

I refer to the submission for Building Bye-Law Approval received in this Department on 8.10.91.

The submission is in compliance with conditions of Building Bye-Law Approval issued. Please confirm that the submission is strictly compliance as requested and not a new application and accordingly that a Bye-Law fee is not required. Documents enclosed.

STAFF OFFICER,
REGISTRY SECTION

.

91A 847 1.3.0 BBL Comf

ND/AMcA/3225

4th October 1991

Attention: Mr John Carney.

Building Control Section Planning Department Block 2 Irish Life Centre Lower Abbey Street Dublin 1.





Ryan O'Brien Handy Associates

6 Percy Place Dublin 4 Telephone 680 899

Facsimile 680 089

PETROL FILLING STATION AT TYMON/BALROTHERY, DISTRIBUTOR RD, TYMON WORTH, TALLAGHT, DUBLIN 24. REG.NO: 91A/847, B.B.L./2591/91.

Dear Sir

We enclose three copies of our revised drawing no: 3225/04, showing the alterations to the drainage layout as requested.

We have also indicated the watermain layout, as agreed with Dublin County Council.

Yours faithfully

NOEL DOYLE

encls.

cc: Mr L. Spain Mr M. Fleming 111 Wellington Street Luton LU1 5AF

Partners
Denis Handy
DIP ARCH MRIAI MSDI
JOHN McCarthy
DIP ARCH MRIAI MSDI
ASSOCIATES
Denis Whelan
RIAI (TECH)
Kenneth McEwan
BSC (HONS)
Noel Doyle

BOOK:	FOLIO:	_ BBL No	REG. No <sup>90B/870</sup> :
I/WE hereby give you notice that		tion with new <u>E</u>	Chienvann.
VusuBURDING	CONTROL	_are now complete	e, and await inspection  Mc Was
COUNTY ENGINEER	N 1991	Idress: 15 Ton	
DUBLIN COUNTY COUNCIL BUILDING CONTROL DEPT., BLOCK 2,	IVED	Tel. Nov: 5 13	662/(088-874625)
IRISH LIFE CENTRE, LR. ABBEY STREET, DUBLIN 2.		-	Sryan

**DUBLIN COUNTY COUNCIL** 

Per anal Callers/ Liffey House 24/28 Tara Street Dublin 2 Telephone 773066

**BUILDING BYE LAWS** 

**APPROVAL NOTICE** 

Address for
Correspondence:
Building Control Section
Planning Dept.
Block 2
Irish Life Centre
Lower Abbey Street
Dublin 1

Application received:

24/5/1991, 20/6/1991 & 27/6/1991

Applicant:

R. Martin

Submitted by:

Ryan O'Brien Handy Assocs., 6 Percy Place, Dublin 4.

Reg. No.:

91A/847

Order No.:

BBL/2591/91

Proposal:

Petrol Filling Station incl. storey/shop building

Location:

Tymon Balrothery Distributor Road, West of Scoil Iosa.

Notice is hereby given that the Council has approved the plans submitted by you for the work described above subject to the following conditions:

- (1) That the applicant submits the statutory notice of commencement and completion of work in accordance with Bye Law no's 114 and 117. Premises should not be occupied until the requirements of these Bye Laws have been fulfilled.
- (2) The applicant must comply with the requirements of the Chief Fire Officer where applicable.
- Note A The Chief Fire Officer's requirements include the provisions of Parts, N, P, Q and R of the Proposed Building Regulations issued by the Department of the Environment.
- Note B The Applicant is advised to comply with the provisions of the Proposed Building Regulations issued by the Department of the Environment.
- (3) That all work be in accordance with Dublin County Council's Building Bye Laws.
- (4) That w.c. cubicles and kitchen be provided with windows in accordance with the Building Bye Laws.
- (5) That foul sewer line F.C. to F.B. be increased to 225mm diameter.
- (6) That steel beam be upsized to span unrestrained.
- (7) That adequate cill D.P.C. and lintol D.P.C. tray be provided.
- NOTE: In relation to the boundary walls the applicant's attention is drawn to the requirements of I.S.325 Code of Practice for the Structural Use of Unreinforced Masonary, produced by The National Standards Authority of Ireland.
- (8) That prior to commencement of construction, the applicant submits the following:
  - (a) Watermain layout (Consult with Mr. P. Harty, Dublin Co. Council Ph. 570784)
  - (b) Revised drainage layout showing petrol and mud interceptors connected to surface water drains and revised surface water outfall to local 525mm pipe.
- Important (1) It is illegal to proceed with the approved work until permission or exemption under the Local Government (Planning & Development) Acts has been obtained.
  - (2) At least two clear days notice in writing must be given to the Building Control Section,
    - (a) of the date on which execution of the work will be commenced.
    - (b) before proceeding with the covering up of any drain or the filling in any foundation.
  - (3) Any liability or consequential loss arising from the omission or misrepresentation of existing services, which affect the site, on the lodged plans is the responsibility of the applicant.

Date:

5 SEP 1991

Senior Administrative Officer

N.B. Inspection forms are attached for completion and return to Senior Engineer, Dublin County Council, Building Control Section, Block 2, Irish Life Centre, Lr. Abbey Street, Dublin 1, when the work reaches the stage set out in the relevant forms, not less than 2 clear days before the inspection is to be made. Where

2591

## COMHAIRLE CHONTAE ATHA CLIATH

## DUBLIN COUNTY COUNCIL

	914/847	DATE:	2/9/91	<u>.</u>
REG. NU.:	24/5/91, 20 2 Filling Statio	16/91 & 2	7/6/91	- 12 · · · · · · · · · · · · · · · · · ·
PROPOSAL: Petro	e Filling Itatio	- includ	ne phop b	Julding
LOCATION: Lymon	Balotten push	nould read	e, West of Seril	I Jose
APPLICANT: R	Martin.		<i>V</i>	
Notice of approval is carried out to o	under the Building Bye comply with the following	-Laws may be issu g conditions:	ed provided work	
1 2	works be -	allordan	e est De	el BAZZ-
3 Theo the	i 1 0	a telan	le provid	dod
I That W	c cubicles & dous à accor	druce wi	Ath BB	に .
with we	dous in accord	7 5	t FB le	
5. That	foul news &	ne f	diameter.	
fred In	teel beam	be ufsiz	red to Afan	
& That is	ained.	DPC 0	to DOCK	in de
1 1015 00	teel beam ined.	Ind link	oe prev	
, , , , , , , , , , , , , , , , , , , ,	<b>7</b>			<i></i>
from con	in to Common	went went	To the state of th	100
8 Jon de l	til & Char	tand ing	war (IV	
submitted	in to Comment of the Sent of sent is afflicant is the same	g ord by	the JCC B	B20.
Vote: Brands	of walls are no	sdired &	Confly with	215325
the fire	tion 5 rans	٥.		;K1G

# **DUBLIN COUNTY COUNCIL**

Tel. 724755 (ext. 262/264)

IMPORTANT: Turn overleaf for further information

PLANNING DEPARTMENT, BLOCK 2, IRISH LIFE CENTRE, LR. ABBEY STREET, DUBLIN 1.

### Notification of Decision to Grant Permission/

Local Government (Planning and Development) Acts, 1963-1983

To Ryan O'Brien Handy Associates,	Number and Date
6, Percy Place,	
Dublin.4	Planning Control No
	Application Received on
Applicant R. Martin.	Floor Area: 103 sq. m.
the County Health District of Dublin, did by Order dated as about	
alterations to already approved canopy a approved petrol filling station, at site Tymon/Balrothery Distributor Road and we Tallaght.	nd shop/store building at the already fronting south side of st of Scoil Iosa at Tymon North,
SUBJECT TO THE FOLLOWING CONDITIONS	·
CONDITIONS	REASONS FOR CONDITIONS
1. The development to be carried out in its entirety in accordance with the plus particulars and specifications lodged the application, save as may be required by the other conditions attached heretones.	with accordance with the ed permission and that
<ol> <li>That before development commences, approval under the Building Bye-Laws h obtained, and all conditions of that approval be observed in the development</li> </ol>	1878-1964.
3. That the south east boundary of scrwall to be relocated on a curve and details of this change to be agreed in writing with County Council Roads Department. This is in order to provibetter access to the car park extension the adjoining funeral house site.	development of the area.
4. Intensity, number and location of I fittings along frontage with public roto be agreed in writing with Roads Department of Dublin County Council.	4. In the interest of the proper planning and development of the area.
(Continued)	
Signed on behalf of the Dublin County Council	For Principal Officer  Date 22/3/91

#### REASONS FOR CONDITIONS

- 5. That planting strips shall be suitably stocked and maintained at all times.
- 6. That all other conditions of the permission granted by Order No. P/4768/90 (Reg. Ref. 90A/625) shall be complied with save as may be required by other conditions attached to this permission.
- 7. That a financial contribution in the sum of £1,980 be paid by the proposer to the Dublin County Council towards the cost of provision os public services in the area of the proposed development and which facilitate this development; this contribution to be paid before the commencement of development on the site.
- 8. That a financial contribution in the sum of £2,733 be paid by the proposer to the Dublin County Council towards the cost of road improvements in the area of the proposed development and which facilitate this development; this contribution to be paid before the commencement of development on the site.

NOTE: Compliance with one or more of the conditions of this permission may result in material alterations to the development as initially proposed and, accordingly, may require the submission of a further planning application.

- 5. In the interest of the proper planning and development of the area.
- 6. In the interest of the proper planning and development of the area.
- 7. The provision of such services in the area by the Council will faciliate the proposed development. It is considered reasonable that the developer should contribute towards the cost of providing the services.
- 8. The provision of such services in the area by the Council will faciliate the proposed development. It is considered reasonable that the developer should contribute towards the cost of providing the services.

### NOTE:

If there is no appeal to An Bord Pleanala against this decision PERMISSION/APPROVAL will be granted by the Council as soon as may be after the expiration of the period for the taking of such appeal. If every appeal made in accordance with the Acts has been withdrawn, the Council will grant the PERMISSION/APPROVAL after the withdrawal.

An appeal against the decision may be made to An Bord Pleanala. The applicant may appeal within one month from the date of receipt by him of this notification. ANY OTHER PERSON may appeal within twenty-one days beginning on the date of the decision.

An appeal shall be in writing and shall state the subject matter and grounds of the appeal. It should be addressed to:—An Bord Pleanala, Blocks 6 and 7, Irish Life Centre, Lower Abbey Street, Dublin 1.

(1) An appeal lodged by an applicant or his agent with An Bord Pleanala will be invalid unless accompanied by a fee of £36 (Thirty-six Pounds). (2) A party to an appeal making a request to An Bord Pleanala for an Oral Hearing of an appeal must, in addition to (1) above, pay to An Bord Pleanala a fee of £36 (Thirty-six Pounds). (3) A person who is not a party to an appeal must pay a fee of £10 (Ten Pounds) to An Bord Pleanala when making submissions or observations to An Bord Pleanala in relation to an appeal.

Approval of the Council under Building Bye-Laws must be obtained and the terms of the approval must be complied with in the carrying out of the work before any development which may be permitted is commenced.





Ryan O'Brien Handy Associates

6 Percy Place Dublin 4

Telephone 680 899 Facsimile 680 089

ND/MR/3225

101

26th June 1991

Dublin County Council, Planning Department, Block 2, Irish Life Centre, Lower Abbey Street, DUBLIN 1.

### ALTERATIONS TO ALREADY APPROVED CANOPY AND BUILDING AT TYMON/BALROTHERY DISTRIBUTOR ROAD, TYMON NORTH, TALLAGHT, DUBLIN 24. REGISTER REFERENCE NO. 91A/0847

Dear Sir,

I enclose copies of the structural calculations for the proposed building and canopy in relation to the above development.

If you have any questions relating to these calculations please contact this office.

Yours faithfully,

NOEL DOYLE

RECEIVED

27 JUN1991

91 A / D847

Reg. Sec.

111 Wellington Street Luton LU1 5AF

Partners
Denis Handy
DIP ARCH MRIAI MSDI
John McCarthy
DIP ARCH MRIAI MSDI

Associates
Denis Whelon
RIAI (TECH)
Kenneth McEwan
BSC (HONS)
Noel Doyle

#### ARTHUR W. WEST & ASSOCIATES

#### **CONSULTING ENGINEERS**

Arthur W. West, B.A.I., C. Eng., M.I.E.I. Roger P. West, B.A.I., M.Sc., D.I.C., C.Eng., M.I.E.I.

Our Ref: 858

Your Ref:

25 Cambridge Road,
Rathmines,
Public 6.
Telephone: 977197.

27 JUN199!
Reg. Sec.

Date: 24.6.9/

JET PETROL FILLING STATION

TYMON/BALROTHERY ROAD, TALLAGHT.

ARCHITERTS: Ryan of Brien Handy.

Refer to our Dig No. 858/3995.

Roof Loadings:

Spanot joists 13 pr.

$$M = \frac{1}{8} \times 60 \times 13^{2} + 12 = 15,200 \text{ inlhs.}$$
  
Using  $B'' \times 2'' \in 12'' \text{ c/s}$   $M \circ R = \frac{1}{6} \times 2 \times 8^{2} + 750$   
 $= 16,000 \text{ inlhs.}$ 

SPAN of Roof Beam 20 FV.

Load/ Fr = 13+60 = 7801/18.

$$M = \frac{1}{8} + \frac{780}{240} \times 20^{1} + 12 = 209$$
  $Z = \frac{209}{10.5} = 19.9$ 

Use. 10"453/4" + 21 U.B.

Pier Reaction = 780 +10 = 7800 /ls.

Provide 750+215 +200 deep concrete pad on pier +wall

Average compressive eress = 7800 = 32 lbs/0" (27/0") Schiskeling

30+8

FOUNDATIONS. TO 750 x 415 RISING Pier

Root Loan = 7800 /42

Dead wt Pier 12'+2.5'+1+150 = 4500

Local from Linkol over ope = 12+600 = 7200 /19,500 /kg.

Pres load apread into foundations over length 2.5 + 27 2.0 = 6.5 for

Using 1.1 x 300 deep Foundations remforced with H.T. Mesh 60 100; 7 e 200

Average ground Pressure = 19,500 = 833 /1/21

Subject to site confirmation = . 37 /d' Satistackry

LINTOL OVER WINDOWS DOOR Ope at Front 20'x20'

Dead wt of cone = 20+20 x = 400 l/s/h

Parapet = 2'+8 +144 = 200 600 /61

H=1/0 + 600 + 112+12 = 87,120 in 16

Az = 87,120 = 0.2 89.ins Use 3 No. 12 mm bars top & bo Hom.

Stirrups - nominal 10 mm @ 300 cts.



### BERNARD FINNEGAN LTD.

CONSULTING ENGINEERS

5 MILLBROOK CLOSE, SALLYBROOK, GLANMIRE, CO. CORK. Telephone 021-822336. Fax No. 021-821776

CALCULATIONS

FOR

CANOPY

FOR

RONY MARTIN,

TYMON-BALROTHERY ROAD,

DISTRIBUTOR ROAD,

TALLAGHT,

DUBLIN 24



S.F.L. Engineering Ltd., Callan, Co.Kilkenny, Ireland.

23 May 1991.

# NOTES ON CALCULATIONS.

#### 1.0 LOADING

- 1.1 LIVE LOAD complies with B.S. Code of Practice CP. 3, Chapter V, Loading: Part 1 (1967): Dead and Imposed Loads (Metric Units).
- 1.2 WIND LOAD is calculated in accordance with B.S. Code of Practice CP. 3, Chapter V, Part 2, 1972, and B.R.E. Digest No. 284, Wind Loads on Canopy Roofs.

  Ground Roughness Category 3 has been assumed.

### 2.0 STEELWORK

- 2.1 STEEL BEAMS and COLUMNS are designed in accordance with B.S. 449, Part 2, 1969, and B.S. 5950, Part 5, 1987.
- 2.2 STEEL GRADE is Grade 43 A.
- 2.3 LIVE LOAD DEFLECTION of beams is limited to span/360.
  LIVE LOAD DEFLECTION of cantilevers is limited to span/180.
  LIVE LOAD DEFLECTION of edge of TWO POST CANOPIES is limited to Total Width/240.
- 2.4 DEAD LOAD DEFLECTION to be countered by cambering and / or shimming.
- 2.5 TORSIONAL RESTRAINT to be provided to beams at all connections.
- 2.6 FLANGES OF FASCIA BEAMS to be adequetely restrained against twisting and buckling.
- 2.7 JOINTS to be detailed to adequetely transfer all forces which occur.

#### 3.0 FOUNDATIONS

- 3.1 FOUNDATIONS are designed to B.S.8110, The Structural Use of Concrete, 1985.
- 3.2 CONCRETE grade is C 30.
- 3.3 REINFORCEMENT has Characteristic Strength of 460 N/m.m.^2
- 3.4 COVER to reinforcement is 50 m.m.
- 3.5 ALLOWABLE SOIL BEARING PRESSURE under foundations has been assumed as 100 KN/M^2. This should be reliably confirmed before foundations are built.

# BUILDER'S WORK DURING CANOPY ERECTION.


- 1. All water and dirt to be removed from holding down bolt tubes before columns are erected.
- 2. Column base plates are to be grouted by the Builder after columns are squared and plumbed.
- 3. Grout is to be a proprietary "non-shrink" cementicious grout, mixed and placed in accordance with manufacturers instructions.
- 4. A timber shutter is to be constructed to top of baseplate level as shown, before grouting commences.
- 5. Grout is to be fully worked into holding down bolt tubes and total area under baseplate.

BERNARD FINNEGAN LTD. CONSULTING ENGINEERS	VEERS PROJECT	
5 MILLBROOK CLOSE SALLYBROOK TEL 021-822336 GLANMIRE, CO. CORK. FAX 021-821776	General Details.  DRG. TITLE  Grouting Detail.	DRG.NO. /

RONY MARTIN, TALLAGHT, 23-5-91.

```
LOADING.
```

```
1. Superimposed Loading : 0.75 Kn/m^2. C.P.3. Chapter V
2. Dead Loading
                        : 0.15 Kn /m^2. Deck, Purlins, Soffit
3. Fascia 1050 deep
        Weight/m.
                            0.22 km. / m.
                       =
4. Wind Loads.
    Basic Wind Speed
                               46 m./sec.
                              1.00
                 s_2
                              0.65 (Ground Roughness 3, Class B)
                 s_3
                              1.00
                 ۷s
                              29.9 m./sec.
                              0.55 \text{ kn./m}^2
                 đ
                            1.09 kn./m
0.16 kn./m<sup>2</sup>
-0.71 kn./m<sup>2</sup>
-0.27 kn./m<sup>2</sup>
   Fascia Horz. Load
                                            (Cp
                                                         1.9 )
   Wind Pressure
                        =
                                            ⊈2)
                                                         0.3)
   Wind Suction
                        =
                                            (Cp
                                                    =
                                                         -1.3 )blocked
   Wind Suction
                       =
                                            (Cp
                                                         -0.5 )unblock.
```

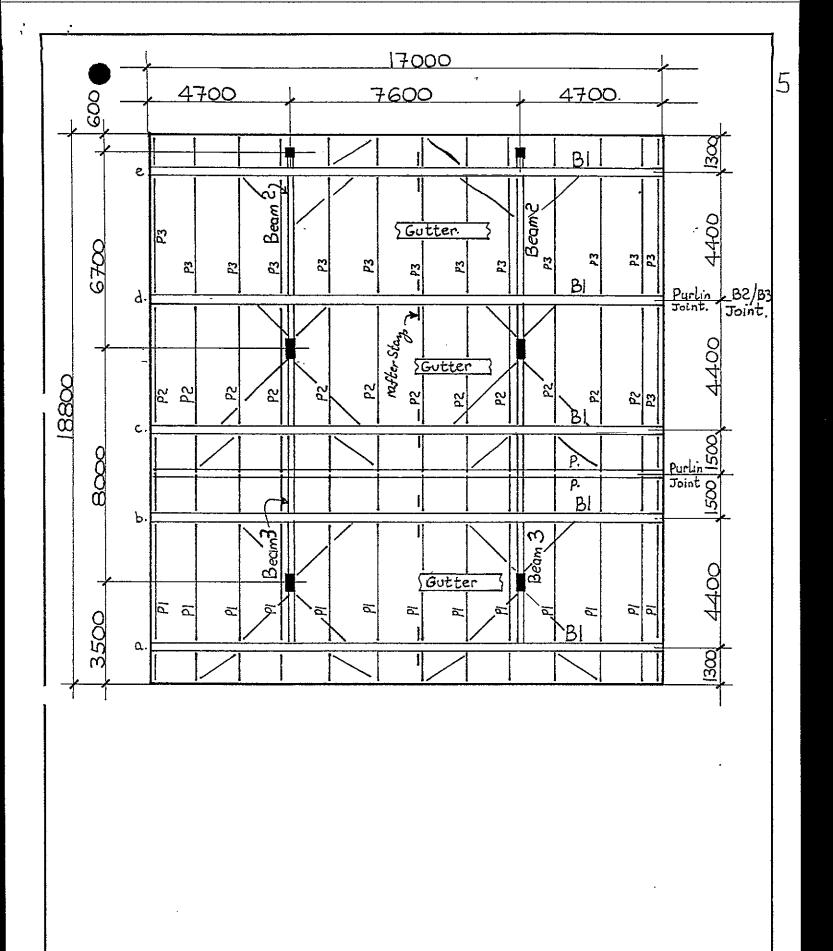

# BERNARD FINNEGAN LTD. CONSULTING ENGINEERS

5 MILLBROOK CLOSE SALLYBROOK GLANMIRE, CO. CORK.

TEL 021-822336 FAX 021-821776 S.F.L. Engineering Ltd.
PROJECT Rony Martin, Tallaght.
DRG. TITLE Roof Plan.

DRAWN BY B.F.

SCALE |: 125

DATE 23-5-91

DRG.NO. 211-1

BERNA	RD FINNEGAN LTD. Consulting Engineers. 021-822336						
JOB . F	Rony Martin Tallaght DATE: 23-5-91 PAGE: 6						
	Section Sizes						
	Fascia : 1050 x 1.5						
	Ht. to u/side 1 4200						
	Roof Purlin 1 55062 I						
	Purlins Pl, P2, P3 : 55062 ]. @ 1500 dc.						
*	Beams 1,3 : 356 x 171 x 45 (Stiffs at conns.) STAYS BI						
	Beam 2 1 254 x 146 x 31 ( do )						
	Main column: 400 x 200 x 10						
	Base plate: 600 x 400 x 20 Standard.						
	Rear Column 1 200 x 200 x 6.3						
	Main Found: 1 2000 x 2000 x 600						
	Rear Support: By others, see design forces below:						
	actual forces, on each rear column, at fascia level.						
	+ means down, forces in Kn, see page 17						
	$W$ $F_{\infty}$ $F_{\gamma}$						
	Case 1 31.6 2.15 0						
	Case 2 0.7 2.15 0						
	Case 3 1-14.0 0 0						
*	Bon I chille at some marter atoms						
<u> </u>	Beam 1: Stiffs at conns, rafter stays.  Beam 3: " " and at cols.						
	Beam 3 i " " and at cols."						
	·						

٠,

BERN	ARD FINNEGAN LTD.	Consulting	Engineers.	021-822336		
JOB .	Rony Martin		DATE: 23-4	5-91 PAGE: 7		
	9					
	Purlin					
	Strength Design.	1.21 km	1.49km. 1.	49km 1.01km.		
	D.L+ L.L.	(0.73)	i i	.24) (0.84)		
1500 c/c.	Pt1=15x0.22,	<u> </u>				
<u> </u>	+1.5 x.65 x.9			<b>1</b>		
	= 1.21 kn	1300	4400	1500		
	Pt2 = 1.5 x 1.1 x.9					
	= 1.49 km			<u>-</u>		
<b></b>	Pt 3 = 1.5 x .75 x .9 =	1-01 kn.				
		<u> </u>	<u> </u>			
	Deflection Design.					
· · · · · · · · · · · · · · · · · · ·	L.L. only.			· · · · · · · · · · · · · · · · · · ·		
	Pt1 = 1.5 x 0.65 x.75	Pt1 = 1.5 x 0.65 x.75 = 0.73 kg.				
	Pt 2 = 1.5 x 1.1 x.75					
	Pt3 = 1.5 x .75 x .75 = 0.84 kn.					
			<u>55062 (Pa</u>	ge 8)		
	Purlin 2	<u>.</u>				
	Strength Design. D.L+L.L	1011	1 401			
1500 dc	Pt1 = 15 x 0.75 x 0.9	1.01kn.	1.49			
100000	= 1.01  km	(0.84)	(1.24)	(i·24)		
	Pt2 = 1.49 km.		<u> </u>	<u> </u>		
	, october 1997		40	00		
	Deflection Design	_ · <u> </u>				
	L.L. only.			·		
	Pt   = 1.5 x .75 x.75 =	= 0.84 km		-		
	Pt2 = 1.24km					
	55062 (Page 9)					
			·			
,						

```
RONY MARTIN, TALLAGHT,
                   PURLIN 1
                                           23-5-91.
BEAM DESIGN.
                      CANTILEVER----SPAN----CANTILEVER.
                    1.30 m. (COLD ROLLED SECTIONS c )
4.40 m. Span.... 7.200 m.
1.50 m. Fascia... 1050 m.m.
Span 1 =
Span 2 =
Span 3 =
Pt.Load 1
                 1.21 Kn. (LL+DL)
                                         0.73 Kn.
                                                   (LL.)
Pt.Load 2
                  1.49 Kn. (LL+DL)
                                         1.24 Kn.
                                                   (LL.)
Pt.Load 2
Pt.Load 3
                  1.49 Kn. (LL+DL)
1.01 Kn. (LL+DL)
           =
                                         1.24 Kn.
                                                  (LL.)
                                         0.84 Kn.
Pt.Load 4
                                                   (LL.)
               TRY 55062 MULTIBEAM. 157.00 cm<sup>4</sup>.
       Ixx
             =
                22.32 cm<sup>3</sup>.
5.10 cm<sup>2</sup>.
       \mathbf{Z}\mathbf{x}\mathbf{x}
            =
       A
             =
                140.00 m.m.
       D
             =
                2.23 cm.
       Ry
             =
       t
                  1.58 m.m.
             =
                73.00 m.m.
DEFLECTION DESIGN.
______
                Span 2
d1 = 13.32
Span 1
                                 Span 3
                                        2.88
d1 =
          1.62
                               .d1 =
                        -3.57
d2
          -2.37 d2 =
                                d2 =
                                        -0.64
         -0.28 d3 =
                                 d3 =
                         -4.76
4.99
                                       0.87 Total Deflections
          -1.03
                        22.00
                                        8.33 Allow. Deflections
          7.22
                                                         5.02
STRENGTH DESIGN
Mo
                                         7.29 kn.m.
                                                         7.36
M1 = 2.49 \text{ Kn.m.}
                           Mb
     =
          4.81 Kn.m.
                          4.37 Mb
                                    =
                                         5.80 kn.m.
                                                        7.36
М2
           2.39 KN.m.
                          Mb
                                         6.99 kn.m.
                                                        7.36
M3
REACTIONS.
=======
                                  2.48 Kn.
                                             DL+LL.
   Ra =
          2.71 Kn.
                           Rb =
   Ra = 1.90 Kn.
                           Rb = 2.15 Kn.
                                             LL.
```

23-5-91.

BERNA	RD FINNEGAN LTD. Consulting Engineers. 021-822336
JOB .	Rony Martin Tallaght DATE: 23-5-91 PAGE: 10
	Purlin 3
	Strength Design. D.L+LL.
1500°/c	Pt = 1.5 x 1.1 x.9 1.49 km. 1.49 km. 1.21 km.
	= 1.49  km. $(1.24)$ $(1.24)$ $(0.73)$
	Pt2 = 1.21 kn.
	Deflection Design. 4400 1300
	L.L. only.  Pt 1 = 1.24 kn.
	Pt 1 = 1.24 kn.
	Pt 2 = 0.73 kn. 55062 (Page 11)
	0.97 km 0.97 km
	Beam 1 (0) 4.06 mm. (0)
	Strength Design Di.+LL. v (2.97)
	Pt 1 = 4.4 x 0.22
	= 0.97  km. $4700    7600    4700$
	U.Di = wont of a) 2.71/1.5 + (.65+1.1)x.9 +.45 = 3.83
	b) 2.48/1.5 + (.75 + 1.1) x.9 + .45 = 3.77
	c) $2.84/1.5 + (.75+1.1) \times .9 + .45 = 4.01$ d) $(1.14+1.13)/1.5 + (1.1+1.1) \times .9 + .45 = 3.94$
	e) $3.05/1.5 + (.65+1.1) \times .9 + .45 = 4.06 \text{ kg/m}$
,	C) 3.03/15 T (163 T111) X. [ + 143 - 1.00 UN /M.
	Deflection Design.
	L.L. only.
	Pt 1=0
	U.D.L= 2.37/1.5 + 1.85 x.75 = 2.97 Ku/m.
	ter
	356 × 171 × 45 (Page 12)

23-5-91.

```
RONY MARTIN, TALLAGHT,
                      CANTILEVER ---- SPAN ---- CANTILEVER .
BEAM DESIGN.
                    ========
                    (COLD ROLLED SECTIONS c )
Span.... 5.700 m.
Fascia... 1050 m.m.
Span 1 =
          0.00 m.
Span 2 =
          4.40 m.
          1.30 m.
Span 3 =
                 0.00 \, \text{Km}.
                                         0.00 Kn.
                                                  (LL.)
                          (LL+DL)
Pt.Load 1
            =
                  1.49 Kn. (LL+DL)
                                         1.24 Kn.
                                                  (LL.)
Pt.Load 2
            =
                  1.49 Kn. (LL+DL)
                                        1.24 Kn.
                                                  (LL.)
Pt.Load 3
            =
                                         0.73 Kn.
                  1.21 Kn.
                          (LL+DL)
                                                  (LL.)
Pt.Load 4
            =
               TRY 55062 MULTIBEAM.
               157.00 \text{ cm}^4.
       Ixx
             =
                 22.32 cm^3.
             = -
       \mathbf{Z}\mathbf{x}\mathbf{x}
                 5.10 cm<sup>2</sup>.
       Α
             ==
                140.00 m.m.
       D
             =
                2.23 cm.
       Ry
             =
                 1.58 m.m.
       t
                73.00 m.m.
DEFLECTION DESIGN.
______
                                Span 3
                 Span 2
Span 1
          0.00
                d1 =
                         13.32
                                d1 =
                                        1.62
d1 =
                                d2 =
                                        -2.37
          -0.00
                d2 =
                         -0.00
d2
                                d3 =
                                       -3.94
                 d3 =
                         -3.57
          -0.00
                               -4.69 Total Deflections
                        9.75
          -0.00
                                        7.22 Allow. Deflections
                         22.00
          0.00
5.02
STRENGTH DESIGN
                                                        Mo
7.36
                            Mb
                                         8.49 kn.m.
           0.00 Kn.m.
     =
           4.81 Kn.m.
                          4.50 Mb
                                    =
                                         5.80 kn.m.
                                                       7.36
M2
          2.49 KN.m.
                                         7.29 kn.m.
                           Mb
М3
REACTIONS.
=======
                          --- :2
                           Rb =
                                 3.05 Kn.
                                             DL+LL.
          1.13 Kn.
   Ra =
                          Rb =
                                2.18 Kn.
                                             LL.
          1.02 Kn.
   Ra =
```

PURLIN 3

```
RONY MARTIN, TALLAGHT, BEAM 1 23-5-91.
                   CANTILEVER----SPAN----CANTILEVER.
BEAM DESIGN.
=========
                   4.70 m.
Span 1 =
Span 2 =
         7.60 m.
         4.70 m.
Span 3 =
Pt.Load 1
U.D.Load
Pt.Load 2
                                   0.00 Kn. (LL.)
               0.97 Kn. (LL+DL)
               4.06 Kn/m.(LL+DL)
0.97 Kn. (LL+DL)
                                   2.97 Kn./m.(LL.)
                                   0.00 Kn. (LL.)
      try 356 x 171 x 45
            12091.00
                     cm^4.
   Ixx
                     cm~3.
              686.90
   Zxx
               3.78
  Ry
                     cm.
   D/t
               36.20
DEFLECTION DESIGN.
____==
               Span 2
                            Span 3
Span 1
              dl =
d2 =
         0.00
                      5.08
                            d1 =
                                    0.00
d1 =
                            d2 =
                                    7.13
         7.13
                      -4.78
đ2
    =
               d3 =
                            d3 =
         8.68
                      -4.78
                                    8.68
d3
    ==
                            d4 =
                                    4.34
d4
         4.34
-4.47 20.15 Total Deflections 21.11 26.11 Allow. Deflections
         20.15
                                   26.11 Allow. Deflections
         26.11
STRENGTH DESIGN.
-----
                        Stress at holes.
                                         Width
M1 = 49.40 \text{ Kn.m.}
                            96.84
                                         171.00
                            57.46
        29.31 Kn.m.
M3 = 49.40 \text{ KN.m.}
                            96.84
                            96.83
Moment = 49.40 \text{ Kn.m.}
       71.92 N/m.m.^2
Stress =
D/t =
        36.20
L/ry = 170.00
                                       > 3.8 m.
                  Maximum Effective Length
        6.43 m.
REACTIONS.
=======
Ra = Ra =
                            35.48 Kn. (LL+DL)
        35.48 Kn.
                    Rb
                            25.25 Kn. (LL)
         25.25 Kn.
                    Rb
                   ______
```

BERNARD FINNEGAN LTD. Consulting Engineers. 021-822336
JOB: Rony Martin Tallaght. DATE: 23-5-91 PAGE: 13
O O
Beam 2
Strength Design, D.L+L.L. 35.48 Km
Pt 1 = 35.48 kn. (25.25)
Deflection Design 4400 700
L.L. only 5100
Pt   = 25.25 km. Page 14
I regd = 941 cm4) I provided = 4439 cm4
O= 134x 165/353 = 63 N/mm, D/T= 29, l/m= 210
lemex = 210 x 33.5 = 7035 mm > 4400 mm
254 × 146 × 3i
Beam 3
Strength Design. 35.48km. 35.48km. 35.48km. 41.4km.  D.L+L.L. (25.25) (25.25) (25.25) (28.75)
$\begin{array}{c ccccccccccccccccccccccccccccccccccc$
pt4 = 35.48 + 5.9
= 41.4 km. 2200 8000 1600
Deflection Design.
L.L. only
Pt 1 = 25.25 kn = Pt 2,3
Pt 4 = 25.25 + 3.5 = 28.75 km.
D <sub>1</sub> = 6.96 mm, Dallow = 12.2 mm. 1/180
Page 15   Dz = 1.29 mm Dallow = 22.2 mm 4360
103 = 3.58 m.m Dallow = 8.9 mm 4180
Page 15  Trace = 113.5 N/mm, D/T = 36, L/ry = 105 Lemax = 108 × 37.8
lem = 4082 > 3000
Tholes = 171/127 × 114 = 153 N/mm < 165 N/mm. 356 × 171 × 45

.•

```
Begm 2 D.L+L.L.
  SPAN
     UDL , (KN / M.).... .4
  P1 (Kn.)..... 35.48
                    A1 (M.)..... 4.4
  P2 (Kn.)..... 0 A2 (M.)..... 0
  P3 (Kn.)..... 0
                 A3 (M.).... 0
                 a4 (M.).... 0
  P4 (Kn.)..... 0
                 A5 (M.).... 0
  P5 (Kn.)..... 0
  I (cm<sup>4</sup>.)..... 1441.441
                      Z (cm<sup>3</sup>.).... 133.5947
  Ra (Kn.)..... 5.889803 Rb (Kn.)..... 31.6302
```

TO RERUN, ENTER 1; TO RETURN TO PROG. SELECTION, ENTER 2

TO RERUN, ENTER 1; TO RETURN TO PROG. SELECTION, ENTER 2

BERNARD FINNEGAN LTD.	PAGE 1 JOB NO. RUN NO. 1
RONY MARTIN BEAM 3	AUTHOR BF DATE 23-5-91.
EN102: PLANE FRAME ANALYSIS V2.7 Units: S.I. METRIC (Steel)	(c) ENCAD SYSTEMS LTD. 198 Data File: RONY
Basic Load Case B2 : SUPER ONLY Joint Displacements	-
JOINT X LINEAR Z LINEAR Y ROTATION (mm) (mm) (rad)	
$\begin{array}{cccccccccccccccccccccccccccccccccccc$	
Basic Load Case B1 : DEAD + SUPER Member End Stresses	
Ax By yAXIS AX  MBR JOINT AXIAL BENDING +ABS.By (N/mm2) (N/mm2) (N/mm2)	Ax -ABS.By (N/mm2)
$\begin{array}{cccccccccccccccccccccccccccccccccccc$	-113.5360 -13.2416 -31.2983 -96.3491 -96.3491
5 6 .0000 .0000	
Basic Load Case B3 : SPAN ONLY Member End Stresses	عد .
Ax By YAXIS AX MBR JOINT AXIAL BENDING +ABS.By (N/mm2) (N/mm2) (N/mm2)	Ax -ABS.By (N/mm2)
$\begin{smallmatrix} 4 & 4 & .0000 & 103.0692 & 103.0692 \\ 4 & 5 & .0000 & -29.4400 & 29.4400 \end{smallmatrix}$	-103.0692 -29.4400
	·
Basic Load Case B1 : DEAD + SUPER Support Reactions	· · · · · · · · · · · · · · · · · · ·
JOINT X FORCE Z FORCE Y MOMENT (kN) (kNm)	
$ \begin{array}{cccccccccccccccccccccccccccccccccccc$	. •
Paris Tood Cogo P2 · SUPER ONLY	
Basic Load Case B2: SUPER ONLY Support Reactions JOINT X FORCE Z FORCE Y MOMENT	- 
(kN) (kNm)	
2 .0000 53.5875 .0000 5 .0000 50.9125 .0000	= -

BERNARD FINNEGAN LTD.			PAGE JOB NO.	2
RONY MARTIN BEAM 3		···	RUN NO. AUTHOR DATE	
EN102: PLANE FRAME ANALYSIS Units: S.I. METRIC (Steel)	s v2.7		(c) ENCAD SY Data	STEMS LTD. 198
Section Properties N.B. If a Shear Area value shear distortions are	field is mul	l (empty), he analysis.		_
SECTION TABLE REF./ NO. DESCRIPTION	AREA Ax (cm2)	Iy (cm4)	zMAX (mm)	Az SHEAR AREA (cm2)
2 356*171*45 UB	5.700E+01	1.210E+04	1.760E+02	2.266E+01
Member Details				
MEMBER Y AXIS SECTION MANO. FLEXURE GROUP OF TYPE NO.	ATERIAL GROUP		–	
1 1 2	1		• <del>-</del>	•

BERN	ARD FINNEGAN LTD. Consulting Engineers. 021-822336					
JOE :	Rony Martin Tallaght. DATE: 23-5-9/ PAGE: 17					
	Column Design					
	Main Column.					
	Case 1: D+S+Wind.					
	Load = 785 kn.					
5.175	$M_{xa} = 1.09 \times 8.5 \times (0.525 + 4.2 + .45)/2$					
	= 24 kn.m.					
ļ	My = 1.09 x 7.5 x 5.175/2 = 21 /m.m.					
	Case 2: D. + Wind					
Unblock	$Load = 21.4 - 0.27 \times 8.5 \times 7.5 = 4 l/n.$					
	Mac = 24 kn.m					
<u> </u>	My = 21 knm.					
	400×200×10 (Page 18)					
<u> </u>						
<u> </u>	Rear Column					
	Rear Column is a stub column, use 200x200x6.3					
	5					
	Forces on rear col.					
	Case 1: D+S + Wind // to shop (x-x)					
	$Load = 31.6 \text{ kn}.$ $Fx = 1.09 \times 3.95 = 4.3 \text{ kn}/2 = 2.15 \text{ kn}.$					
	Fy = 0 Case 2: D+ Wind // to shop					
Unblocke	•					
unblocke	$\frac{a}{Fx} = \frac{2.15}{4.5} \text{ kn},  Fy = 0$					
	Case 3: D+ Wind I to shop					
	$Load = 9.871 \times 8.5 \times 3.95 = -14 \text{ km}$					
	Fx = 0  Fy = 0.					

```
RONY MARTIN, TALLAGHT,
MAIN COL.
COLUMN DESIGN.
                                 CASE 1
                                           CASE 2
______
                                 75.00
                                            4.00 KN.
Max. Load.
                                           24.00 KN.M.
Moment x-x (a)
                                 24.00
                                            0.00 KN.M.
Moment x-x (b)
                                 0.00
                    =
                                           21.00 KN.M.
                                 21.00
Moment y-y
                    =
                    = -
                                  4.65
                                            4.65 M.
Height
Eff. Length x-x
Eff. Length y-y
                                  9.30
                                            9.30 M.
                                            9.30 M.
                                  9.30
                                  0.00
                                            0.00 M.
Canopy Width.
                    TRY 400 X 200 X 10 R.H.S.
                                          116.00 cm<sup>2</sup>
          Α
                                         1207.00 cm<sup>3</sup>
          z - x - x
                    =
                                          814.00 cm<sup>3</sup>
          z_{y-y}
                                     24140.00 cm<sup>4</sup>
          x-x
                                         8138.00 cm<sup>4</sup>
          I y-y
                                            8.39 cm.
          ry
          D/t
                                 3.41
                                            3.41 m.m.
Lateral Defl. x-x =
                                 25.83
                                           25.83 m.m.
Allow Defl. x-x =
Lateral Defl. y-y =
                                           8.86 m.m.
                                 8.86
         Defl, y-y =
                                 25.83
                                           25.83 m.m.
Allow
                                          0.00 m.m.
                                  0.00
Edge Defl.
                                 0.00
                                            0.00 m.m.
Allow. Edge Defl. =
STRENGTH DESIGN.
Compression.
                                110.85
                                          110.85
          Leff./ry =
                                 66.41
                                          66.41 N./m.m.^2
                                           0.34 N./m.m.^2
                                  6.47
          Ax.Str. =
Bending.
                                           55.42
          Leff./ry =
                                55.42
                                            0.00
                                  0.00
          D/t
                                          165.00 N./m.m.^2
                                165.00
          Pcb.
                                           19.88 N./m.m.^2
          Bend.Str.=
                                 19.88
                                  0.22
                                            0.13 < 1.0
COEFFICIENT
```

23-5-91.

BASEPLA'	TE DESIGN	RECTA	ANGULAR	COLUMN			
DIMENSIONS.			LENGTH	HTGIW	THICK		
=======================================	COLUMN :		400	200			
	BASEPL:		600		20		-
	H.D. BOLTS	:	3	2	24		
	STIFFS	:	2	150			
LOADING.		CAS	SE 1	CA	SE 2		
	·	x-x	<b>y-</b> y	x-x	у-у		
				9.0			
	MOMENT :	24.0	21.0	24.0	21.0	Kn.m	l.
RESULTANT FORCES	/ STRESSES.						
=======================================	=======================================		- ACT	UAL		ALLOW	ABLE
Depth to Neutral	Axis.(D)	173.8	_110.6	173.8	110.6		m.m.
Compressive Force							Kn.
Tensile Force				44.3			Kn.
Stress in grout			3.2		2.2		
BSPL bend. stres		46.2			91.8	206.0	•
Stiff. bending s		46.2	12.7		31.2	206.0	N./mm2 Kn.
Actual H.D.Tensi Required H.D.Ten				20.7	-	57.4	Kn.
BSPL bend. st. a				72.8			
Stiff. bending s				24.6		206.0	

RONY MARTIN, TALLAGHT, MAIN FOUND.

23-5-91.

FOUNDATION DESIGN CASE 1 CASE 2 CASE 3 ------80.00 9.00 0.00 KN. 27.36 27.36 0.00 KN.M. 23.94 23.94 0.00 KN.M. Max. Load Moment X-X Moment Y-Y = . Base Length =
Base Width =
Base Thickness = 2.00 2.00 2.00 M. 2.00 2.00 2.00 M. 0.60 0.60 0.60 M. 

 4.00
 4.00
 4.00
 M^2.

 1.33
 1.33
 1.33
 M^3.

 1.33
 1.33
 M^3.

 Base Area Base Z x-x Base Z y-y STRESSES UNDER BASE : 20.00 2.25 0.00 KN./M<sup>2</sup>.
7.20 7.20 7.20 KN./M<sup>2</sup>.
14.40 14.40 14.40 KN./M<sup>2</sup>.
20.52 20.52 0.00 KN./M<sup>2</sup>.
17.96 17.96 0.00 KN./M<sup>2</sup>. Super Load = Soil = = = Base Wind x-x Wind y-y = . MAX. STRESSES : Wind x-x 62.12 44.37 21.60 KN./M<sup>2</sup> < 100 = Wind y-y
MIN. STRESSES: 59.56 41.81 21.60 KN./M<sup>2</sup> < 100 MIN. STREET. 21.08 3.33 21.60 KN./M<sup>2</sup> > 0 23.65 5.90 21.60 KN./M<sup>2</sup> > 0 Wind y-y FACTOR OF SAFETY: 27.36 27.36 0.00 KN.M. 86.40 86.40 86.40 KN.M. 3.16 3.16 0.00  $O \cdot T \cdot M \cdot x - x =$ R.M. x-x F.O.S. x-x > 1.5 23.94 23.94 0.00 KN.M. 86.40 86.40 86.40 KN.M. O.T.M. y-y == R.M. y-y F.O.S. y-y = = 3.61 3.61 0.00 > 1.5 FOUNDATION REINFORCEMENT 63.00 kn./m^2. (nett) -----Presure under foundation 100.80 kn./m^2. (gross) 50.40 kn.m. Moment M/bd^2fcu 0.006 z = 523 m.m.
Ast = 241 m.m.^2 / m.

Minimum percentage = .13% = 715 m.m.^2 / m.

Actual...T16 @ 200 c/c = 1010 m.m.^2 / m...Provided.



DW/MR/3225

19th June 1991

710/0847 1.6.0.6 Ahdós und 11.1.

Dublin County Council, Planning Department, Block 2, Irish Life Centre, Lower Abbey Street, DUBLIN 1. Ryan O'Brien Handy Associates

6 Percy Place Dublin 4

Telephone 680 899 Facsimile 680 089

## REGISTER REFERENCE NO. 91A/0847

ALTERATIONS TO ALREADY APPROVED CANOPY AND SHOP/STORE BUILDING AT ALREADY APPROVED PETROL STATION AT TYMON/BALROTHERY DISTRIBUTOR ROAD AT TYMON NORTH, TALLAGHT FOR MR. R. MARTIN

Dear Sirs,

We refer to the above Planning Application and would like to submit the following unsolicited additional information.

### The Building

 The plan of the building was changed as our client did not feel that he required workshops and wanted to accommodate an office, fuel store and toilet for the disabled. The total floor area is not increased.

### The Canopy

- Both our client and ourselves felt that the pitched roof canopy to be very industrial in appearance and out of scale with the adjacent housing.
- The pitched roof canopy requires many more stanchions to support same and limits the forecourt.
- 4. Due to the pitched nature of the canopy the overall illumination of the forecourt would have to be increased to achieve adequate lighting.
- Our client intends to sell Jet petrol at this station. As a result of market research, Jet Oil found that the majority of people no longer liked the illuminated plastic fascias usually fixed to the canopy fascia and would prefer a light colour. The proposed colour is now a light grey to blend in with the surroundings.

2 O. JUN 91

111 Wellington Street Luton LU1 5AF

Partners
Denis Handy
DIP ARCH MRIAI MSDI
JOHN MCCarthy
DIP ARCH MRIAI MSDI
ASSOCIOTES
Denis Whelan
RIAI [TECH]
Kenneth McEwan
BSC [HONS]
Noel Doyle



- 6. The illumination of this type of canopy is dramatically reduced with only Jet and the logo internally illuminated.
- 7. There will be no illuminated sign on the canopy fascia beside the house.
- 8. The apparent height of the canopy fascia is reduced as the fascia has been designed with a bevel at the top and bottom.

We enclose 2 copies of 3 photographs to illustrate the above points.

Photograph A shows the existing finish applied to a typical filling station. Photograph B shows the proposed filling station at night. Photograph C shows the proposed finish to the canopy fascia.


Should you require any further information please contact us.

Yours faithfully,

DENIS WHELAN

Deis whele

Encls.

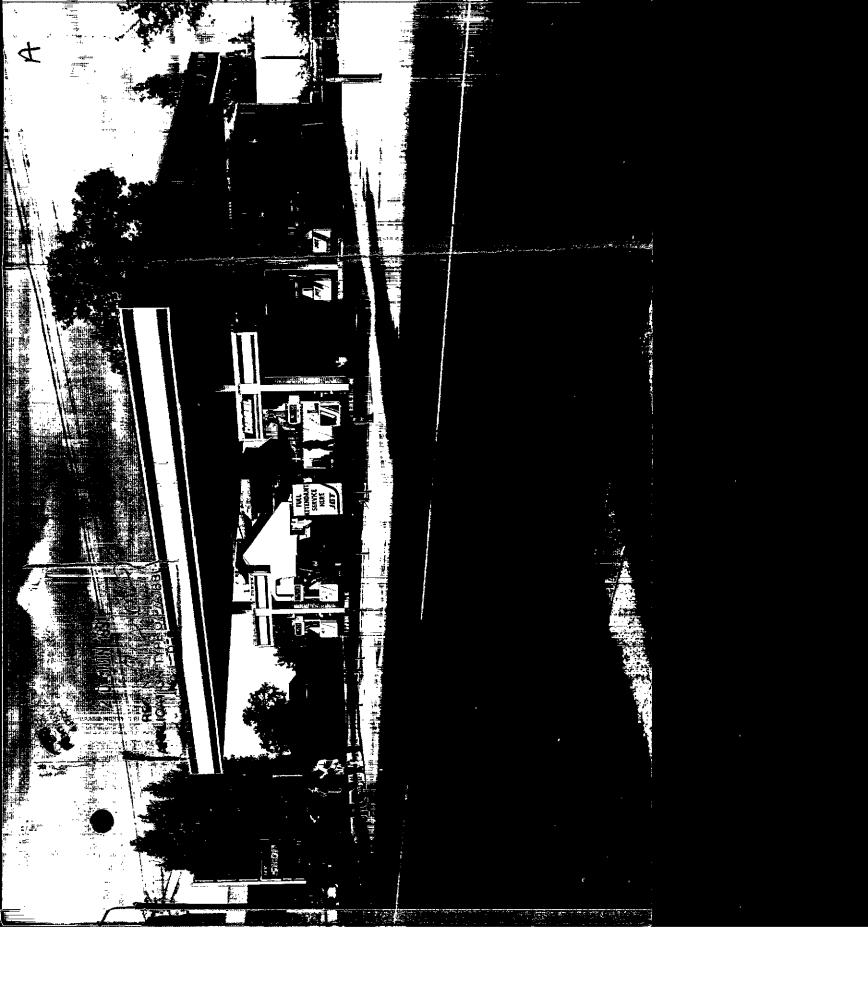







THE STATE COUNTY CO.

U

APPLICATION TYPE O/P/A/BILL

thing because of the second se

2 D JUN 1991

2 D JUN 1991

2 D JUN 1991

APPLICATION III.

No L D S

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COMHAIRI E CHONT	AF ÁTUA O	Carrier of State of the State o	RECEIP	T CODE
COMHAIRLE CHONT	AE ATHA CLI	ATH this re	caint to	
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M.O.	s fee.		41185	Parks Links
B.L.				elė.
LT.		~ Barle	rns	
	£5.25	•	**:	i d
Received this	1114	ر day of	1 46 ···	91
from Rigar Olvica		CXS		19/./.
- b Perus	Place	***************************************		
- D.U	***************************************	en en eu su Vanous purports y July De projet par j		
	*******************************	THE STATE OF THE S	च्यान्यकृतीस्थानस्थाः जीव <b>देशको</b> स्ट्रीट्	War to the state of the state o
the sum of		Committee of the Commit	CONTROL OF THE RESIDENCE AND ADDRESS OF THE PARTY OF THE	Pounds
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	and the state of t		******************	
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- Molden Doc	Cashier Cashier		ol Officer	1
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Ryan O'Brien

Handy Associates

6 Percy Place Dublin 4

Telephone 680 899 Facsimile 680 089

Your Ref: 91A/0847

DW/AMcA/3225

10th June 1991

Dublin County Council Planning Department Irish Life Centre Lower Abbey Street Dublin 1.

NEW PETROL FILLING STATION AT TYMON/BALROTHERY DISTRIBUTION ROAD, TALLAGHT, FOR R. MARTIN.

Dear Sirs

As requested in your letter of the 30th May, 1991, we enclose herewith a cheque in the amount of £5.25, being the balance of the Fee due.

Yours faithfully

DENIS WHELAN

Dow Whele

encl.

11 324 01

111 Wellington Street Luton LU1 5AF

Partners
Denis Handy
DIP ARCH MRIAI MSDI
John McCarthy
DIP ARCH MRIAI MSDI

Associates Denis Whelan RIAI (TECH) Kenneth McEwan BSC (HONS) Noel Doyle

# **Dublin County Council** Comhairle Chontae Atha Cliath

# **Planning Department**

05 JUN 1991



Bloc 2, Ionad Bheatha na hEireann, Block 2, Irish Life Centre, Sraid na Mainistreach Iacht, Lower Abbey Street, Baile Atha Cliath 1. Dublin 1. Telephone. (01)724755 Fax. (01)724896

Register Reference: 91A/0847

Date : 30th May 1991

Dear Sir/Madam,

Development : Alterations to the already approved canopy and shop/

store building at the already approved petrol filling

station

LOCATION : Site fronting south side of Tymon/Balrothery

Distributor Road and west of Scoil Iosa at Tymon

North, Tallaght

Applicant : R. Martin

App. Type : PERMISSION/BUILDING BYE-LAW APPROVAL

Date Recd : 24th May 1991

Your application in relation to the above was submitted with a fee of 280 25

On examination of the plans submitted it would appear that the appropriate amount should be 285.50 .

I should be obliged if you would submit the balance of 5.25 as soon as possible as a decision cannot be made on this application until the correct fee is received.

Yours faithfully,

PRINCIPAL OFFICER

Ryan O'Brien Handy Associates, 6 Percy Place, Dublin 4.

# Dublin County Council Comhairle Chontae Atha Cliath

# **Planning Department**

Building Control Department, Liffey House, Tara Street, Dublin 1. Telephone:773066



Bloc 2, Ionad Bheatha na hEireann, Block 2, Irish Life Centre, Sraid na Mainistreach lacht, Lower Abbey Street, Baile Atha Cliath 1. Dublin 1. Telephone. (01)724755 Fax. (01)724896

Register Reference: 91A/0847

Date : 27th May 1991

LOCAL GOVERNMENT (PLANNING AND DEVELOPMENT) ACTS, 1963 TO 1990

Dear Sir/Madam,

DEVELOPMENT: Alterations to the already approved canopy and shop/

store building at the already approved petrol filling

station

LOCATION : Site fronting south side of Tymon/Balrothery

Distributor Road and west of Scoil Iosa at Tymon

North, Tallaght

APPLICANT : R. Martin

APP. TYPE : PERMISSION/BUILDING BYE-LAW APPROVAL

With reference to above, I acknowledge receipt of your application received on 24th May 1991.

Yours faithfully,

PRINCIPAL OFFICER

Ryan O'Brien Handy Associates, 6 Percy Place, Dublin 4.

Dubilin County Council
Comhairle Chontae Atha Cliath



Planning Application Form/ Bye - Law Application Form

mhairle Chontae Atha M	CAT BACK BEFORE COMPLETING FORM. AL	L QUESTIONS MUST BE ANSWERE	D
PLEASE READ INSTRUCTION	ine Permission Approval Place in appropri	ate box. Outling permission may not be sought	for the
chould be sought only with	El B Bil Occurre hann		a.,
	in landbank Distribiliar	NOOU, NOOU.	
It none, give description	[VIIIOI NOI LII, TUTTUS	24.	
	MY R MAILLI		
Name of applicant (Principal not A	gent)	Tel. No	
		***************************************	***************************************
Ryan	O'Brien Handy ASSOCIates,	00000	) A :
annon or firm responsible 6	Percy Place, Dublin 4.	Tel, No	1.5
4 proporation of Diawille			<u> </u>
notifications should be sent	Percy Place, Dubling.	***************************************	۲۴ی
Brief description ofNev	petrol filling Station include	storage tanks and car w	ash.
Car	ins drainage 8. Source of Water S	upplyRising main	and the same
Method of drainageMa.	Insd.I.d.tuny	280.25	38
in the case of any building or bu	illdings to be retained on site, please state:-  N/A		-3a
(a) Present use of each floor or use when last used	, 	N 37	7
O Does the proposal involve demol	ition, partial demolition NO house or part thereof?		.,,,,,,,,,,,,,,,,,,,,,,,,,,,,,,,,,,,,,,
or change of use of any habitable	house or part thereoff	1,350.00	Sq. m.
(a) Area of Site	24 007 \$40m4 0 4 4 5 00 m4 0 4 0 0 0 4 4 0 m4 0 m	103.00	
(b) Floor area of proposed develo	pment ,		
(D) Libor area or broboses assert	sed to be retained within site	- David Company	Sq. m.
		Carrie Land	
2.State applicant's legal interest or	estate in site Freehold  Freehold  Laws?		
3. Are you now applying also for a	propriate box.	osa at Tymon North, Tali	
A Please state the extent to which	the Draft Building Regulations have been the		
See atta	ched notice.	of specification. loc	ation n
The of documents anchosed with	Newspaper notice, 4 no. copie	105 106 1060 107 600/6	./11B.
5.List of documents enclosed in a application.	7 Y 2 W 1 H H H H H H H H H H H H H H H H H H		911109
	/16C, /37, /89, 3200/201,/20	02,/203,/112.	**********
			Sa.
	development (See back)	O Ø. /	
16. Gross floor space of proposed	development (See back)	8 & 4 t	103
No of dwellings proposed (if a	N/A Class(es) of Developmen  Basis of Calculation Planning & BBL  Basis of Calculation Planning begiven	<u>Class 8 = £300. Class 4</u>	u £54
Fee Payable £ 840. 75. If a reduced fee is tendered de	mails of previous relevant payment should be given		**********
		• •	
Signature of Applicant (or his	Agent) Loo Date	Date .SAC	EI
Application Type	FOR OFFICE	USE ONLY	MAVIO
Application Type  Register Reference		a >4/1/24	riel l'
Register Hererence	22-5: 1, 6	8.4 27/13 m	eg. Sec
Amount Received £		Soft-annual Company	
Receipt No	***************************************		

### LOCAL GOVERNMENT (PLANNING & DEVELOPMENT) REGULATIONS 1977 to 1984.

Outline of requirements for applications for permission or Approval under the Local Government (Planning & Development) Acts 1963 to 1983. The Planning Acts and Regulations made thereunder may be purchased from the Government Publications Sales Office, Sun Alliance House, Molesworth Street, Dublin 2.

- Name and Address of applicant.
- Particulars of the interest held in the land or structure, i.e. whether freehold, leasehold, etc.
- The page of a newspaper, circulating in the area in which the land or structure is situate, containing the required statutory notice. 3. The newspaper advertisement should state after the heading Co. Dublin.
  - (a) The address of the structure or the location of the land.
  - The nature and extent of the development proposed. If retention of development is involved, the notice should be worded accordingly. Any demolition of habitable accommodation should be indicated.
  - (c) The name of the applicant.
  - NB, Applications must be received within 2 weeks from date of publication of the notice.
- Four (4) sets of drawings to a stated scale must be submitted. Each set to include a layout or block plan, proposed and existing services to be shown on this drawing, location map, and drawings of relevant floor plans, elevations, sections, details of type and location of septic tank (if applicable) and such other particulars as are necessary to identify the land and to describe the works or structure to which the application relates (new work to be coloured or otherwise distinguished from any retained structures). Buildings, roads, boundaries and other features bounding the structure or other land to which the application relates shall be shown on site plans or layout plans. The location map should be of scale not less than 1: 2500 and should indicate the north point. The site of the proposed development must be outlined in red. Plans and drawings should indicate the name and eddress of the person by whom they were prepared. Any adjoining lands in which the applicant has an interest must be outlined in blue.
- In the case of a proposed change of use of any structure or land, requirements in addition to 1, 2, & 3 are:
  - (a) a statement of the existing use and the proposed use, or, where appropriate, the former use and the use proposed.
  - (b) (i) Four (4) sets of the drawings to a stated scale must be submitted. Each set to consist of a plan or location map (marked or coloured in red so as to identify the structure or land to which the application relates) to a scale of not less than 1:2500 and to indicate the North point. Any adjoining lands in which the application has an interest must be outlined in blue.
    - (ii) A layout and a survey plan of each floor of any structure to which the application relates.
  - (c) Plans and drawings should indicate the name and address of the person by whom they were prepared.
- Applications should be addressed to: Dublin County Council, Planning Department, Irish Life Centre, Lr. Abbey Street, Dublin 1, Tel. 724755.

SEPTIC TANK DRAINAGE: Where drainage by means of a septic tank is proposed, before a planning application is considered, the applicant may be required to arrange for a trial hole to be inspected and declared suitable for the satisfactory percolation of septic tank effluent. The trial hole to be dug seven feet deep at or about the site of the septic tank. Septic tanks are to be in accordence with I.I.R.S. S.R. 6:75.

### INDUSTRIAL DEVELOPMENT:

The proposed use of an industrial premises should, where possible, be stated together with the estimated number of employees, (male and female). Details of trade effluents, if any, should be submitted.

Applicants to comply in full with the requirements of the Local Government (Water Pollution) Act, 1977 in particular the licencing provisions of Sections 4 and 16.

	PLANNING APPLICATIONS			BUILDING BYE-LAW APPL	<u>ICATIONS</u>
CLASS			CLAS	=	
NO.	DESCRIPTION	FEE	NO.	DESCRIPTION	FEE
1.	Provision of dwelling — House/Flat.	£32.00 each	Α	Dwelling (House/Flat)	£55.00 each
2.	Domestic extensions/other improvements.	£16.00	В	Domestic Extension	
3.	Provision of agricultural buildings (See Regs.)	£40,00 minimum	İ	(improvement/alteration)	£30,00 each
4.	Other buildings (i.e. offices, commercial, etc.)	£1.75 per sq. metre	С	Building — Office/	£3.50 per m²
		(Min. £40,00)		Commercial Purposes	(min. £70.00)
5.	Use of land (Mining, deposit or waste)	£25.00 per 0.1 ha	D	Agricultural	£1.00 per m2
		(Min £250.00)		Buildings/Structures	in excess of
6.	Use of land (Camping, parking, storage)	£25,00 per 0.1 ha		~	300 sq. metres
		(Min. £40.00)			(min £70.00)
7.	Provision of plant/machinery/tank or	£25.00 per 0.1 ha			(Max £300.00)
	other structure for storage purposes.	(Min. £100.00)	E	Petrol Filling Station	£200.00
8.	Petrol Filling Station.	£100.00	F	Development or	£9.00 per 0.1 ha
9.	Advertising Structures.	£10.00 per m²		Proposals not coming	(£70.00 min.)
		(min £40.00)		within any of the	•
10.	Electricity transmission lines,	£25.00 per 1,000m		foregoing classes.	
		(Min. £40.00)		•	Min. Fee £30.00
11.	Any other development.	£5.00 per 0.1 ha			Max. Fee £20,000
	·	(Min. £40.00)			


Cheques etc. should be made payable to: Dublin County Council.

DI ANNINO ADDITOATIONO

Gross Floor space is to be taken as the total floor space on each floor measured from the inside of the external walls. For full details of Fees and Exemptions see Local Government (Planning and Development) (Fees) Regulations 1984.


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map not available. 1.200 Scale o.S. map ref. :- Dublin 57/22 Tymon / Balrothery Rd., Tymon Nth., Dublin 24 Site location map of petrol filling station 1348 0404 TABILIDA IND NOW I 198-7 199 01 ያ ፡ ይ ፋን m82 5

# ELEVATION

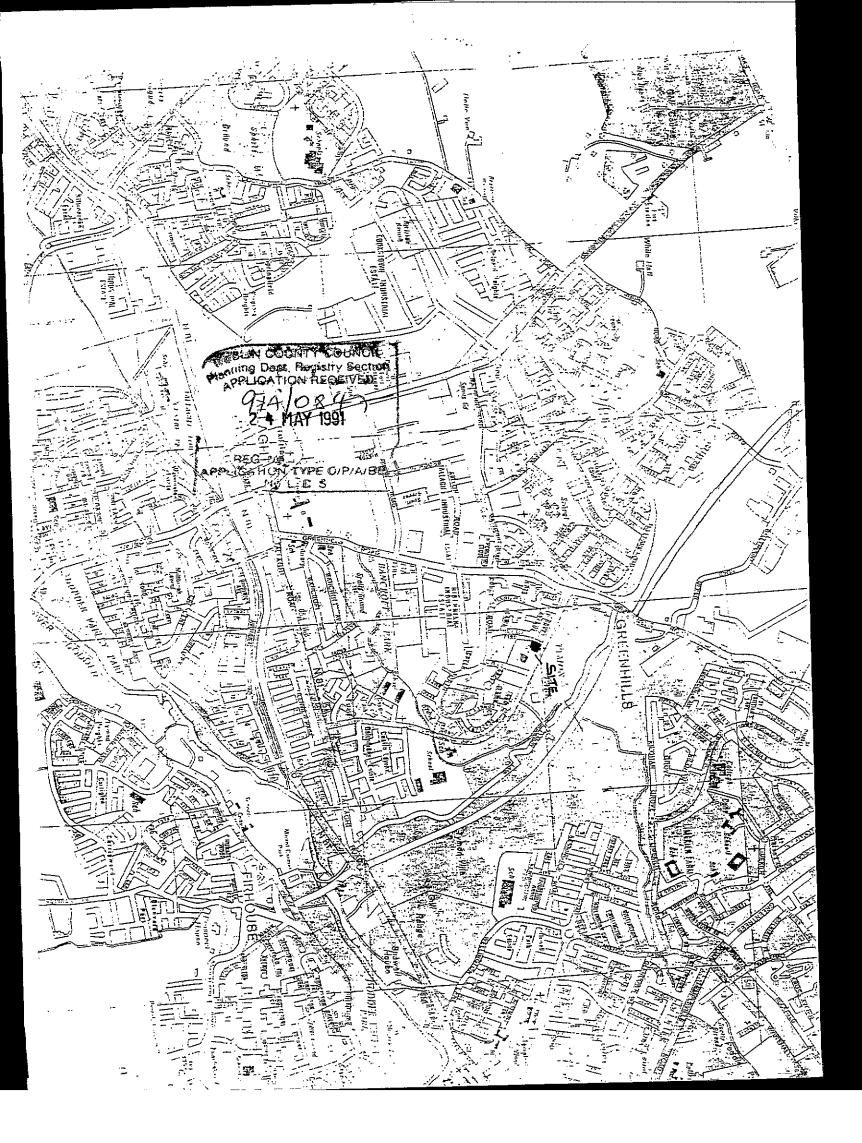

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ELEVATION: D. POLE SIAN.

Ryan O'Brien

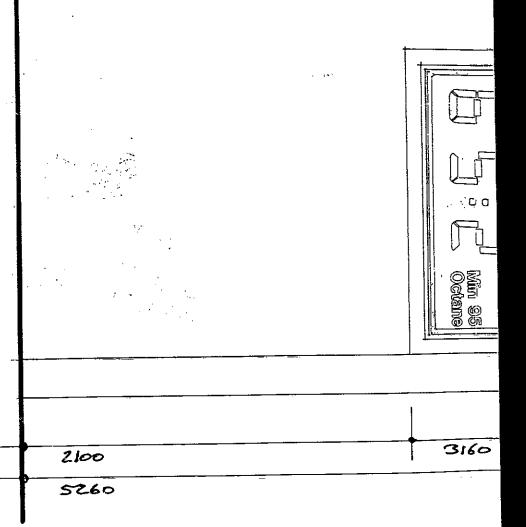Handy Associates

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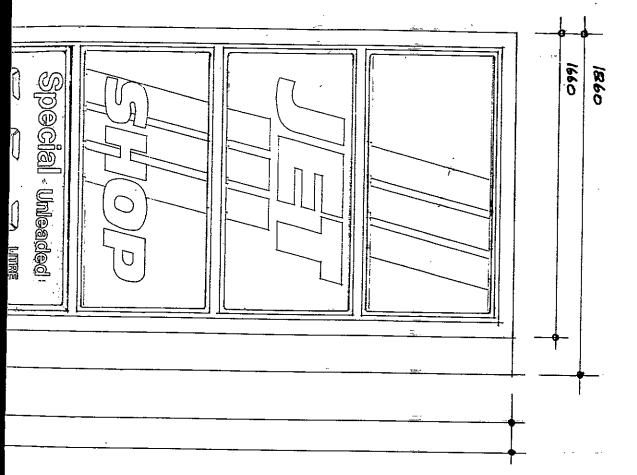
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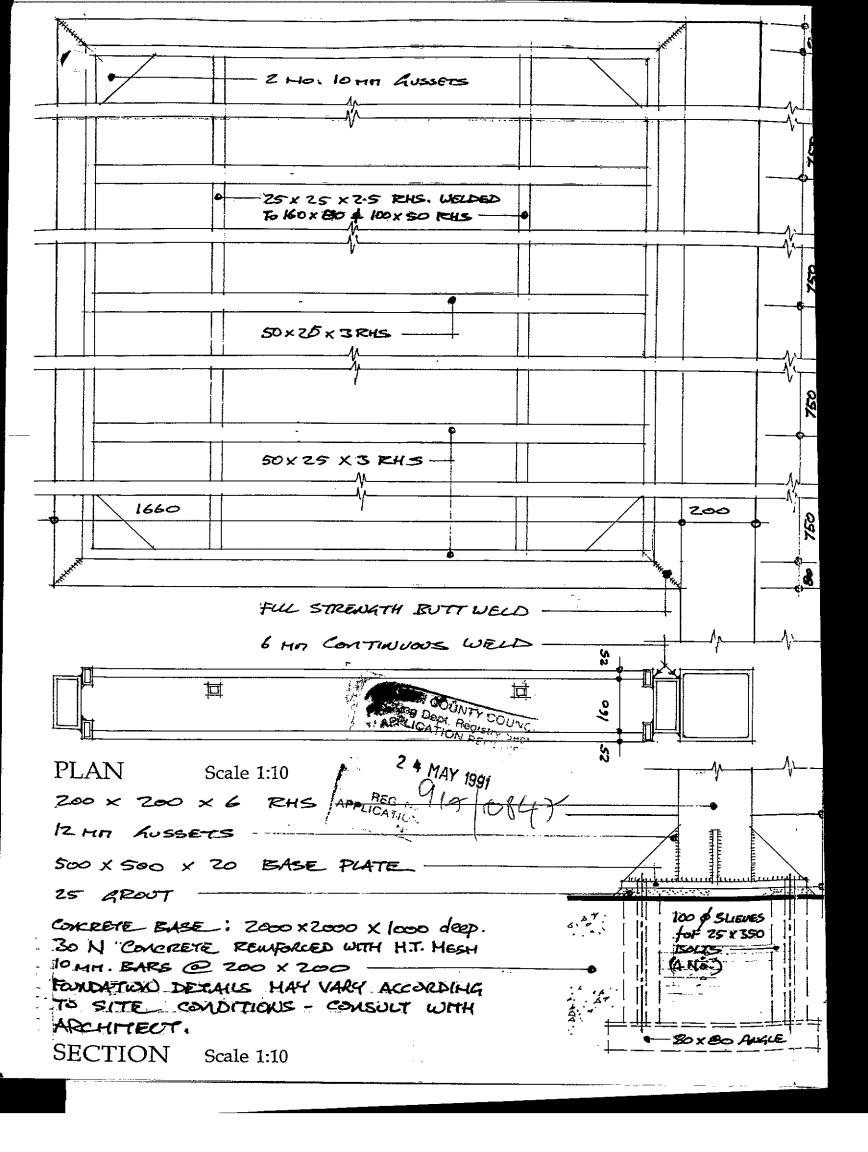
6 Percy Place Dublin 4


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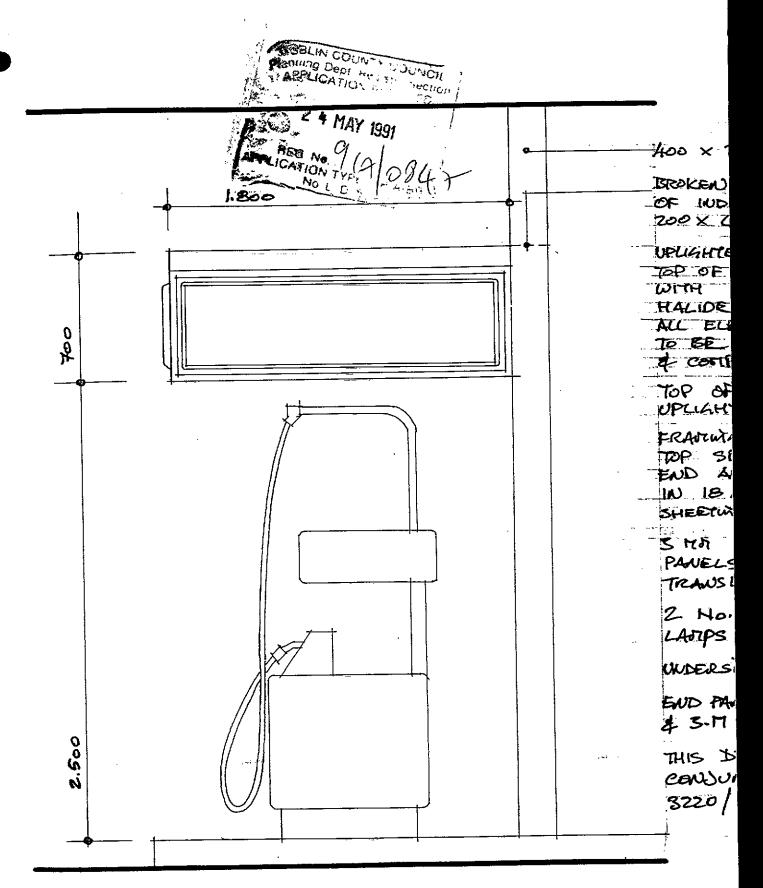
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**ELEVATION** 

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FROM SATTE MANUFACTURER

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24. To BE READ IN ICTION WITH DEG.NOS. 204, 205 & 206 **END ELEVATION** 

tions for independent topped stanching to onfirmed with Alchitect.



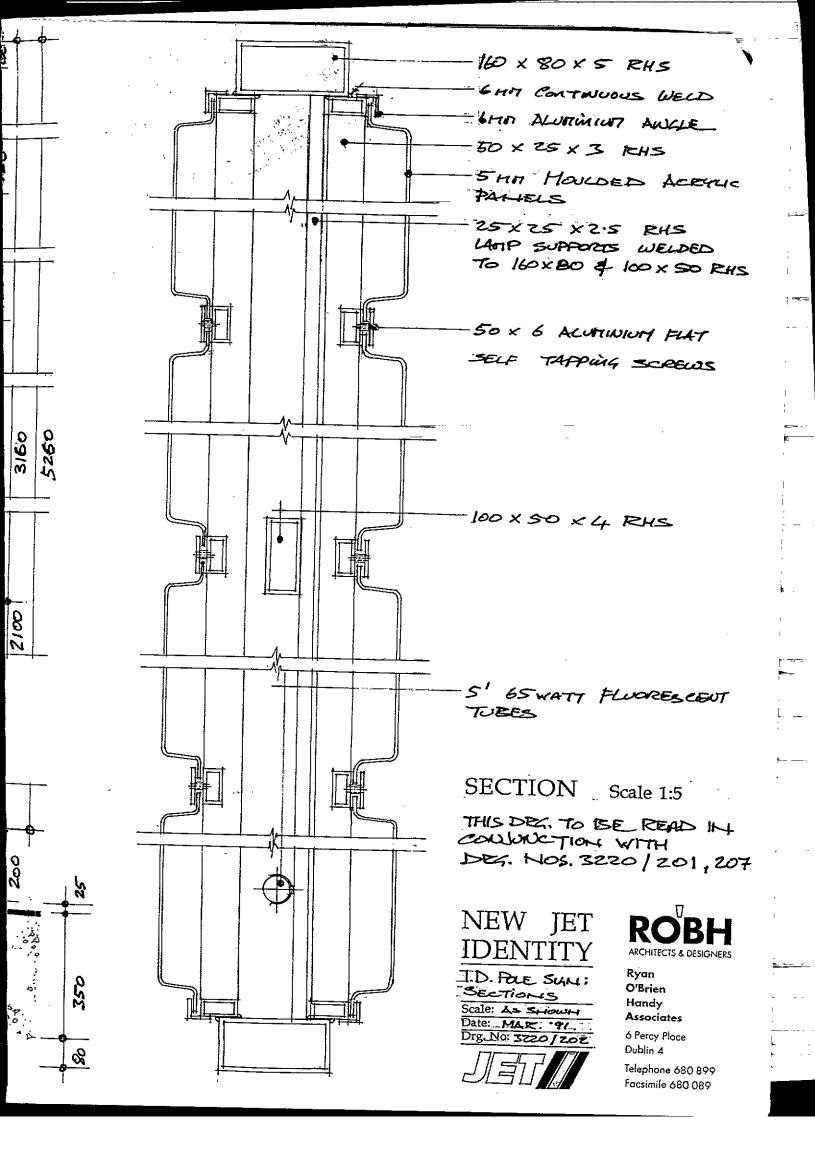



ARCHITECTS & DESIGNERS


Ryan O'Brien Handy Associates

6 Percy Place Dublin 4


Telephone 680 899 Facsimile 680 089

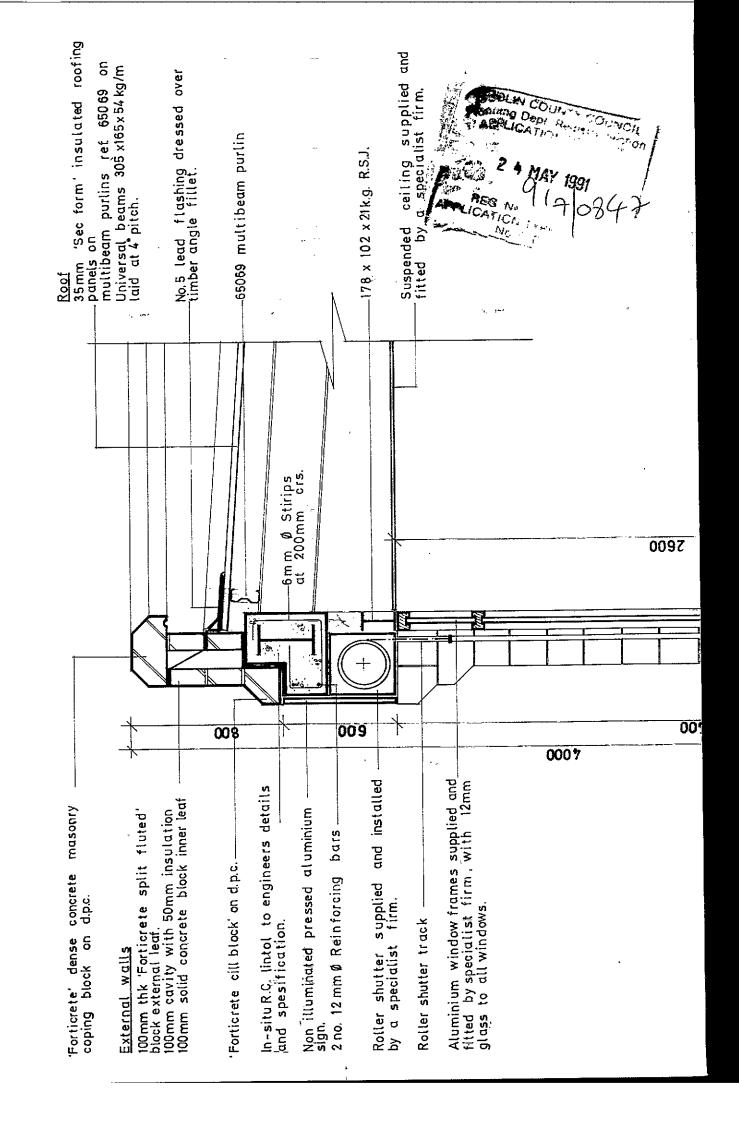

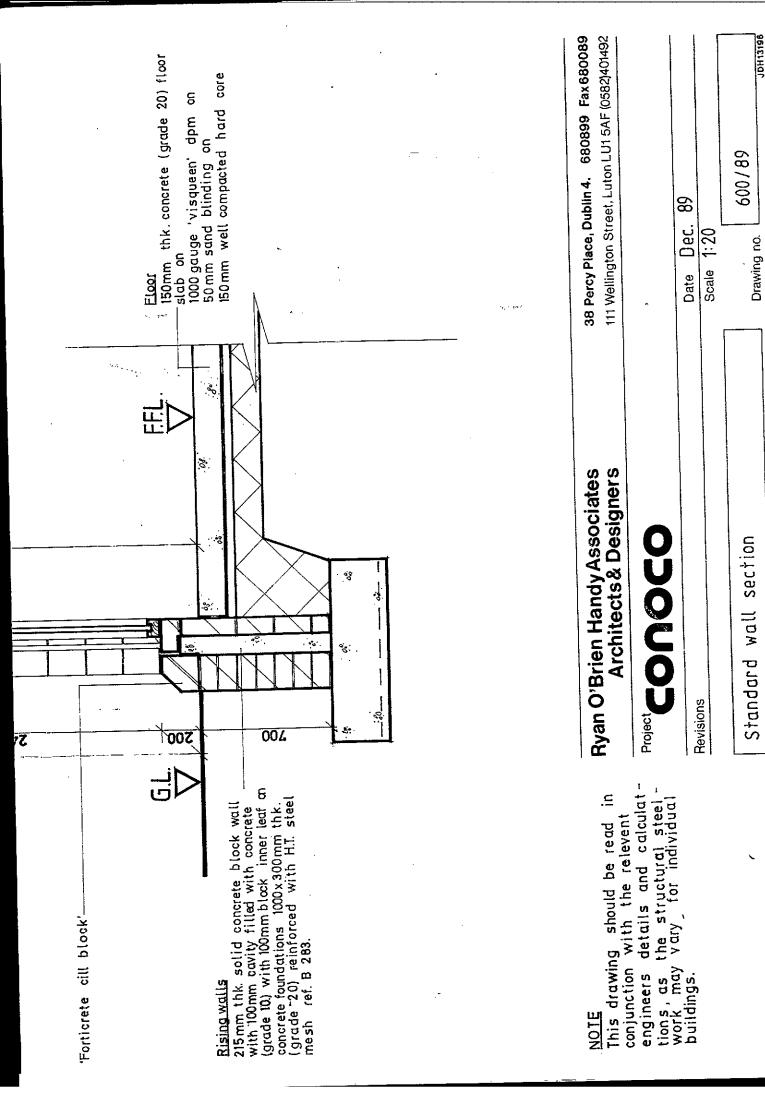


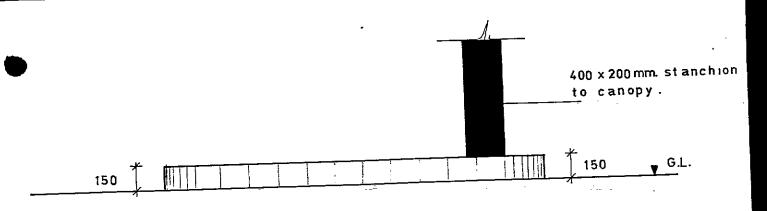


ELEVATION (scale 1:20)

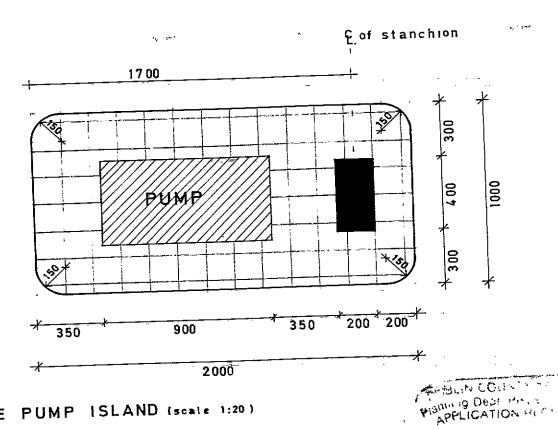



SINGLE PUMP ISLAND (scale 1:20)

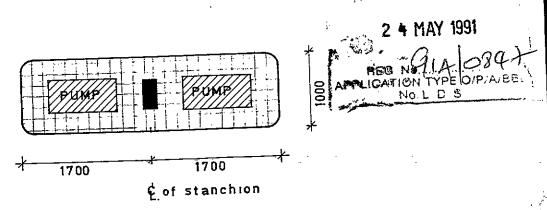


DOUBLE PUMP ISLAND (scale 1:50)

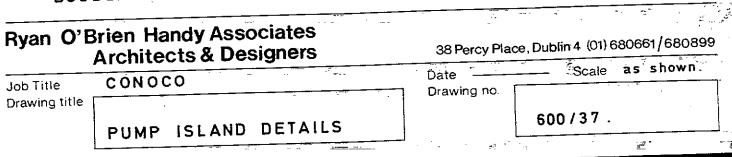

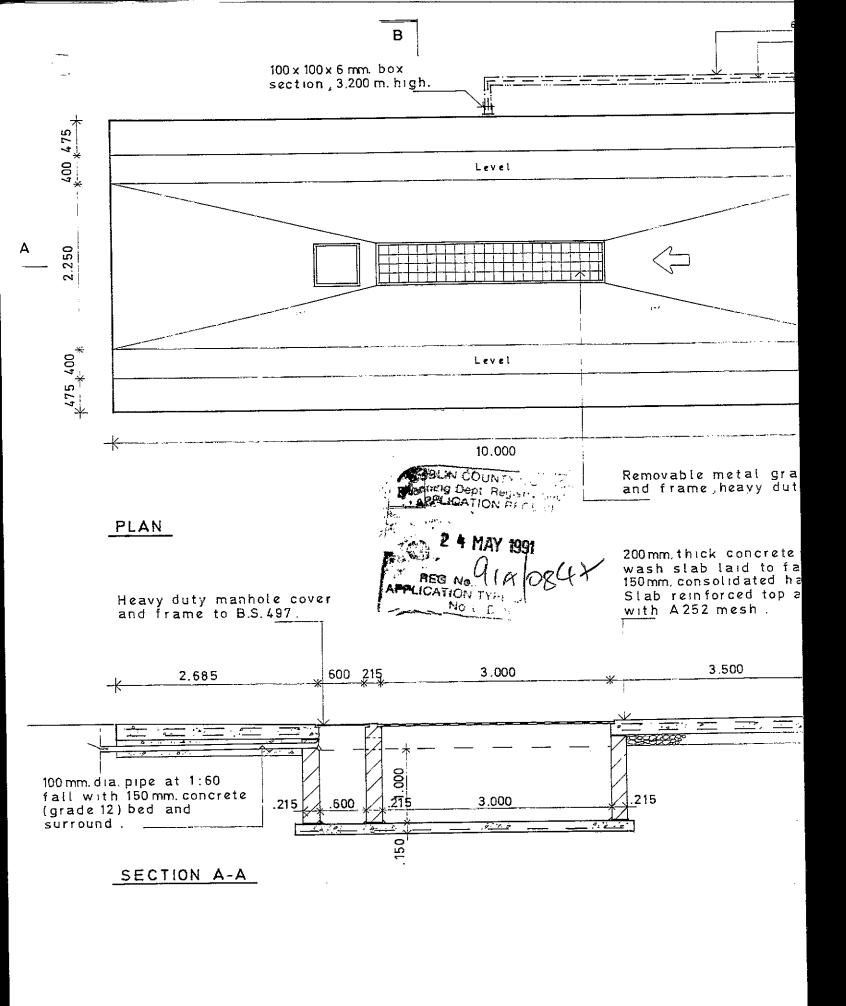

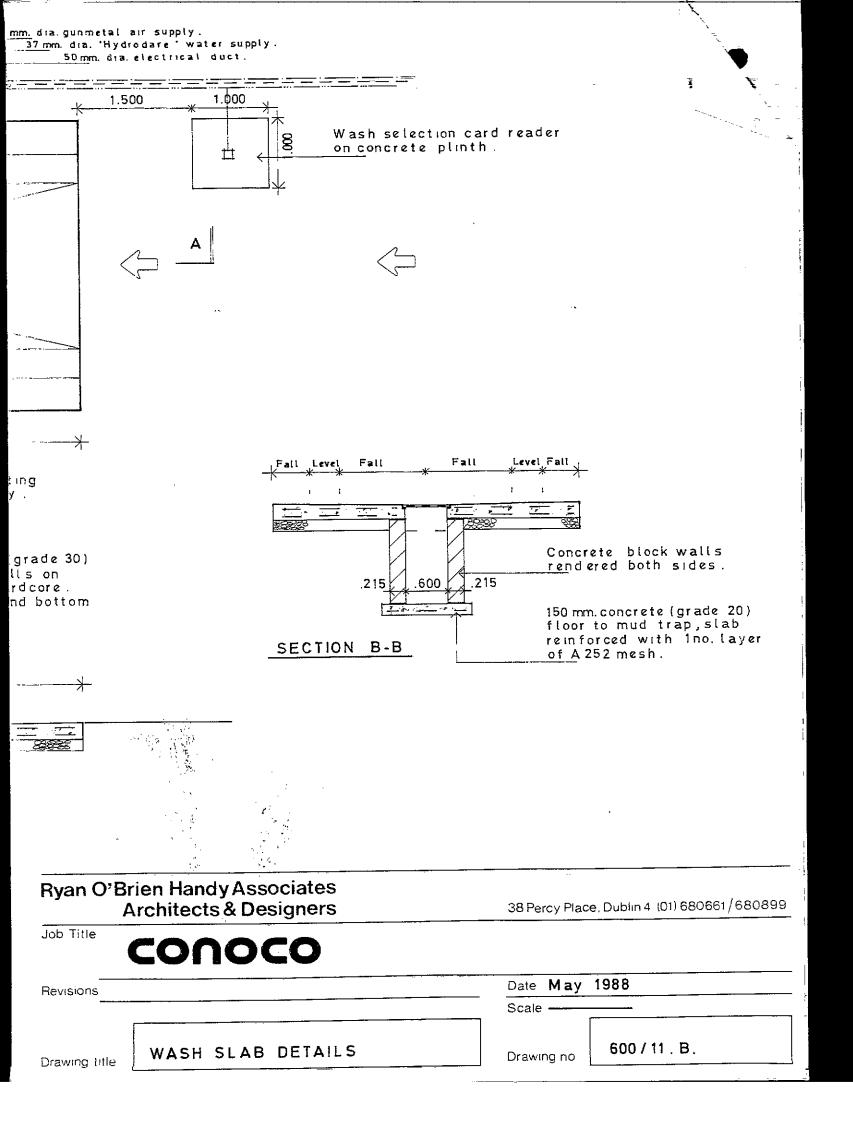

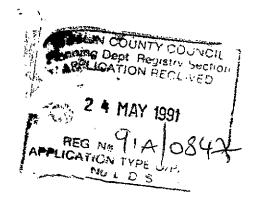

#### DRAFT BUILDING REGULATIONS

It is the practise of this office to take account of the Draft Building Regulations as issued by the Minister for the Environment in the design of buildings but this is not to be interpreted as a guarantee that the provision of the Draft Building Regulations have been implemented in full or in any particular respect in this proposal.

RYAN O'BRIEN HANDY ASSOCIATES, Architects & Designers, 38 Percy Place, Dublin 4.



**OUTLINE SPECIFICATION** 

for

24 MAY 1991

APPLICATION PER Section

2 MAY 1991

APPLICATION TYPE DIPLATE:

Ryan O'Brien Handy Associates

6 Percy Place Dublin 4

Telephone 680 899 Facsimile 680 089

THE DEVELOPMENT

o f

A NEW PETROL FILLING STATION

аt

TYMON/BALROTHERY DISTRIBUTOR ROAD, TYMON NORTH, TALLAGHT, DUBLIN 24.

for

MR. R. MARTIN

حار شجع

under the supervision of

RYAN O'BRIEN HANDY ASSOCIATES

May 1991

111 Wellington Street Luton LU1 5AF

, and . .

Partners
Denis Handy
DP ARCH MRIAI MSDI
John McCarthy
DP ARCH MRIAI MSDI
ASSociates
Denis Whelan
RIAI [TECH]
Kenneth McEwon
BSC [HONS]
Noel Doyle

- All work is to be carried out strictly in accordance with the Requirements and Regulations of the Local Authority, Building Bye-Laws, Draft Building Regulations and Fire Officer.
- 2 All material to be used to be of Irish manufacture and to I.S.S. where applicable and to be the best of their respective kind.
- All Local Authority charges, i.e. water supply connections, drainage connections, E.S.B. and Bord Telecom Charges Will be paid by the Client or be refunded by the Client to the Contractor should the Contractor pay same so as to avoid unnecessary delays.
- It will be the responsibility of the Contractor to inform the Building Control Department with due notice when the foundation trenches, drains, etc., are ready for inspection.
- The Contractor is to include for making good all surfaces where disturbed to match existing finishes after the completion of all works.
- The Contractor is to include for removing all rubbish from the site and to leave the site in a neat and clean condition after the completion of all works.
- As petrol and diesel oil will be stored and dispensed on this site, safety is paramount. It is the responsibility of the Contractor to take all precautions necessary while carrying out the works. No welding, cutting of mesh, etc., is to be carried out in the vicinity of the underground tanks or petrol pumps. Contractor to consult with Architects and pipework specialists regarding the positions of pipework, electrical ducts, etc., before any excavation work is carried out. Before any work commences, Contractor to agree the safety standards necessary with the Architects and Client.
- 8 Contractor is to include for building all manhole chambers with 225mm solid concrete blocks (approx. size 900 x 750 x 950 mm deep). The walls and floors of these chambers to be rendered with 3 no. coats sand and cement. The rendering is to be finished neatly around all pipework and tank manlid.
- The E.S.B. supply to the site is to be brought to the new building in an underground duct where a fuseboard, meteres, isolation switches, etc. will be installed in the store. All wiring on the site to the pumps, canopy, sign, lights, etc. are to be laid in 100mm diameter 'Wavin' ducts, 300mm minimum below ground level with adequate inspection chambers and drawpits. All electrical work is to be carried out strictly in accordance with the most recent E.S.B. Regulations and Requirements.
- 10 Contractor to include for taking 3 no. connections (25mm hydrodare) from main supply 1 no. to the new services island, 1 no. to the car wash position and 1 no. to the new building as indicated on the drawings. Include for 25mm full way stop valves on all connections. Pipes to be 450mm minimum below ground level.
- 11 Contractor is to include for installing 1 no. concrete (Grade 30) car wash slab laid to falls on 150mm consolidated hardcore in accordance with detail drawing no: 600/11B in the positions shown on drawing no: 3225/02 & 04.
- The Specialist Firms will erect the car wash machinery and connect the water supplies, electrical wiring and air lines.
- 13 Contractor to include for new planting areas around the new services island and boundary walls as indicated on drawing no. 3225/02.
- 14 Contractor to include for cleaning out and rotavating all planting areas and for the supply and installation of 150mm additional top soil to all areas. All areas to be rolled and seeded with top quality grass seed.
- The new surface water drains on the site are to be installed in accordance with the layout drawing. Drains generally to be PVC ('Wavin' or similar) to sizes indicated and to be laid in trenches in straight lines to the required depth and falls. All joints are to be made in strict accordance with the manufacturer's instructions. All drains are to be laid on a minimum 150mm concrete (Grade 12) bed and encased in 150mm concrete (Grade 12). The trenches are to be back-filled in layers, the material being carefully rammed to consolidate it, care being taken not to damage the pipes and joints. All drains to be water tested for leaks in accordance with CP301.

- Manhole chambers on the surface water drains to be constructed with 225mm solid concrete blocks rendered with 3 no. coats sand and cement waterproof rendering internally; half round channels formed with easy bends with sand and cement benching to sides. Provide and fit step irons in chambers if necessary. Provide and fit heavy duty cast iron covers and frames bedded in grease.
- All A.J.'s to be PVC (Wavin or similar). Provide 250 x 250mm PVC square rising pieces up to ground level, and finish at top with 275 x 275mm galvanised cast iron covers and frames set in cement mortar and sealed in grease. All A.J.'s to be set on bed of concrete 150mm thick (concrete grade 12).
- 18 Contractor to supply and install PVC gulley traps where shown on drawings.
- The Contractor is to supply and install two prefabricated Conder petrol interceptor traps in accordance with the Manufacturer's instructions, as per detail drawing no. 600/6, on the foul water drain where indicated on the drawings and at the car wash outfall. The contractor is to supply and install 3 no. 100mm diam. p.v.c. vent pipes to the chambers of the interceptor which are to be joined together underground and 1 no. 100mm diam. PVC pipe to be brought underground to an agreed position on site, up to ground level. A Specialist Firm will supply and fit the upright section above ground. The Contractor is to supply and fit 3 no. <a href="heavy...duty">heavy...duty</a> manhole covers and frames over the 3 no. interceptor chambers.
- The Contractor is to provide and install new 'ACO' drainage channels type C 250 and new 'ACO' silt gulleys where indicated on the drawings.
- New foul drains indicated are to be installed strictly in accordance with the drawings and as described previously for Surface Water Drains in Clause No.
- Manhole chambers on foul drain to be constructed with 225mm solid concrete blocks rendered inside and outside with 3 no. coats sand and cement waterproof rendering, half round channels formed with easy bends with sand cement benching at 1:12 to sides. Provide and fit step irons to chambers as necessary and provide and fit heavy duty cast iron covers and frames, sealed in grease.
- 23 All A.J.'s to be installed as previously described in Clause No. . 17
- 24 Provide and fit PVC gulley traps where shown.
- Contractor to include for building a new (last) manhole chamber on the foul drain where indicated on the drawing. Manhole chamber to be constructed as previously specified. Include for dispersion interceptor trap and fresh air inlet on this manhole chamber.
- 26 Contractor to include for 150mm minimum of well consolidated hardcore under all new ground surfaces.
- The forecourt area under the canopy is to be surfaced with concrete paving setts laid in strict accordance with the manufacturer's instructions and specification.
- The remainder of the forecourt, as indicated, shall be tarmacadam (as specified on drawing no. 3225/02) or 250mm deep reinforced concrete (grade 20) laid to falls as detailed on drawing no. 3225/04.
- A new canopy is to be erected on site in position indicated on drawing. The canopy, with illuminated fascias on three sides, is to be fabricated, supplied and erected by a specialist firm. The canopy shall be consturcted with R.H.S., steel stanchions, steel intermediate members with aluminium top sheeting, soffite sheeting and steel fascias.
- 5 no. new underground storage tanks (5.33 x 2.74m x 4 no. and 6.30 x 2.00m x 1 no.) are to be installed strictly in accordance with detailed drawing no. 600/16C. The tops of these tanks will be approx. 1m. below finished ground level but the Contractor should check with the Specialist Firm who will be fitting out these tanks as to the exact depth required for the tanks in relation to the proposed new ground level.
- When the chambers for the petrol storage tanks are excavated and the bottom concrete slabs are cast (<u>sulphate resisting concrete grade 20</u> Contractor to ensure that these slabs are level), the Contractor is to inform the local Fire Officer so that he can inspect the pits before the tanks are installed. Generally two days clear notice is required but a week's approx. notice is advised so as to avoid any unnecessary delays.

When the Contractor has installed the tanks in the chambers, ensuring that they are perfectly level, he is to arrange to have the tanks filled with water before the tanks are encased in sulphate resisting concrete (Grade 20) so that water hydraulic pressure tests can be carried out on the tanks by a Specialist Firm in compliance with the Dangerous Substances Act. The Contractor is to give due notice to the Architect as to when the tanks are to be ready for the tests so the tests can be arranged with the least disruption to the progress of the works. Generally the Fire Officer will witness these tests and he must be given two days clear notice. The tanks are to be encased in concrete while the water is in the tanks. The Contractor is to include for emptying the water out of these tanks where advised to do so by the Specialist Firm who will be fitting out these tanks.

- 33 The Contractor is to include for all necessary shuttering and form-work so that these tanks can be encased in concrete as per detailed drawing.
- A Specialist Firm will fit out the new tanks, lay all the associated pipework to the pumps, including vent lines and off-set fill lines, etc.
- The Contractor is to include for 6 no. manhole chambers over the tanks (approx. size 750mm x 900mm x 900mm deep). The exact size of the manhole chambers and the position of same to be decided on site. The heavy-duty cast iron frames and covers for the manholes over the new tanks will be supplied but the Contractor is to include for fitting same.
- All manhole chambers are to be built after all the pipework has been completed. The chambers are to have 225mm concrete block walls, rendered internally and externally with 3 no. coats sand and cement rendered neatly around the pipework. The floors of these chambers (which are below the tank lids) shall be finished with concrete Grade 12 and sloped to drainage outlets.
- Before the pipework can be covered up, all pipe lines will be tested by the Specialist Firm who will inform the Fire Officer so that the tests can be witnessed. The pipelines are to be encased in 150mm washed sand all round.
- The new shop/store building is to be built strictly in accordance with detail drawings nos. 3225/06 & 07, and Structural Engineer's drawings.
- Foundations to be constructed as per details on drawing no. 3225/07, concrete grade 20. Footings to be reinforced top and bottom with A252 mesh.
- New external walls to be 400mm cavity wall with 100mm split fluted WHITE Forticrete Masonry blocks (400 range) outer leaf as per detail drawing, with matching WHITE Forticrete cill block details at plinth, around and over projecting window head band as shown with matching WHITE Forticrete parapet copings; 100mm cavity with 50mm rigid insulation board fixed against inner leaf with 100mm solid concrete block inner leaf to suit Forticrete modular dimensions (400 range). Carry round the split fluted face around all window and door opes (to face of frames). Cavity wall ties to be used at no less than 4 no. per sq.m. with ties at openings, ensuring that all mortar droppings are cleaned off the ties and out of the cavity.
- 41 All internal walls to be 225mm or 100mm solid concrete block as indicated.
- 42 All walls to be plastered internally with 12mm hardwall plaster and skim.
- New roof to be constructed suing one layer of solar reflecting stone chippings on 'Derbigum SP' roofing membrane on a base layer of 25mm thick 'Korktherm' thermal insulation on approved vapour barrier on 12mm of roofing grade chipboard on 175 x 38mm timber joists at 350mm centres on 254 x 146 x 43kb. universal beam.
- 44 All flashings generally to be No. 5 lead flashing.
- Floors to consist of a levelling screed on 150mm thick concrete (grade 20) floor slab on 1000 gauge 'Visqueen' DPM on 50mm sand blinding on 150mm wall consolidated hardcore.
- 46 Floor in Fuel Store to have a screed finish.
- 47 Include for 1000 gauge visqueen DPC's where shown on drawings.


- Lintols generally to be prestressed concrete units, used strictly in accordance with manufacturer's instructions or as per details shown on the drawings.
- Concrete beams at the front and sides of the building to be cast insitu (grade 30) as per detail on drawing no. 3225/06 and 600/89 and in accordance with engineers details and specification.
- Front and side faces of building to consist of aluminium framed shopfronts as shown. Entire shop fronts, including main door to be aluminium coated with white PVC or white syntha pulvin finish. Framing to be 'shopfront type' box section or similar. Glass in windows AND door to be 12.5mm laminated plate glass.
- External doors and frames to Store and External Toilet to be steel Martin Roberts Guardian Standard doorsets. Hinges to be standard recessed BH1 100mm x 75mm x 26mm template drilled butt hinges 3 hinges per door. Doors to Store to have a PH73 panic bolt set and door to toilet to have a MKC 241 upright mortice cylinder sash lock.
- Door and frame from shop to lobby to be standard 1 hour fire check door.
- All other internal doors and frames to be standard flush plywood finished doors.
- Doors to Fuel store to be steel Martin Roberts Guardian Standard Doorsets as previously specified overall size 2000 x 2100 approx. exact type to be decided on site.
- Include for providing and fitting 100 x 200mm selected wall tiles to a height of 1.65m around all walls in kitchen, toilets and ventilated lobby. Wall tiles to be carried down to floor level.
- Provide and fit 100 x 23mm skirtingboards around all walls in building except areas which have wall tiles, where the wall tiles are to be carried down to the floor.
- 57 Provide and fit 225 x 225mm air vents where shown.
- The Nominated Electrician will supply and fit 1 no. mechanical air extract fan in the kitchen
- Contractor to include for a suspended ceiling -'Armstrong Microlook Image 600 x 600 x 17mm white tiles' in the shop area and 'Armstrong Minuboard 600 x 600 x 17mm white tiles' in ALL other areas. Suspended ceilings to be supplied and installed by a specialist firm.
- Provide and fix PVC soil and vent pipe where shown.
- Rainwater gutters to be an approved 125mm aluminium gutter. R.W.P.'s to be 100mm diameter PVC.
- The Contractor is to locate the existing water supply in the footpath. Include for bringing a 25mm hydrodare connection into the building to a water storage tank which is to be located in Store.
- Provide and fit an 80 gallon fibreglass storage tank (with overflow pipe) on iron angle bearers in Store exact location to be decided on site. Include for insulating tank and encasing tank with removable timber sheeting. Include for ball cock mechanism and overflow pipe.
- 64 Contractor to include for the supply and fitting of 2 no. Vitreous china low level w.c. suites with overflow pipes and 2 no. 300 x 500mm (approx.) Vitreous china wash hand basins each including 2 no. taps in the toilets
- 65 Include for the supply and installation of 1 no. standard stainless steel sink and base unit with presses under.
- 66 Include for taking 1 no. 12mm spur for drinking water off rising main to the sink unit in the kitchen.
- 67 Include for the following fullway stop valves 25mm on service entry to the building; 12mm on spur to sink unit, the 2 no. w.c.'s, the 2 no. cold water taps on w.h.b.'s
- Include for bringing 12mm supply pipes from the water storage tank to each of the w.c.'s, the cold water taps on the w.h.b.'s and 3 no. electric undersink water heaters. The nominated Electrician will supply and fit undersink water heaters. As some undersink water heaters require connections from the rising main rather

than the tank, Contractor should check with the Electrician before installing the pipework. Provide and fit 12mm pipes from undersink water heaters to hot taps at both w.h.b.'s and sink unit.

- Dry powder fire extinguishers and 'No smoking tum off engine' signs are to be provided on the forecourt as required by the Dangerous Substances Act and the Fire Officer's requirements. The positions in which the petrol tanker will stand while filling the underground storage tanks must also be marked on the concrete apron.
- Existing boundary wall to be cleaned down and rendered with three coats of sand/cement plaster, finished smooth and painted with approved masonry paint.
- New boundary walls to be built using hollow concrete blocks to heights specified on drawing no. 3225/02. Walls to have concrete (g rade 20) reinforced strip foundations with piers at 4.00m. centres and vertical expansion joints at 6.00m. centres. All blockwork to comply with I.S. 20. Walls to be capped with precast concrete copings on polythene damp proof course. Walls to be rendered with three coats of sand/cement plaster, finished smooth and painted with approved masonry paint.
- 72 All surfaces are to be made good after the completion of all works and all rubbish is to be carted away and the site left in a neat and clean condition.

RYAN O'BRIEN HANDY ASSOCIATES


May 1991

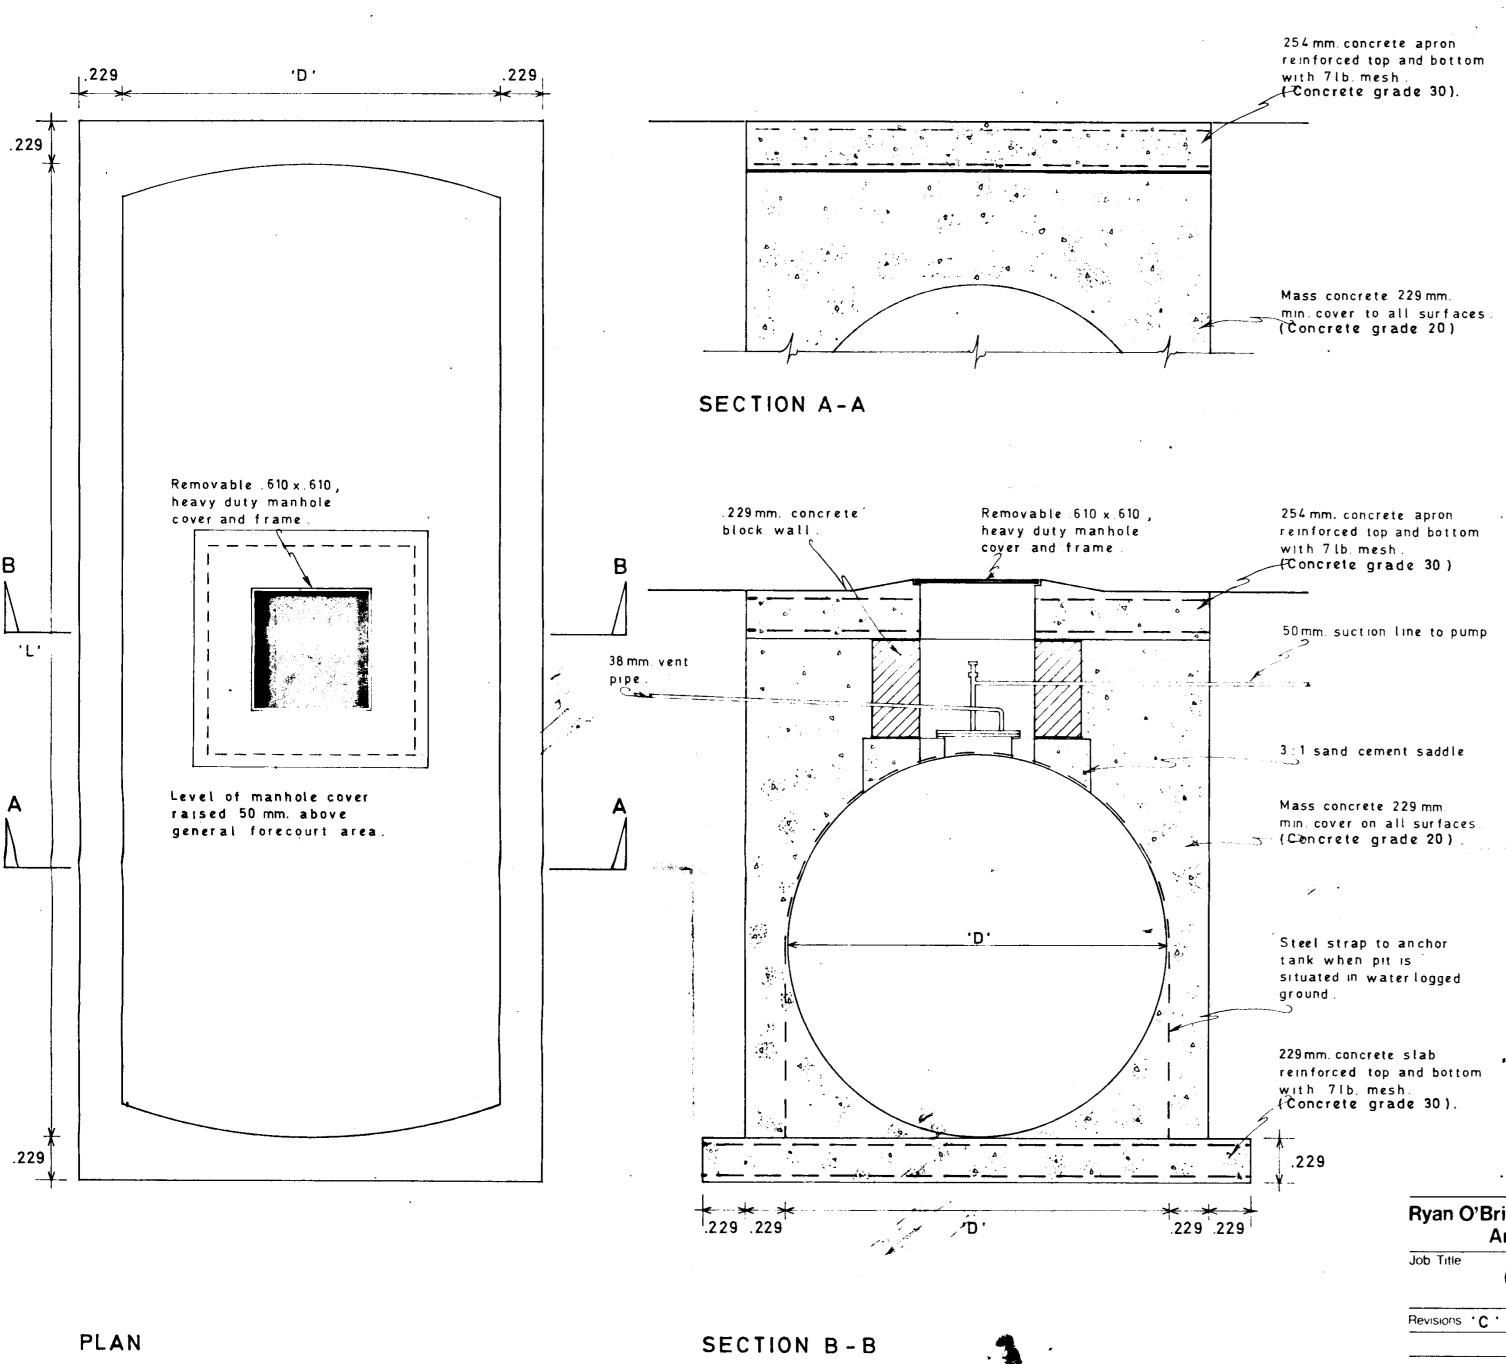

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### NOTES

- 1) When the chamber has been excavated and the bottom reinforced concrete slab cast, it will be the contractors responsibility to inform the Fire Officer so that the chamber can be inspected before the tank is installed.
- 2). The tank is to be encased in mass concrete 229mm. minimum cover on all surfaces.
- 3). All pipework, vent pipes, connections etc. to be carried out by a specialist firm .
- 4). The contractor is to include for attendance to specialist firm in digging trenches, making good ground surfaces etc.
- 5). The contractor is to supply and fit heavy duty manhole covers and frames as specified

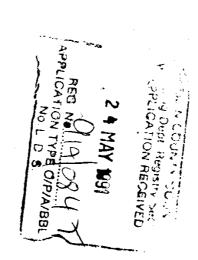

Capacity -gals.	Approx.tank weight	Diameter 'D'	Lenght 'L'
. 600	1/2 ton	1.372	. 2.108
1000	1 ton	1.372	3.327
1500	1 <sup>1</sup> /4 tons	1.981	2.591
2 000	1 <sup>1</sup> /2tons .	1.981	3.327
2500	1 <sup>3</sup> /4 tons	1.981	4.046
3 000	2 tons	1.981	4.826
4 000	2 <sup>1</sup> /2tons	1.981	6.299
5000	2 <sup>3</sup> /4tons	1.981	7.798
6 000	31/2tons	€ 1.981	9.296
7500	41/4 tons	2.743	6.858
10000	43/4 tons	2.743	8.585
12 000	51/4 t ons	2.743	9.906
6000	31/2 tons	2.743	5.334

Ryan O'Brien Handy Associates **Architects & Designers** 

18 Rathfarnham Village Dublin 14. (01) 904171 37 Dublin St. Carlow Co. Carlow (0503) 42043

# COUOCO


Revisions 'C' Level of mh. cover raised. (oct. 82).

Date Jan. 1981 Scale 1:20 Drawn ND.

UNDERGROUND STORAGE TANK INSTALLATION DETAILS

Drawing no

600 / 16 c.

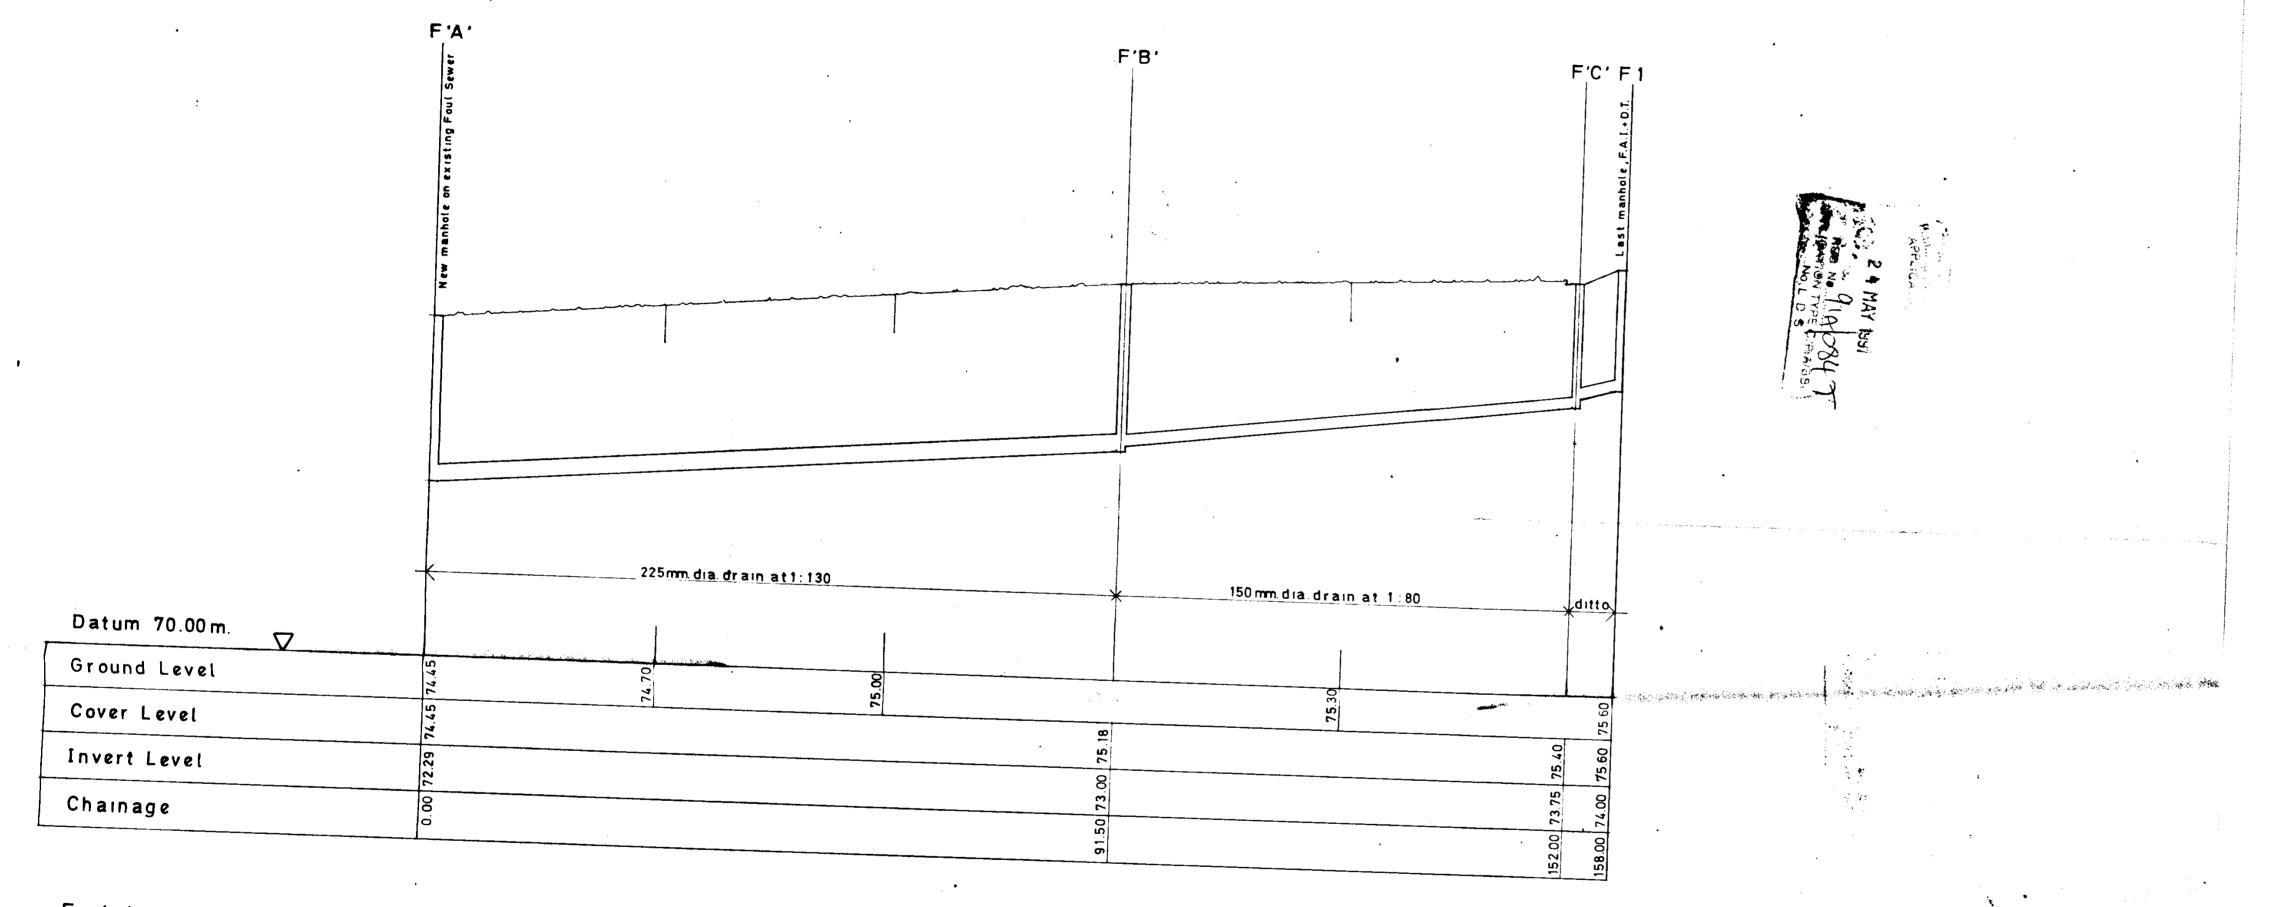

Foul drainage section between existing foul sewer MH. F'A' and last foul manhole on site MH. F1.


## NOTES

- 1). All works shall be carried out with the approval of Dublin County Council, Sanitary Services Department.
- 2). All drains to have 150mm. minimum concrete (grade 12) bed and surround.
- 3). Foul and Petrol Contammated manholes to be rendered both inside and outside.
- 4). Heavy duty manhole covers and frames used throughout.
- Covers and frames to comply with B.S. 497. 5). This drawing to be read in conjunction with drwg. no.s 3225 / 04 & 05

Revisions:
Use only ligured dimensions
Petrol Filling Station, Tymon/Balrothery Road, Dublin 24.

Mr. R. Martin

		ROBH ARCHITECTS & LASIGNERS	
Date: May 1991		Ryon O'Brion	
Scale: Hor	ız. 1:500/Vert.1:50	Handy Associates	
	Drawing Copyright ©	6 Percy Place Dublin 4	
	3225/07.	III Wellington Street Luton LUI 5AF	
Drawing no.:	5223707.	Telephone 680 899 Focimile 680 089	

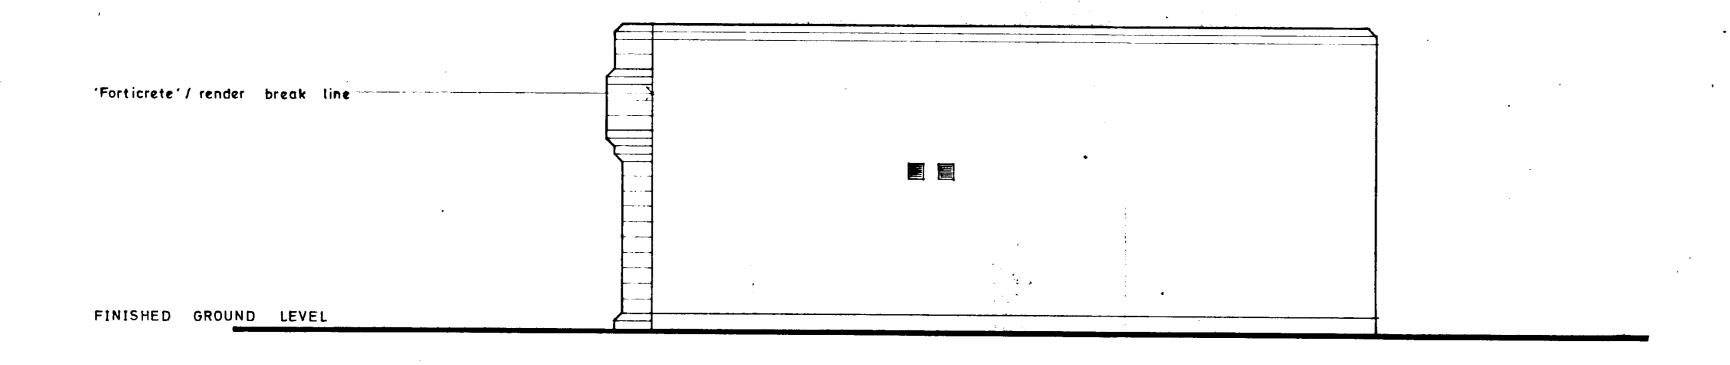

SIDE ELEVATION

White 'Forticrete' d.c.m. coping blocks..... on d.p.c. Galvanised steel lintol installed to manufacters details over structural Aluminium seamless gutter fixed to marine ply fascia. C.I. (galv.) cover to vent. Smooth rendered finish painted with 'Tyrolean' finish. .... \_fitted with approved panic bolt. Concrete plinth. \_\_ FINISHED GROUND LEVEL

REAR ELEVATION


Mr. R. Martin


Date: May '91 Scale: 1:50 Use only figured dimensions. Drawing Copyright ©


Petrol Filling Station, Tymon/Balrothery Rd., Dublin 24.


3225/06B


6 Percy Place Dublin 4 111 Wellington Street Luton LUI SAF Telephone 680 899 Facimile 680 089

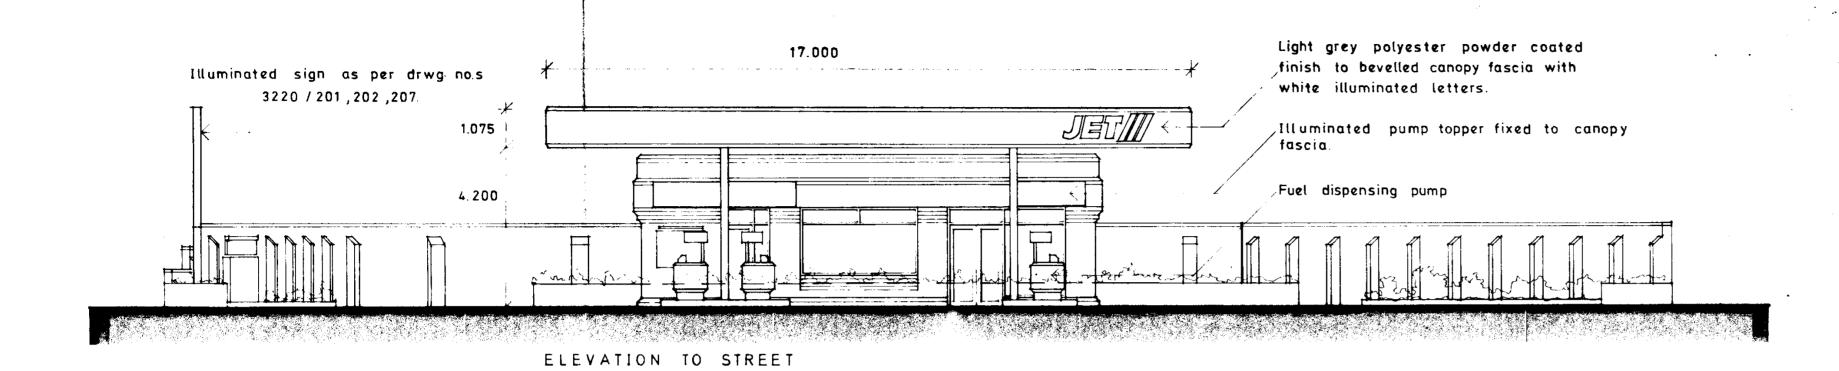

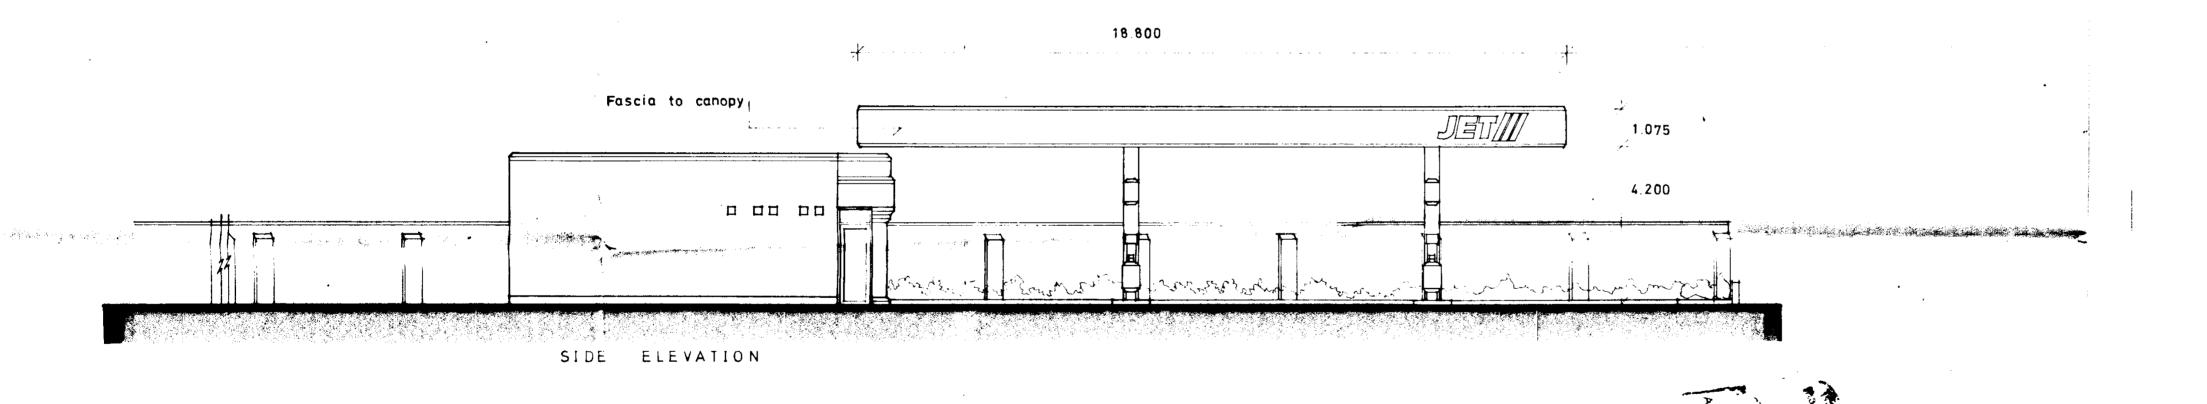

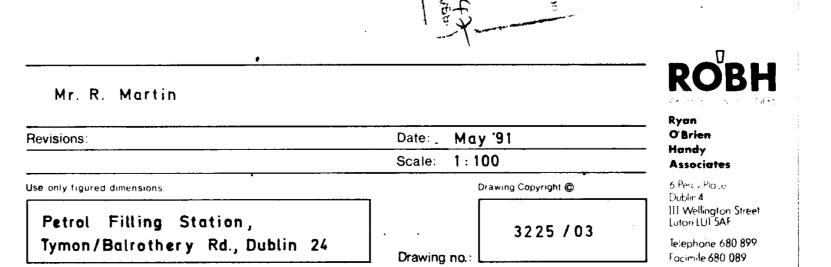

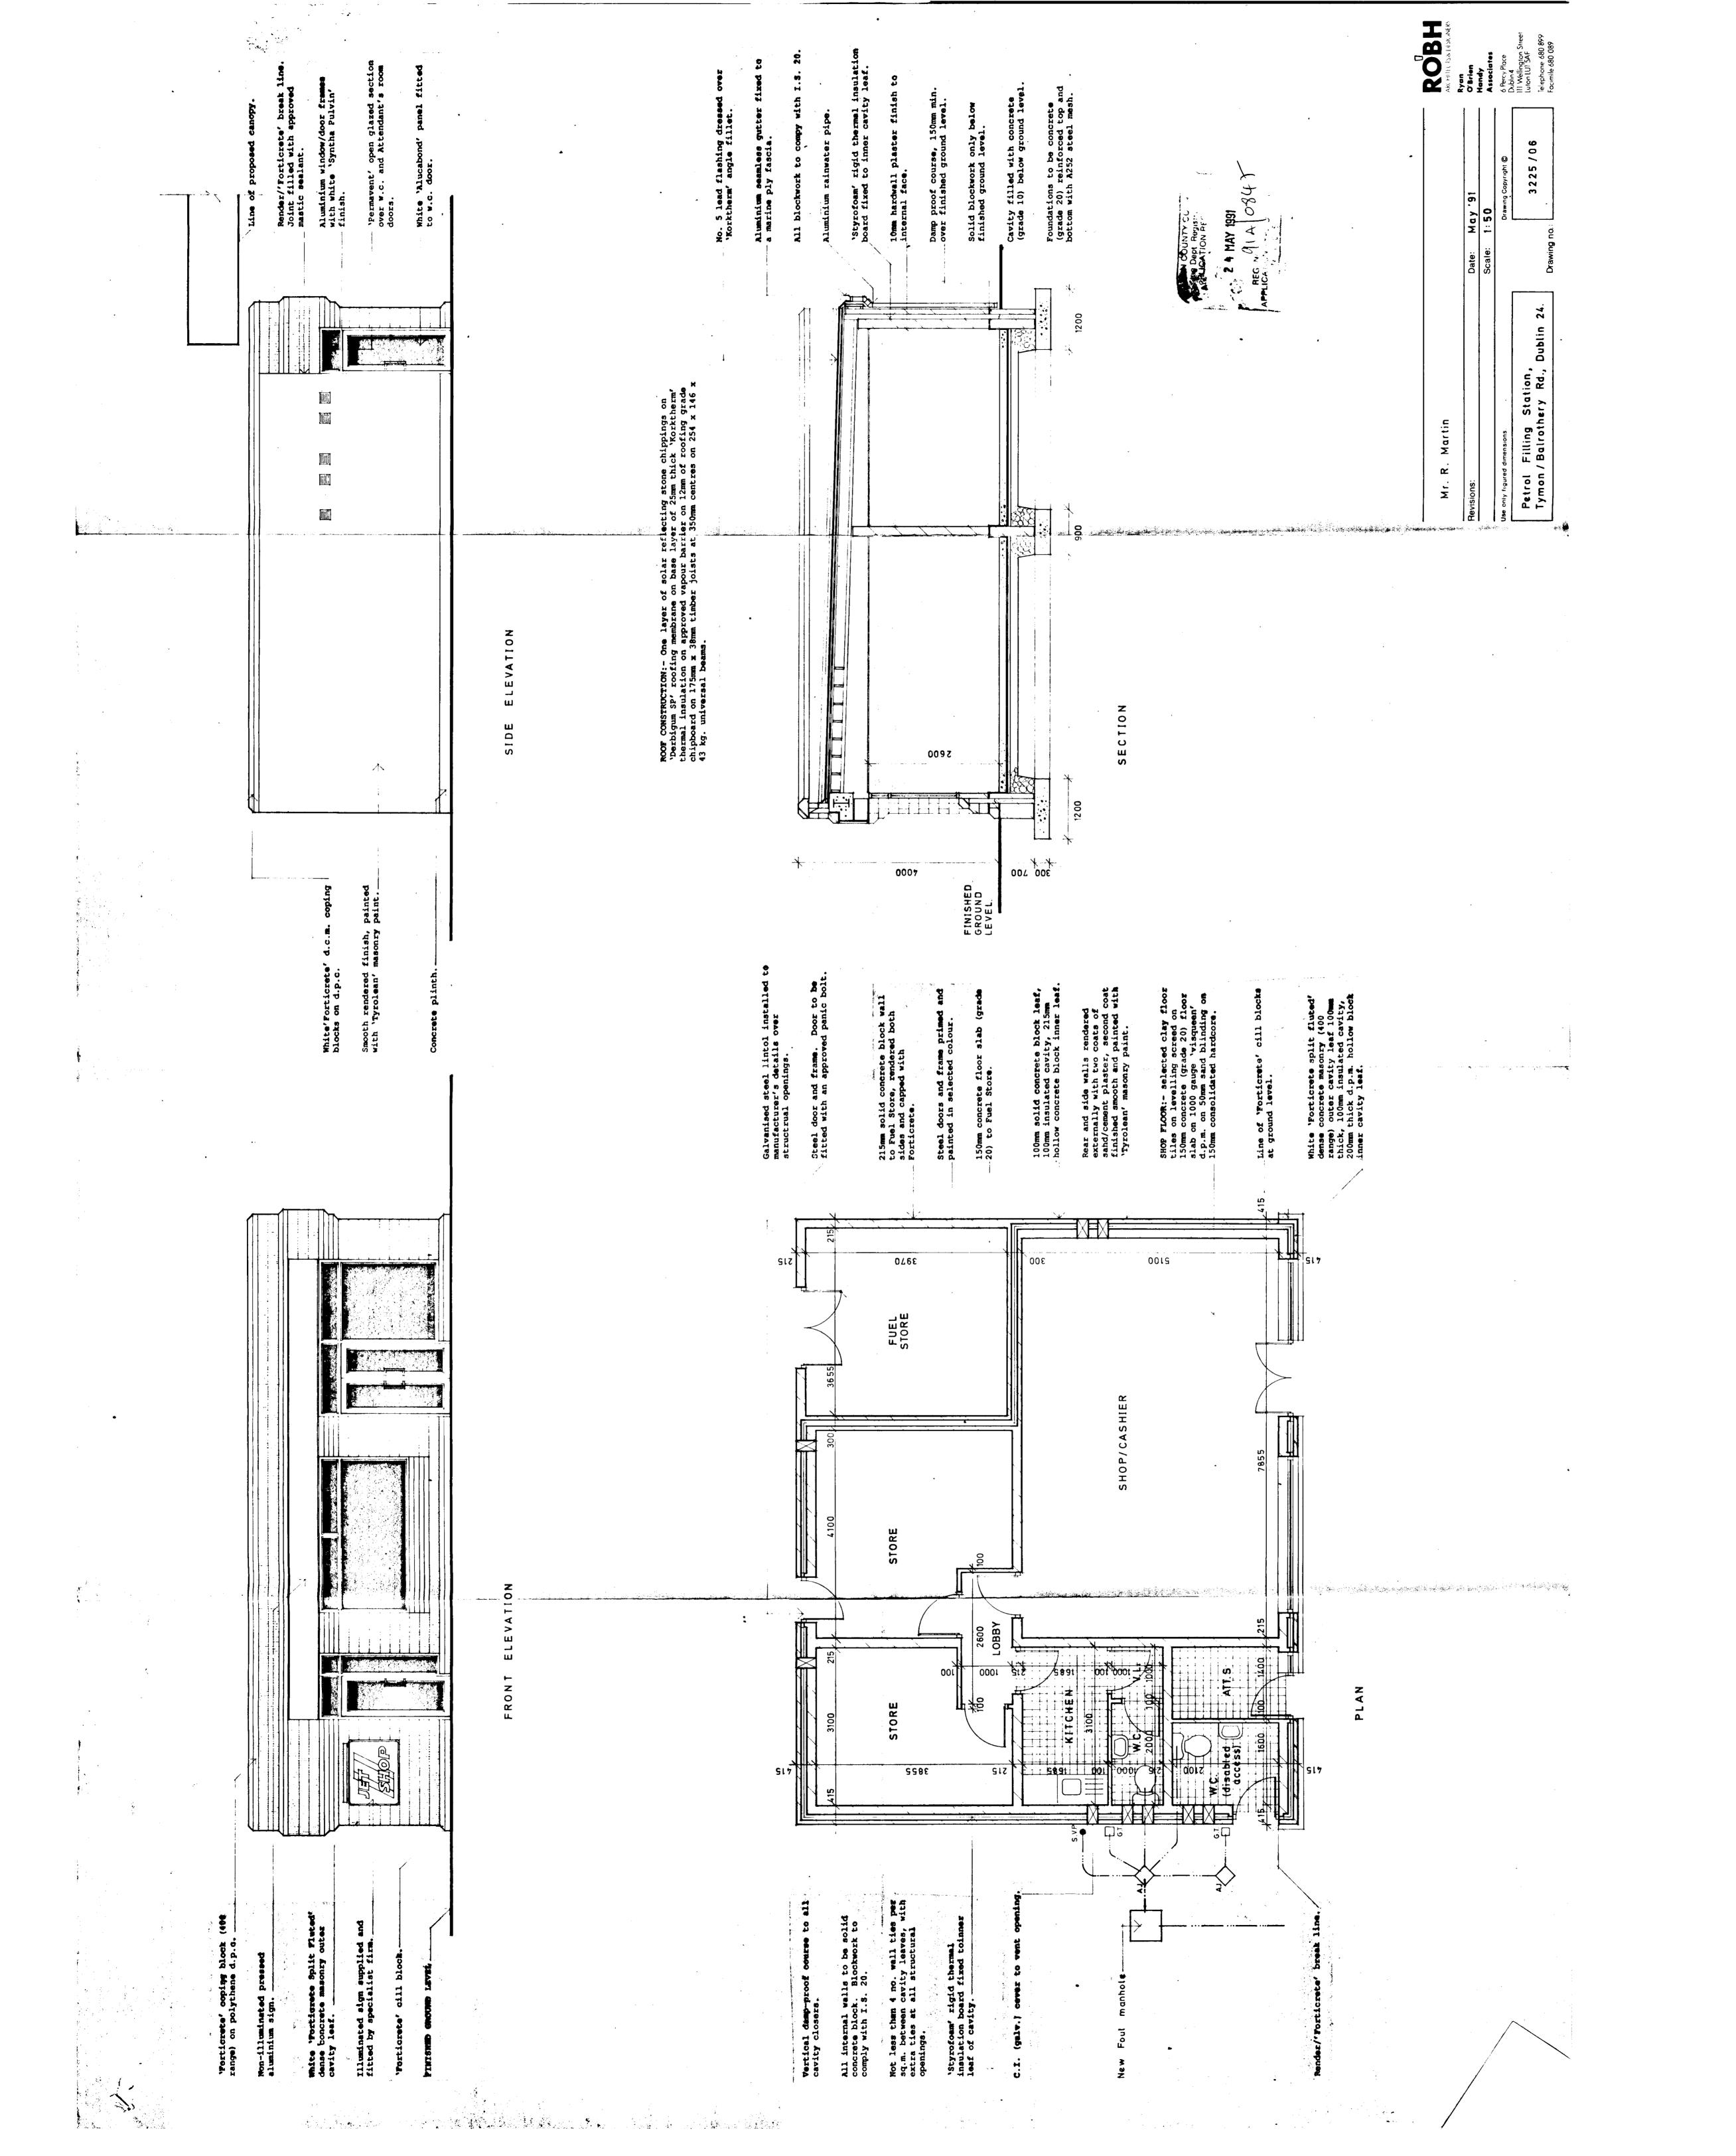

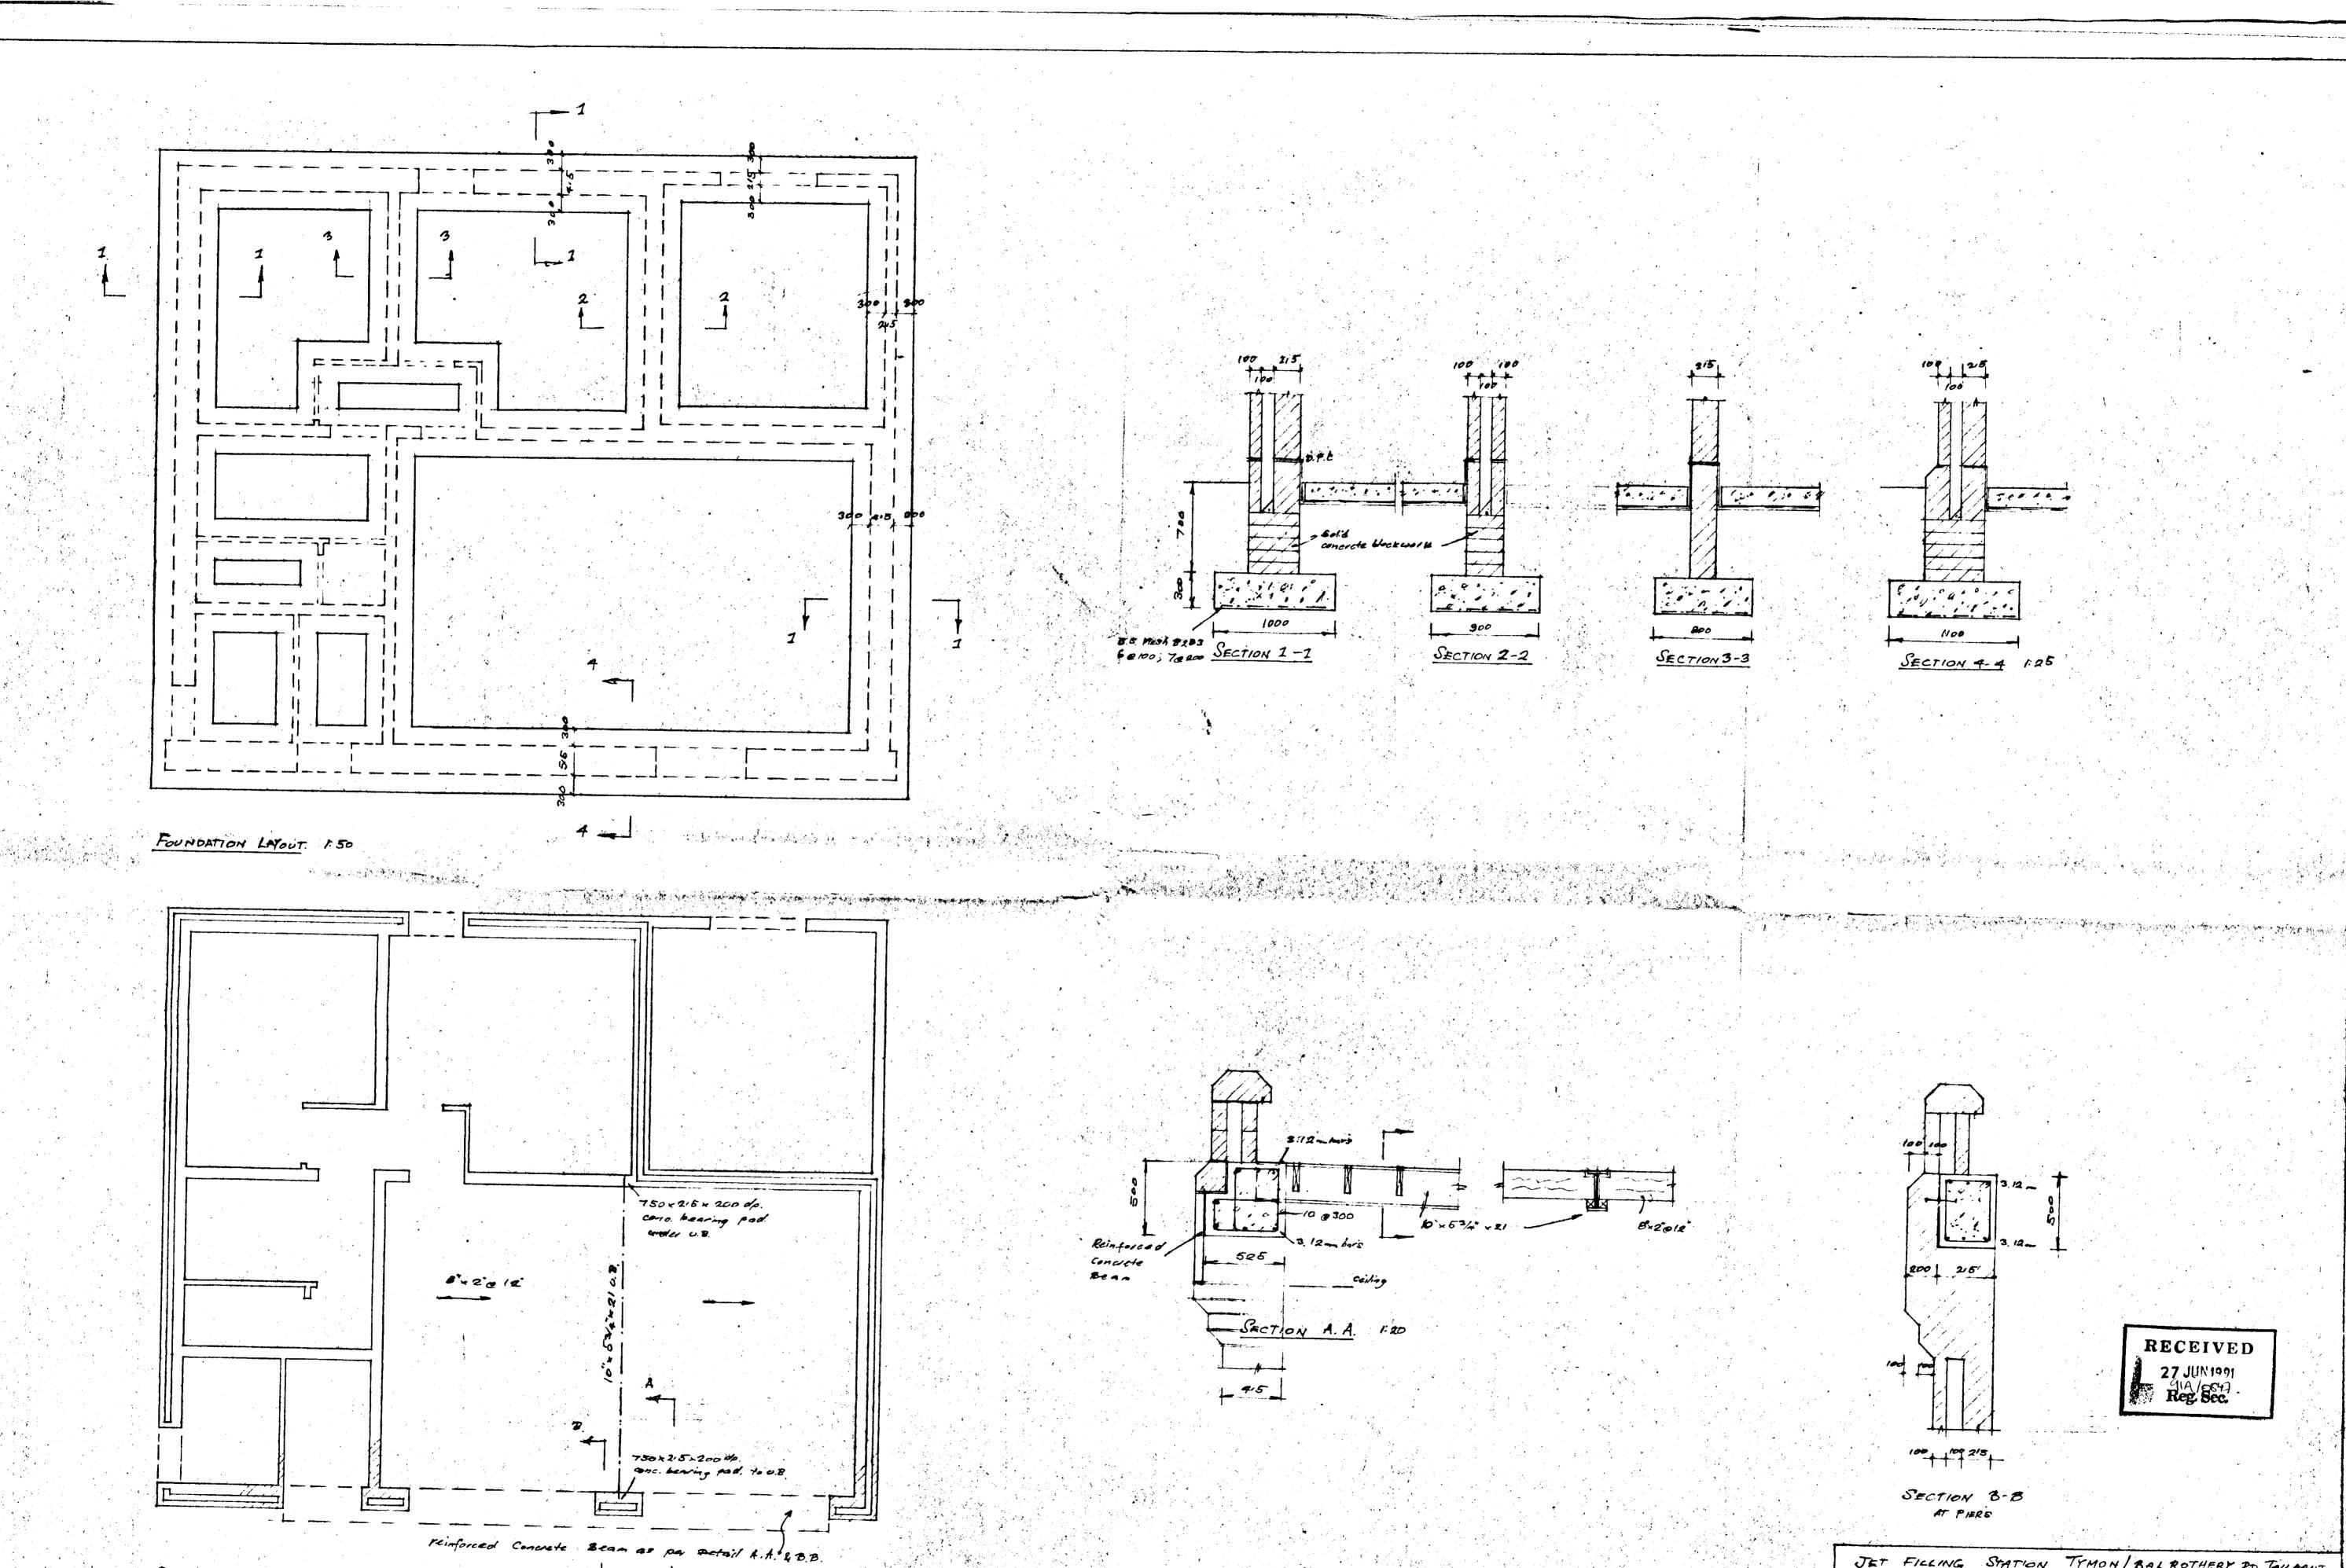

ROOF LAYOUT


JET FILLING STATION. TYMON/BALROTHERY 2D. TALLAGHT.

date: 8.6 & FOUNDATIONS & ROOF DEG 858/3995

SHRUCTURAL DETAILS, Scale: 1.50, 125
1:20

Ryan O'Brien & Handy. Arthur W. West & Associates Architects, Consulting Engineers.

6 Percy Place, Dublish. 25 Combining Rd. 26.

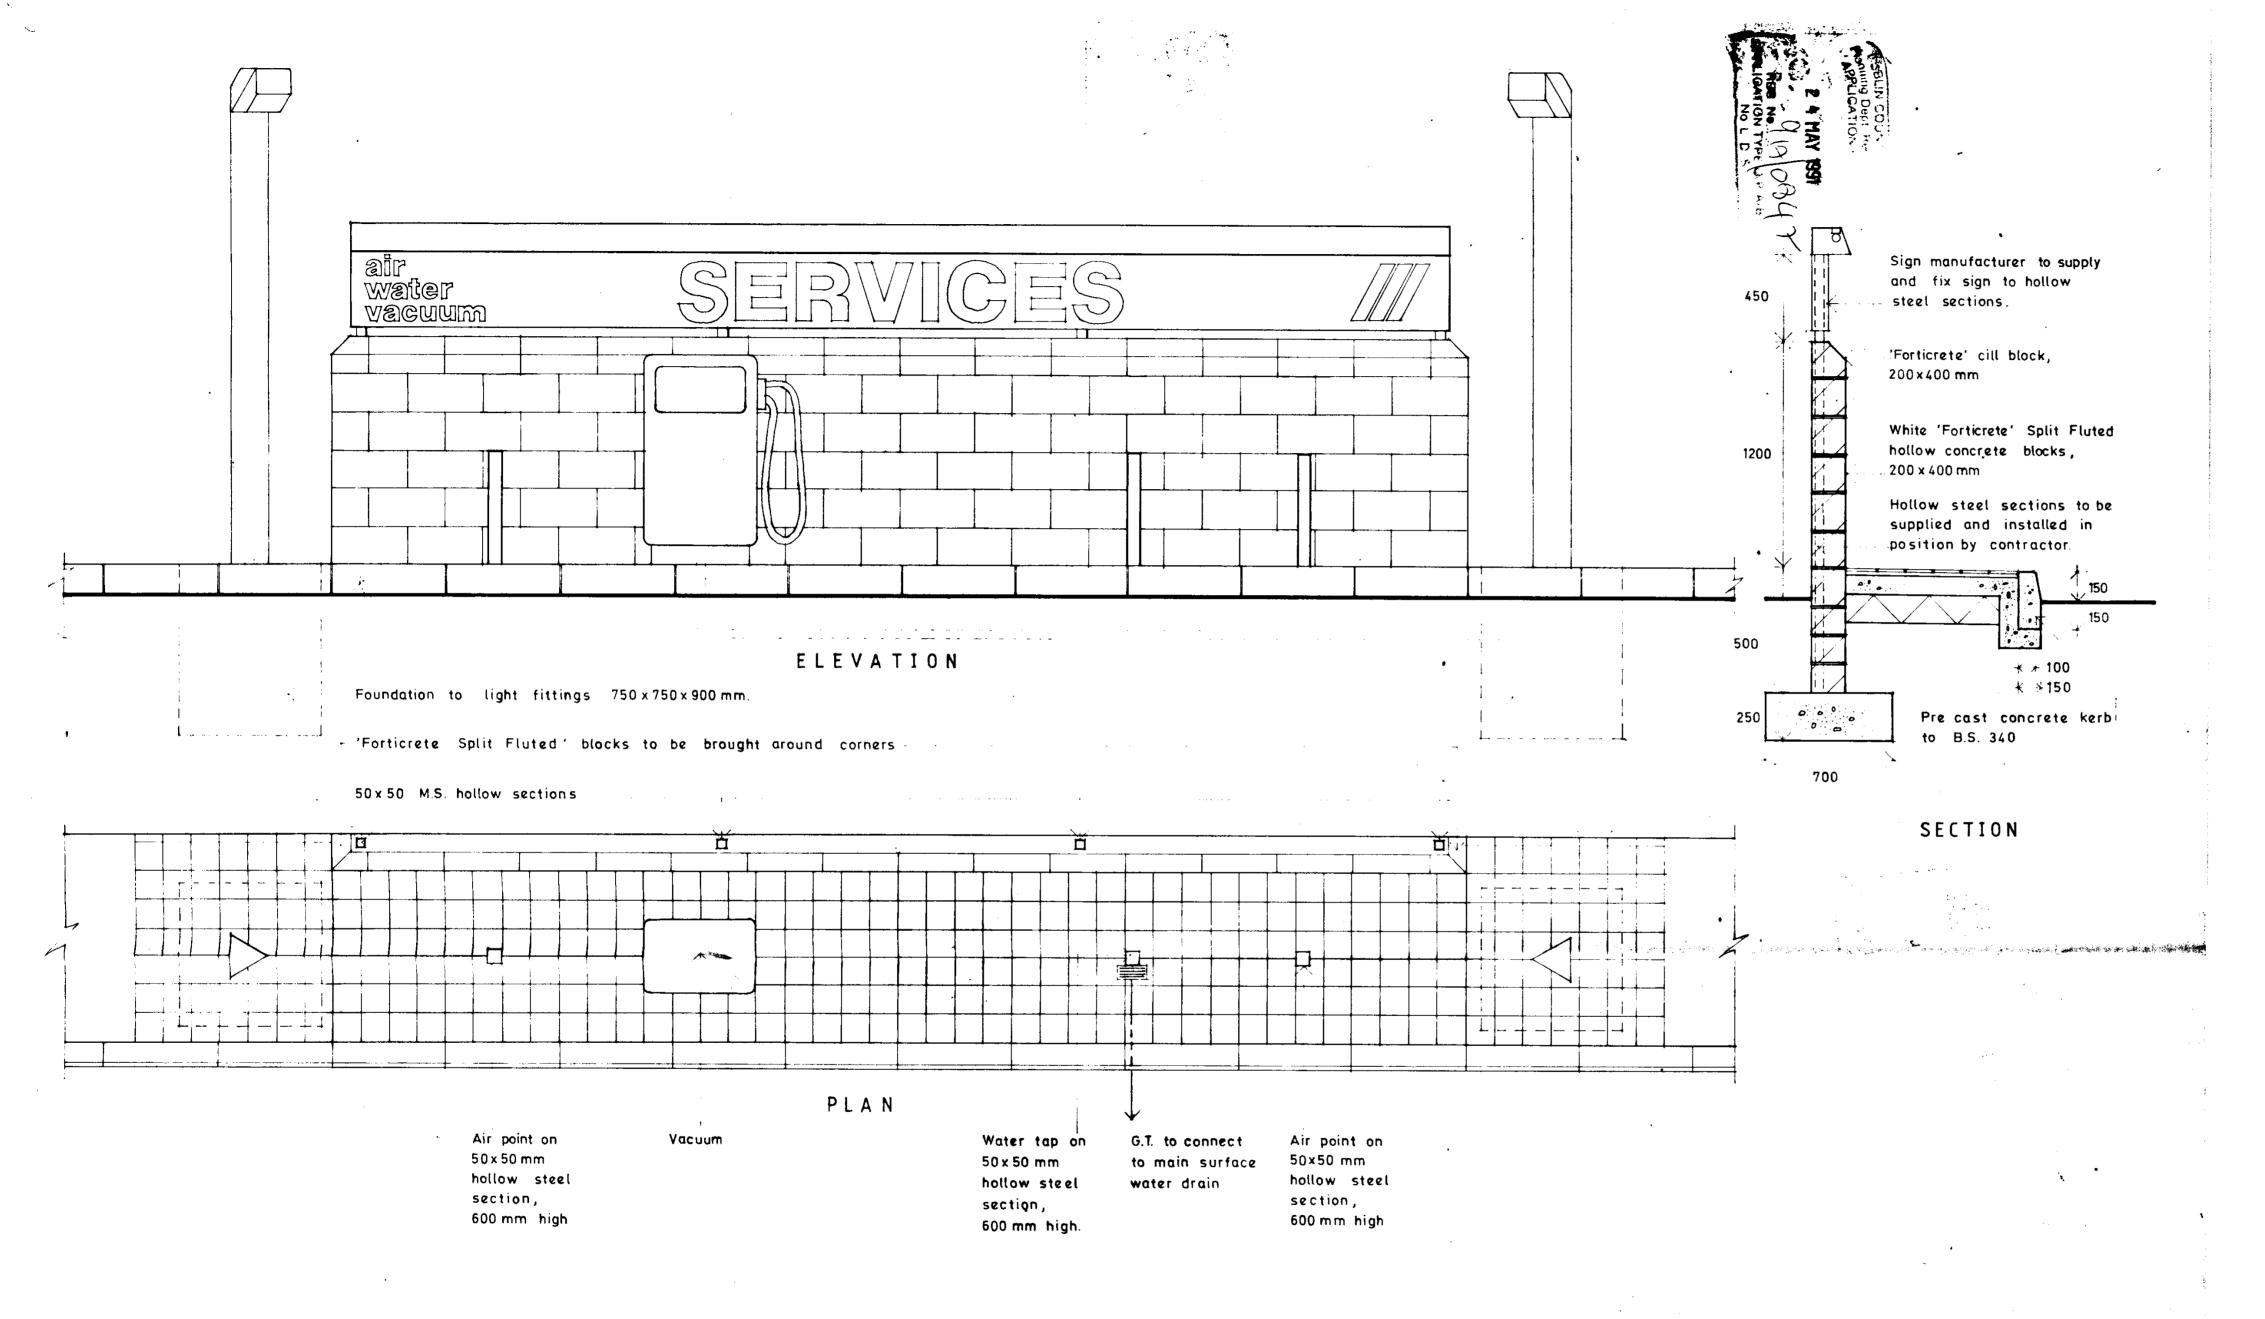


#### GENERAL NOTE :-

Electrical ducting to be brought to centres of vacuum point and light fittings (50 mm ducting) and to any one of hollow steel sections (25 mm ducting). Pull wires to be installed in all electrical ducts.

Ryan O'Brien Handy Associates Architects & Designers	38 Percy Place, Dublin 4. 680899 Fax 68008 111 Wellington Street, Luton LU1 5AF (0582)40149	
CONOCO	•	
Revisions	Date	March 91
	Scale	1:20
Proposed Service Area	Drawing no.	3220 / 112

-

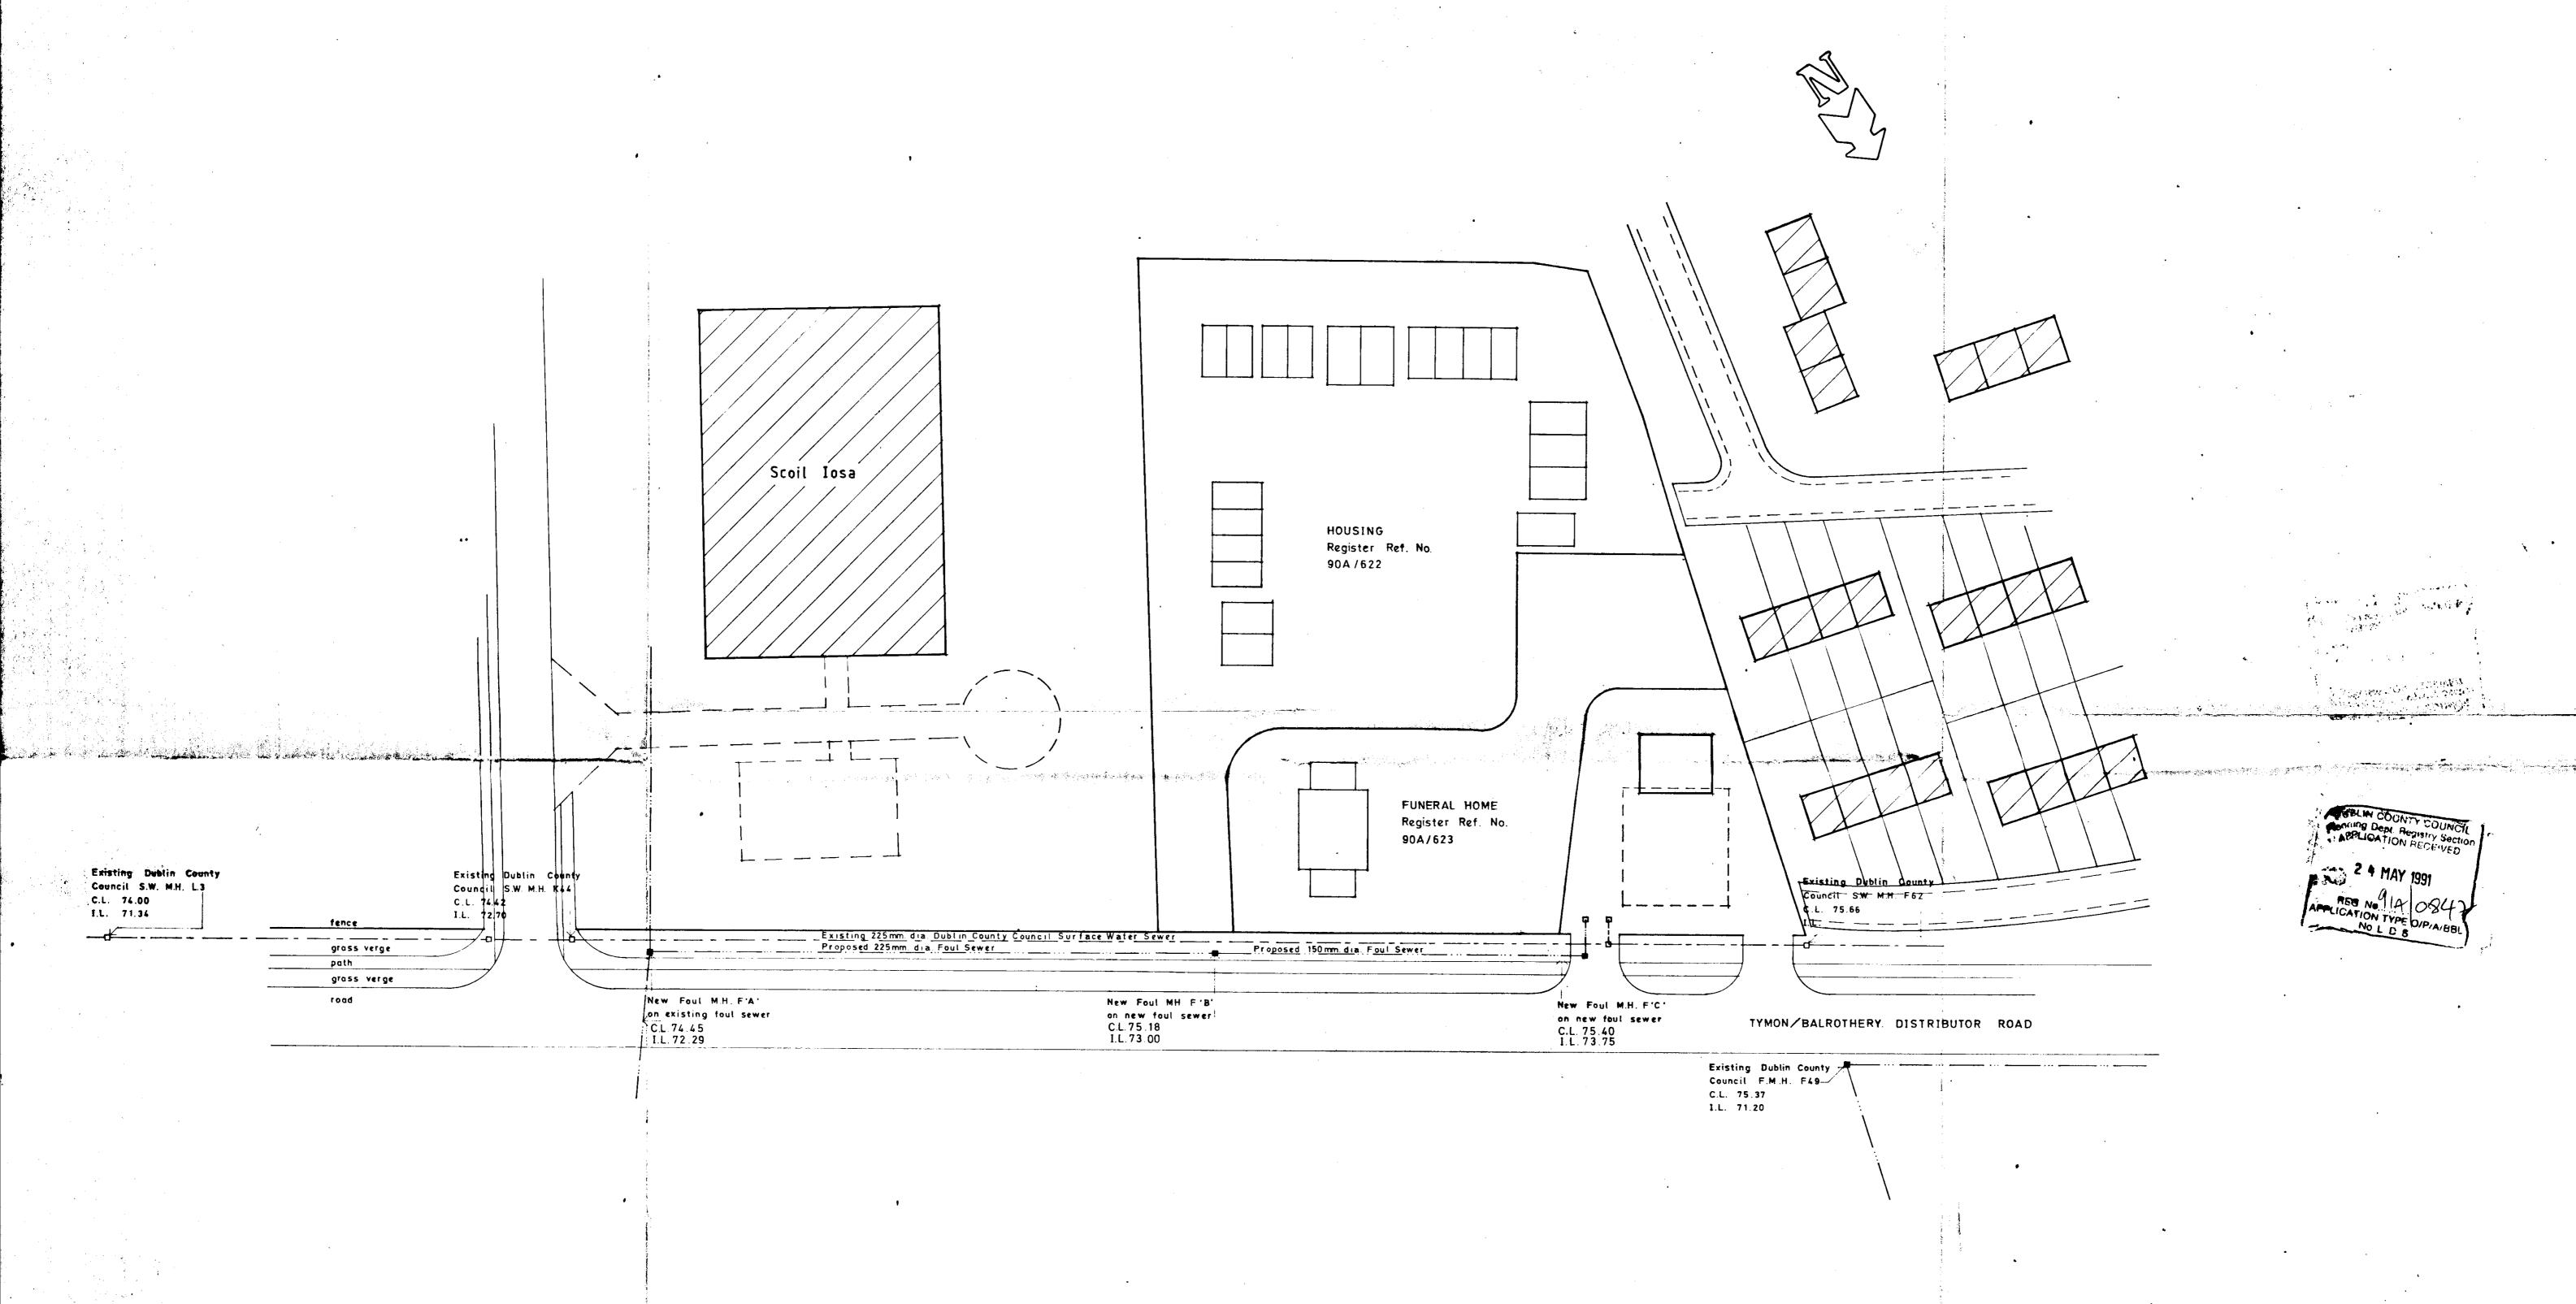

## NOTES

- 17. Att works shall be carried out with the approval of Dublin County Council, Sanitary Services Department.
- 2). All drains to have 150mm. minimum concrete (grade 12) bed and surround.
- 3). Foul and Petrol Contammated manholes to be rendered both inside and outside.
- 4). Heavy duty manhole covers and frames used throughout.

  Covers and frames to comply with B.S. 497.
- 5). This drawing to be read in conjunction with drawing no.s 3225/04&07

Mr. R. Martin

Revisions:	Date: May '91
	Scale: 1: 500
Use only ligured dimensions	Drawing Copyright ©

Petrol Filling Station,
Tymon/Balrothery Rd., Dublin 24

3 2 2 5 / 0 5

6 Percy Place
Dublin 4

III Wellington Street
Luton LUI, 5AF

Telephone 680 899
Facimile 680 089

Line of pre-cast concrete - kerbing The installation of underground petrol storage tanks is as per fire-officers requirments as required by condition no.3 of permission reg. no. 90A/625 Existing dwellings ..Concrete / tarmacadam break line 4 no. \*, the all under ground fuel storage anks, installed in accordance with dwc to 600/16c. 3,000 gal. water storage tank Existing boundary wall Concrete apron 250 mm deep concrete (grade reinforced top and bottom with A 252 steel Building to be constructed in accordance with drwg no. 3225/06 and engineers details and specifications. FUEL STORE 6.000 1.700 New boundary wall. SHOP  $(40 \text{ m}^2)$ STORE accordance with drwg. no. 600 / 11B A CONTRACTOR OF THE PROPERTY O Tarmacadam surface :- 25 mm of 10 mm nominal size macadam to B.S. 4987 on 50mm OFFICE of 20mm nominal size open textured coated macadam to B.S. 4983 Line of canopy over, 4.200 m high to underside, with a 1.05 m fascia panel above Canopy erected by a specialist firm. Tarmacadam/concrete pavers break 'ACO' gully with rodding/cleaning Pump islands, 150mm high concrete Concrete paving setts laid line. (grade 20) finished with selected clay in accordance with quarry tile and stainless steel trim; manufacturers specification. 'ACO' drainage channel (type C250) Line of pre-cast concrete kerbing constructed as per drwg. no. 600/37 laid to fall in accordance with manufacturers details and Service island constructed in with specification. drwg no. 3200/112 Illuminated sign as per drwg.no.s 3200/201,202,207 Mr. R. Martin Revisions: Date: May '91 Scale: 1:100 / Use only figured dimensions Petrol Filling Station, 3225, Tymon/Balrothery Rd., Dublin 24

