BYF:	TAW	APPLICATION	FFFS
ببد	J. H. 19 4		بحستا

REF. NO.: _	914/1993		<u>:</u> .	CERTIFICATE NO.:	17 LIB1 B
PROPOSAL: _	Petrol	Filling	State	i = shop	
LOCATION: _	White ch	urcL	Rd.,	Kathfornham	•:
APPLICANT:	Conoco	100.	42.	_	

; 5-

	1	2	3	4	5	6	7
CLASS.	DWELLINGS/AREA LENGIH/STRUCTURE	RATE	AMT. OF FEE REQUIRED	AMT. LODGED	BALANCE DUE	RED. FEE APPL.	AMT. OF RED. FEE
A	Dwelling (Houses/Flats)	@ £55					
В	Domestic Ext. (Improvement/ Alts.)	@ £30					
C Le 24US9	Building for office or other comm. purpose	@ £3.50 per M ² or £70	7343	340.zo	£2.80	net sow	8L+
D	Building or other structure for purposes of agriculture	@ £1.00 per M ² in excess of 300 M ² Min. £70					
E	Petrol Filling Station	@ £200	£200	1200			
F	Dev. of prop. not coming within any of the forgoing classes	£70 or £9 per .1 hect. whichever is the greater				·.	

Column 1 Certified:	Signed:	Gr	rade:	Date:
Column 1 Endorsed:	Signed:	Gr	ade:	Date:
Columns 2,3,4,5,6 &	7 Certified:	Signed: M. Roone	Grade: III	Date: <u>20/2/92</u>
Columns 2,3,4,5,6 &	7 Endorsed:	Signed:	Grade:	Date:

FILE DISCUSSED AT COUNCIL/COMMITTEE MEETING

FILE REF: GIA 1993

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MEETING	COMMENTS	NOTED IN DEV. CONTROL	NOTED BY	
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DIANNING APPLICATION FEES

	,	PLANNING	APPLICATION	FEES	_	
Reg. I	Ref. 914/1993			Cert	No. 2745	Ĵ
PROPOSAL Planol Filly State + Shor						
Reg. Ref. (1979 8 Cert. No. 1980) PROPOSAL Planol Filly Station + Shor LOCATION for Betad Filly Station, Whitechied Road Royalfornian APPLICANT. Conoco Ineland Ital						
ADDI.TO	DNOT CONOCO	Ineland	Ud.			
F1L 1 11L						2,1000
CLASS	UWELLINGS/AREA LENGTH/STRUCT.	RATE	AMT. OF FEE REQ.	AMOUNT LODGED	BALANCE DUE	BALANCE PAID
1	wellings	@£32				
2	Domestic,	@£16				
3	Agriculture	<pre>@50p per m2 in excess of 300m2. Min. £40</pre>				
4	Metres 97.10~~	@£1.75 per m2 or £40	2 171-50	P 40.10	1: 40	notset.
5	x .1 hect.	<pre>@£25 per .1 hect. or £250</pre>	,			
δ	x .1 hect.	0£25 per .1 hect. or £40				
7	x .1 hect.	@£25 per .1 hect. or £100	-	,		
8		@£100	1100	+100		
9	x metres	@£10 per m2 or £40	<u>.</u>			
10	x 1,000m	@£25 per £1000m or £40				
11	x .1 hect.	0f5 per .1 hect. or f40				
Colum	nn 1 Certified:Sig	gned:	GI GI	ade D/T	Date	11/92
Colur	Column 1 Endorsed:Signed:GradeDate					
Colu	mns 2,3,4,5,6 & 7	Certified:Si	gned H	FGrado	Date.	141 n/9/
Colu	mns 2,3,4,5,6 & 7	Endorsed:Sig	ned:	Grade	Date	

LOCAL COVERNMENT (PLANNING AND DEVELOPMENT) ACTS, 1963 TO 1982

ASSESSMENT OF FINANCIAL CONTRIBUTION

REG.REF .: 914/1993

CONT. REG.:

CHECKED BY:


METHOD OF ASSESSMENT:


TOTAL ASSESSMENT:

MANAGER'S ORDER NO: P/ /

ENTERED IN CONTRIBUTIONS REGISTER:

DEVELOPMENT CONTROL ASSISTANT GRADE

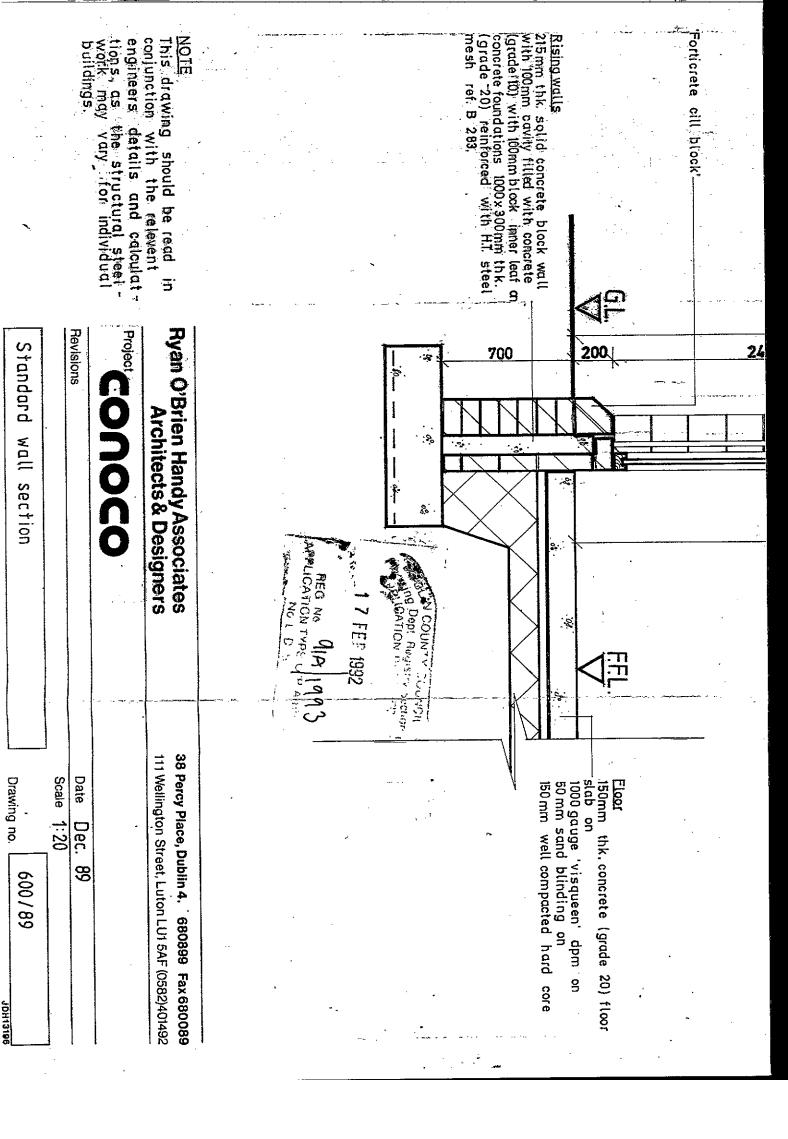

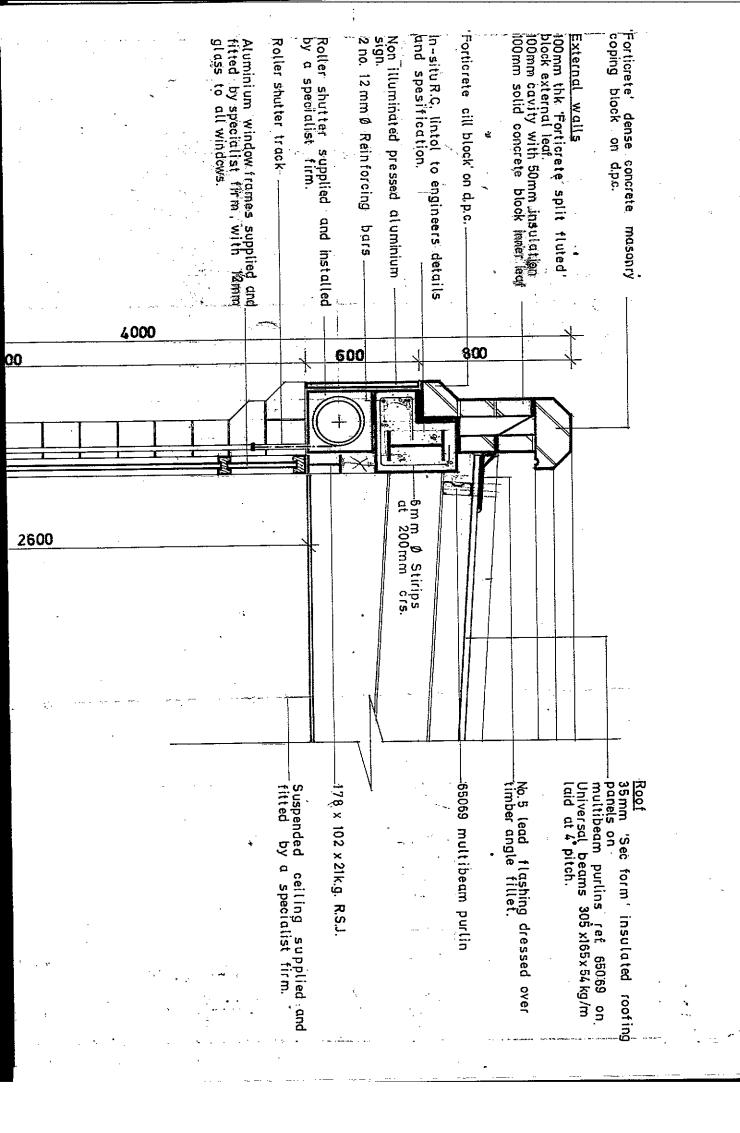

P/663/92

COMHAIRLE CHONTAE ÅTHA CLIATH

Record of Executive Business and Manager's Orders

BELGARD

Register Reference : 91A/1993

Date Received: 18th December 1991

Correspondence : Ryan O'Brien Handy Assoc.,

Name and : 6 Percy Place,

Address

Dublin 4.

Development : Redevelopment of Jet Petrol Filling Station, to include

a new shop/office/store building, replacement

underground petrol storage tanks and alterations to

existing canopy.

Location

: Jet Petrol Filling Station, Whitechurch Rd.,

Rathfarnham

Applicant : Conoco Ireland Ltd.,

App. Type : Permission

Zoning

: To protect and/or improve residential amenity.

Floor Area: 97-2 sq.metres

Mcs. (MOS/BB)

Report of Dublin Planning Officer dated 11th February, 1992.

This is an application for PERMISSION. The proposed development consists of the redevelopment of Jet Filling Station to include a new shop/office/store building, replacement underground petrol storage tanks and alterations to existing canopy at Jet Petrol Filling Station, Whitechurch Road, Rathfarnham. The applicant is Conoco Ireland Ltd.

Under Reg. Re. TA 1195, permission was granted for proposed additional underground petrol storage tank and alterations at Gatiens Service Station, WHitechurch Road, Rathfarnham.

The site is zoned 'A' in the 1983 County Development Plan with the objective "to protect and/or improve residential amenity".

The Whitechurch Road is affected by a specific long term road improvement objective in the 1983 Plan. This specific objective is excluded from the 199

CONTRIBUTION: Standard: Lo Qu

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Other:

SECUPTY:

Bond / C.I.F.:

Cash:

Record of Executive Business and Manager's Orders

Reg.Ref: 91A/1993

Page No: 0002

Location: Jet Petrol Filling Station, Whitechurch Rd., Rathfarnham

Draft Development Plan.

The site is located to the south of existing factories on Whitechurch Road.

The existing Petrol Station presently accommodates a shop (c. 71.3 sq. metres in area), 2 no. small stores which are used for the storage of ful@ and groceries etc. and three no. pumps (2 no. petrol and 1 no. diesel).

The shop sells general groceries, and also has a video library.

There are 2 no. signs c. 1.7 metres high along the site frontage, which is formed by a dwarf wall.

PROPOSAL

It is proposed to:-

- (i) construct a new shop (58.41 sq. metres floor area) office and store at the rear of the site,
- (ii) install two new underground fuel storage tanks as well as an overground diesel fuel storage tanks,
- (iii) install 2 no. pump islands (each containing 2 no. pumps) and a new canopy.

The proposed canopy is set back a similar distance from Whitechurch Road as the existing canopy (i.e. 4.6 - 4.75 metres). It is 5.27 metres high.

The proposed shop/office block is located in a similar position on the site as the existing building. Proposed external finishes include white 'forticrete split fluted' block on the front elevation. The proposed finish to the canopy consists of a light grey polyester powder coated finish with white illuminated letters.

It is proposed to construct a forticrete planter 880 mm. in height along part

Record of Executive Business and Manager's Orders

Req.Ref: 91A/1993

Page No: 0003

Location: Jet Petrol Filling Station, Whitechurch Rd., Rathfarnham

of the front boundary of the site.

The proposed development will increase the petrol diesel storage capacity on the site by 28.5% from 49,500 litres (existing capacity) to 63,644 litres (proposed capacity).

REPORTS

The Roads Report dated 24/1/92 states the conditions which should be attached to any grant of permission. These conditions relate to (1) the level of illumination (2) the treatment of the footpath at the entrances to the site.

The Sanitary Services Report dated 4/2/92 states that services are available as indicated and notes that the site is affected by the provisions of the water gollution act.

The proposed development will improve the visual appearance of the premises. There is no objection to the proposal from a planning point of view.

I recommend that a decision to GRANT PERMISSION be made under the Local Government (Planning and Development) Acts, 1963-1990 subject to the following (//) conditions:-

CONDITIONS/REASONS

- 01 The development to be carried out in its entirety in accordance with the plans, particulars and specifications lodged with the application save as may be required by the other conditions attached hereto.

 REASON:To ensure that the development shall be in accordance with the permission and that effective control be maintained.
- 02 That before development commences, approval under the Building Bye- Laws be obtained and all conditions of that approval be observed in the development.

REASON: In order to comply with the Sanitary Services Acts, 1878-1964.

Record of Executive Business and Manager's Orders

Reg.Ref: 91A/1993

Page No: 0004

Location: Jet Petrol Filling Station, Whitechurch Rd., Rathfarnham

Of that a financial contribution in the sum of £ be paid by the proposer to the Dublin County Council towards the cost of provision of public services in the area of the proposed development and which facilitate this development; this contribution to be paid before the commencement of development on the site.

REASON: The provision of such services in the area by the council will facilitate the proposed development. It is considered reasonable that the developer should contribute towards the cost of providing the services.

That no flag poles or bunting shall be erected on the site without the prior approval of the Planning Authority.

- REASON: In the interest of the proper planning and development of the area.
- Prior to commencement of development to applicant is to ascertain the requirements of the Chief Fire Officer. The applicant is to strictly adhere to these regulations in the development.
 - In the interest of safety and the avoidance of fire hazard.
- Prior to commencement of development the applicant is to ascertain the requirements of the Supervising Environmental Health Officer. The applicant is to strictly adhere to these regulations in the development.
 - % In the interest of public health.
- That no L.P.G. tanks are to be provided on site without the prior approval of the Planning Authority.
 - REASON: In the interest of the proper planning and development of the area.
- Of That the height of the proposed illuminated sign at the front of the site is not to exceed the height of the canopy.
 - REASON: In the interest of the proper planning and development of the area.
 - That the footpath at the entrance is to be treated in accordance with regulations of the Area Engineer, Roads Maintenance Section of Dublin County Council.
 - REASON: In the interest of the proper planning and development of the

aw

Record of Executive Business and Manager's Orders

Reg.Ref: 91A/1993

Page No: 0005

Location: Jet Petrol Filling Station, Whitechurch Rd., Rathfarnham

area.

- That the level of illumination at the site is to be in accordance with the regulations of the Roads Department. In this regard the level of illumination and orientation of any lamps may be reviewed at any time by Dublin County Council. Any required alterations requested by Dublin County Council are to be carried out at the applicants expense.
 - MA REASON: In the interest of the proper planning and development of the area.
- That the proposed external door from the store is to be omitted from the proposed development.

 REASON: The door opens directly onto a laneway used by the adjoining factories. The location of a door in this position would be prejudicial to public safety.

That the requirements of the Sanitary Services Department be ascertained and complied with in the development.

RESON: In order to comply with the Sanitary Services Acts, 1878-1964.

is that the Water Surply & dealers a marghest 5 tradely the desired with the requirements NOTE 1: The applicant should note that the proposed development of the San Secrets must adhere to the requirements of the Dangerous Substances Act, 1970. Deal

NOTE 2: The applicant should note that the provision of the Water Pollution Act must be adhered to.

Record of Executive Business and Manager's Orders

Reg.Ref: 91A/1993

Page No: 0006

Location: Jet Petrol Filling Station, Whitechurch Rd., Rathfarnham

for Dublin Planning Officer

for Principal Officer

13/2/9

order: A decision pursuant to section 26(1) of the Local Government (Planning and Development) Acts, 1963-1990 to GRANT PERMISSION for the above proposal subject to the ()) conditions set out above is hereby made.

Dated: \(\frac{3}{3} \) FEBRUARY 1992

ASSISTANT COUNTY MANAGER/APPROVED OFFICER City and County Manager dated | Officer | 1991. | 1991. | 1991.

DUBLIN COUNTY COUNCIL

REG. REF:

91A-1993

DEVELOPMENT:

Petrol Filling Station

LOCATION:

Whitechurch Road, Rathfarnham

APPLICANT:

Conoco Ireland Ltd.

DATE LODGED:

18.12.91

The proposal is for redevelopment of the Jet Filling Station on Whitechurch Road. A new shop unit is proposed to replace the existing.

If permission is being granted, it should be subject to:-

- 1. Illumination to be to the requirements of the Roads Department. In this regard the level of illumination and the location and orientation of the lamps to be reviewable at any time and alterations made at the applicants' expense if requested by Dublin County Council.
- 2. Footpath at the two entrances to be treated to the requirements of the Area Engineer, Roads Maintenance at the ____ applicant's expense.

DEPT.
NTROL SECT
Q)
.30

GC/MM 24.1.92

signed:	ENDORSED:	4.15 mik
DATE:	DATE:	24/1/92

0

Register Reference : 91A/1993

Date: 8th January 1992

Development: Redevelopment of Jet Petrol Filling Station, to

include a new shop/office/store building, replacement underground petrol storage tanks and alterations to

existing canopy.

LOCATION

: Jet Petrol Filling Station, Whitechurch Rd.,

Rathfarnham

Applicant

: Conoco Ireland Ltd.,

App. Type

: PERMISSION

Planning Officer : M.O'SHEE

Date Recd. : 18th December 1991

PLANNING DEPT. DEVELOPMENT CONTROL SECT

Date 10.02.92

Time 10.00

Attached is a copy of the application for the above development . Your report would be appreciated within the next 28 days.

yours faithfully,

DUBLIN Co. COUNCIL

15JAN 1992 Date received in Sanitary Services

SAN SERVICES

SANITARY STATE OF PRINCIPAL OFFERE -7 FEB 1992

FOUL SEWER

Available es indicated. Sile is subject to the provision of the Water Polletin

SURFACE WATER

Available as indicated.

Sujan note ran-off is subject to the propinions of the Ister Polletin Act.

SENIOR ENGINEER, SANITARY SERVICES DEPARTMENT, 46/49 UPPER O'CONNELL STREET,

DUBLIN 1

Alex 55

Salli 1/1/92.

Register Reference : 91A/1993

Date : 8th January 1992

	PLANNING DEPT. DEVELOPMENT CONTROL SECT Date /0. 02. 92
	Time /. CO
ENDORSEDDATE	
Water SUPPLY. Available	WSullwe- 24/1/92.
	Alda 54/866
	1 24/1/92
endorsed 75 College date	4/2/92

DUBLIN COUNTY COUNCIL

Building Control Depart Liffey House,	ment,			Planning De Irish Life	
Tara Street,		- · · · · ·	No. A service	Tower Abbey	Street,
Dublin 1.	<u> </u>			_Dublin 1.	
				Telephone:	
Telephone: 773066				Extension:	231/234
13/3/92		<u></u> : <u></u>	·	,	
			S		
LOCAL GO	VERNMENT (PLANNING	AND DEVELOPMENT)	ACTS, 1963	0 1982	
LOCATION:	Whitechurch Rd.,	Rathfarnham.	<u>-</u> .		
PROPOSED DEVELOPMENT:	Petrol filling s	tation & shop	· · · · · · · · · · · · · · · · ·		
APPLICANT:	Conoco Ireland I	td.	· · · · · · · · · · · · · · · · · · ·	· _ · · · · · · · · · · · · · · · · · ·	
PLANNING REG.REF.:	91A/1993				
DATE OF RECEIPT OF SUBMISSION:	17/2/92				-
			<u> </u>		
A Chara,					
With reference to above	. I acknowledge rec	eipt of applicati	on for:		
	•			•	
Building bye-law app	rova.I.	•			-
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			PRINC	IPAL OFFICER	
Ryan O'Brien Handy As	ssociates,	ee		e e e e e e e e e e e e e e e e e e e	·
6 Percy Place,		<u></u>	• • •		~
Dublin 4.				÷	-
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Dublin County Council Comhairle Chontae Atha Cliath



Bye - Law Application Form

PLEASE READ INSTRUCTION	S AT BACK BEFORE COM	PLETING FORM. ALL Q	UESTIONS MUST BE ANS	NERED.
 Application for Permission Out Approval should be sought only wh retention of structures or continuar 	line Permission Approval	Place / in appropriate	MY	
2. Postal address of site or building	Jet Petrol Fillin	g Station	***************************************	· · · · · · · · · · · · · · · ·
the comment of the second	10 -			
B. Name of applicant (Principal not A				
Address Conoco House	, Deansgrange, Co.	Dublin.	Tel, No. 289664	4
. Name and address of Ryan 0	'Brien Handy Assoc	ciates	***************************************	
person or firm responsible 6, for preparation of drawings	Percy Place, Dubl	in 4.	Tel. No680899	
Name and address to whichRV	an O'Brien Handy /	\ssociates.		
formcations should be sent 6,	Percy Place, Dubl	in 4.		
Brief description of	development-of-exi op/store building,	sting-patrol-fil	ling station; incl lands, storage tar	
Method of drainageMa	ins drainage 8.	Source of Water Supply .	Rising Main	******************
In the case of any building or build				
(a) Present use of each floor or use when last used.	Not applicable	**************************************	***************************************	
(b) Proposed use of each floor	Not applicable			
O Does the proposal involve demolitio or change of use of any habitable ho				
.(a) Area of Site				Sq. m.
(b) Floor area of proposed developme				•
				•
(c) Floor area of buildings proposed t State applicant's legal interest or estat				Sq. m.
State applicant's legal interest or estat (i.e. freehold, leasehold, etc.)		Freehold	·DW:::	***************************************
Are you now applying also for an appropriate of the Area of the Ar	proval under the Building By	a I mum2	REC. No. NS	7394
Please state the extent to which the D		ive been taken in account is	n your proposal:	
444-1054-1-41-1-1-1-4-1-4-1-4-1-4-1-4-1-4-1-4-	See attached not	ice.	£51	40.Z
List of documents enclosed with2	copies of specifi	cation, location.	map,	*************
Dr.	awing Nos: 2898/0	1 <u>, 02, 03, 04, 06</u>	. 600/6.16C.37	. 89
32	00/201, 202, 207.		*******************************	
Gross floor space of proposed develo	oment (See back)		·	
No of dwellings proposed (if any)N				•
Fee Payable £ 540. 20 Ba	sis of Calculation Class	3 (£200) + 97,20	sg.m.x £3.50 (£34)	0.20)
If a reduced fee is tendered details of	previous relevant payment s	hould be given		,
Signature of Applicant (or his Agent)	Upol Date	Date	17 February 199	32
Application Type	8	FOR OFFICE USE ONLY		
Register Reference		411/1993		
Amount Received £	**************************************	1. 22.2.2	RECEIVE	D
Receipt No	***********	BBL	17 FEB 1992	ļ
Date	*****************		REG. SEC.	

LOCAL GOVERNMENT (PLANNING & DEVELOPMENT) REGULATIONS 1977 to 1984.

Outline of requirements for applications for permission or Approval under the Local Government (Planning & Development) Acts 1963 to 1983. The Planning Acts and Regulations made thereunder may be purchased from the Government Publications Sales Office, Sun Alliance House, Molesworth Street, Dublin 2.

- Name and Address of applicant,
- 2. Particulars of the interest held in the land or structure, i.e. whether freehold, leasehold, etc.
- 3. The page of a newspaper, circulating in the area in which the land or structure is situate, containing the required statutory notice. The newspaper advertisement should state after the heading Co. Dublin.
 - (a) The address of the structure or the location of the land.
 - The nature and extent of the development proposed. If retention of development is involved, the notice should be worded accordingly. Any demolition of habitable accommodation should be indicated.
 - The name of the applicant,
 - NB. Applications must be received within 2 weeks from date of publication of the notice.
- Four (4) sets of drawings to a stated scale must be submitted. Each set to include a layout or block plan, proposed and existing services to be shown on this drawing, location map, and drawings of relevant floor plans, elevations, sections, details of type and location of septic tank (if applicable) and such other particulars as are necessary to identify the land and to describe the works or structure to which the application relates (new work to be coloured or otherwise distinguished from any retained structures). Buildings, roads, boundaries and other features bounding the structure or other land to which the application relates shall be shown on site plans or layout plans. The location map should be of scale not less than 1: 2500 and should indicate the north point. The site of the proposed development must be outlined in red. Plans and drawings should indicate the name and address of the person by whom they were prepared. Any adjoining lands in which the applicant has an interest must be outlined in blue.
- in the case of a proposed change of use of any structure or land, requirements in addition to 1, 2, & 3 are: (a) a statement of the existing use and the proposed use, or, where appropriate, the former use and the use proposed.
 - (b) (i) Four (4) sets of the drawings to a stated scale must be submitted. Each set to consist of a plan or location map (marked or coloured in red so as to identify the structure or land to which the application relates) to a scale of not less than 1:2500 and to indicate the North point. Any adjoining lands in which the application has an interest must be outlined in blue.
 - (ii) A layout and a survey plan of each floor of any structure to which the application relates.
 - (c) Plans and drawings should indicate the name and address of the person by whom they were prepared.
- Applications should be addressed to: Dublin County Council, Planning Department, Irish Life Centre, Lr. Abbey Street, Dublin 1, Tel. 724755.

SEPTIC TANK DRAINAGE: Where drainage by means of a septic tank is proposed, before a planning application is considered, the applicant may be required to arrange for a trial hole to be inspected and declared suitable for the satisfactory percolation of septic tank effluent. The trial hole to be dug seven feet deep at or about the site of the septic tank. Septic tanks are to be in accordance with I.I.R.S. S.R. 6:75.

INDUSTRIAL DEVELOPMENT:

The proposed use of an industrial premises should, where possible, be stated together with the estimated number of employees, (male and female). Details of trade effluents, if any, should be submitted.

Applicants to comply in full with the requirements of the Local Government (Water Pollution) Act,1977 in particular the licencing provisions of Sections 4 and 16.

PLANNING APPLICATIONS **BUILDING BYE-LAW APPLICATIONS** CLASS CLASS NO. DESCRIPTION DESCRIPTION NO. 1. Provision of dwelling - House/Flat. £32.00 each Dwelling (House/Flat) £55.00 each 2 Domestic extensions/other improvements. £16.00 Domestic Extension 3. Provision of agricultural buildings (See Regs.) £40.00 minimum (improvement/alteration) £30.00 each 4. Other buildings (i.e. offices, commercial, etc.) £1.75 per sq. metre С Building - Office/ £3.50 per m2 (Min. £40.00) Commercial Purposes (min. £70.00) 5. Use of land (Mining, deposit or waste) £25.00 per 0.1 ha £1.00 per m2 D Agricultural (Min £250.00) **Buildings/Structures** in excess of 6. Use of land (Camping, parking, storage) £25.00 per 0.1 ha 300 sq. metres (Min. £40.00) (min. - £70.00) 7. Provision of plant/machinery/tank or £25.00 per 0.1 ha (Max. - £300.00) other structure for storage purposes. (Min. £100.00) Ε Petrol Filling Station £200.00 8. Petrol Filling Station. £100.00 Development or £9.00 per 0.1 ha 9. Advertising Structures. £10.00 per m² Proposals not coming (£70.00 min.) (min £40.00) within any of the £25.00 per 1,000m (Min. £40.00) 10. Electricity transmission lines. foregoing classes. Min. Fee £30.00 11. Any other development. £5.00 per 0.1 ha Max. Fee £20,000 (Min. £40.00)

Cheques etc. should be made payable to: Dublin County Council.

Gross Floor space is to be taken as the total floor space on each floor measured from the inside of the external walls. For full details of Fees and Exemptions see Local Government (Planning and Development) (Fees) Regulations 1984.

			RECEIPT CODI	E .j
COMHAIRLE	CHONTAE ÁTHA	CLIATH		
	BLIN COUNTY COUNCIL 46/49 UPPER O'CONNEL	L STREET, BYE LAW A	PPLICATION	
CASH CHEQUE	DUBLIN 1.	REC. No. N	57394	
M.O. B.L.		egg de strategia de la companya de		
ů.⊤. ===	£ 540.20)		2.00
Received this	17L	day of Ko E	Wary 1992	
from Ryan	OBvier Hond	, Asocs,		
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- bue law	application	at White Chieve	L Rd	
	mana an	s c	COUL	F ag man
Moelle_	DONAL Car	shier <i>Principa</i>	Officer 3	



Ryan O'Brien Handy Associates

6 Percy Place Dublin 4

Telephone 680 899 Facsimile 680 089


DRAFT BUILDING REGULATIONS


It is the practise of this office to take account of the Draft Building Regulations as issued by the Minister for the Environment in the design of buildings but this is not to be interpreted as a guarantee that the provision of the Draft Building Regulations have been implemented in full or in any particular respect in this proposal.

RYAN O'BRIEN HANDY ASSOCIATES
Architects & Designers,
6 Percy Place,
Dublin 4.


111 Wellington Street Luton LU1 5AF

Pariners
Denis Handy
DIP ARCH MRIAI MSDI
John McCarthy
DIP ARCH MRIAI MSDI
Associates
Denis Whelon
RIAI (TECH)
Kenneth McEwan
BSC (HONS)
Noel Doyle

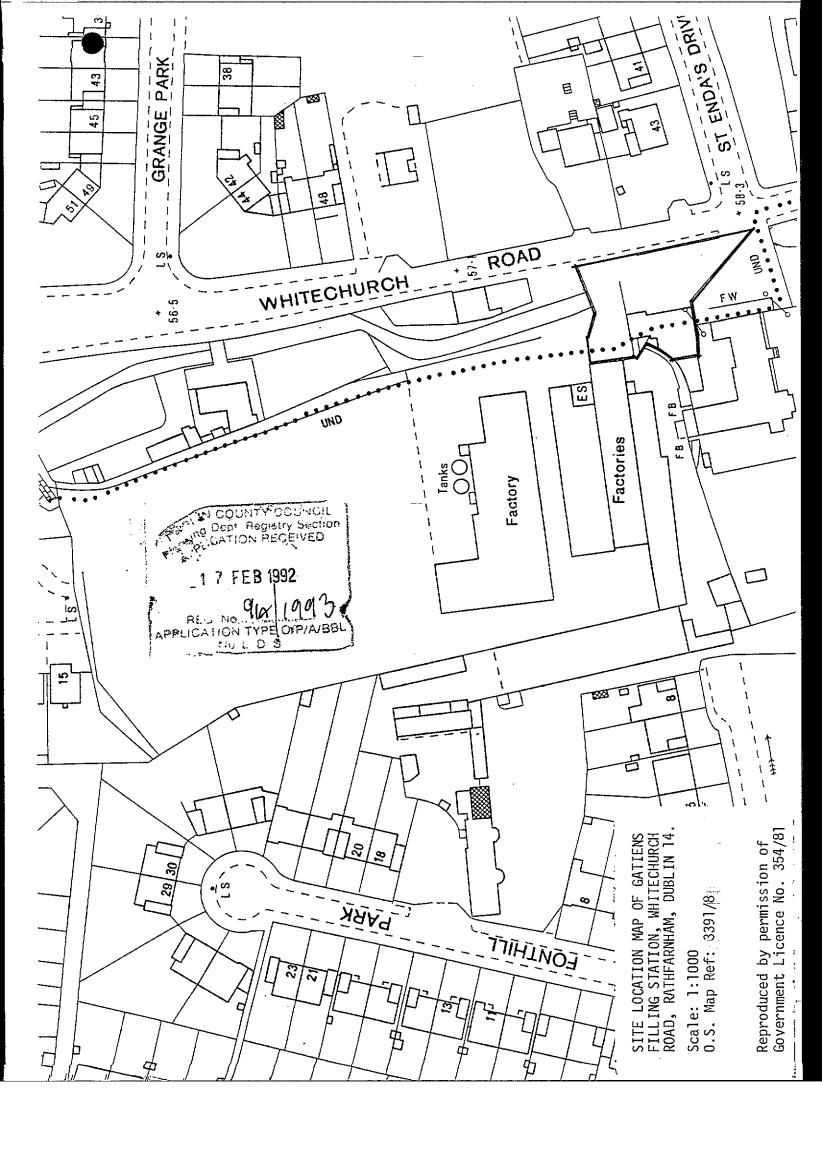


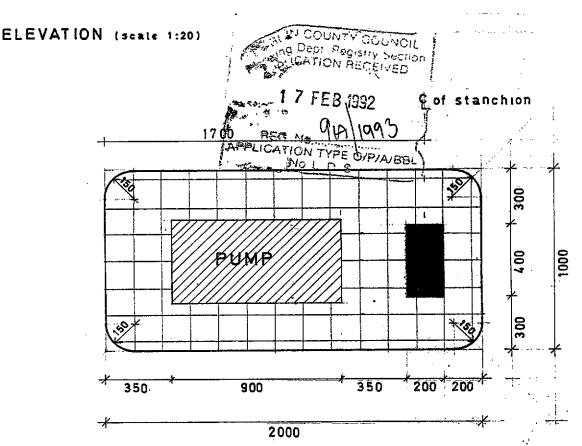

SINGLE PUMP ISLAND (scale 1:20)

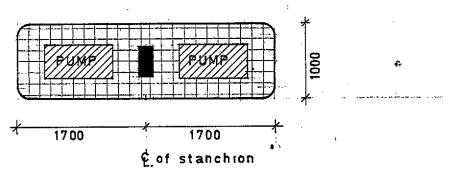

DOUBLE PUMP ISLAND (scale 1:50)

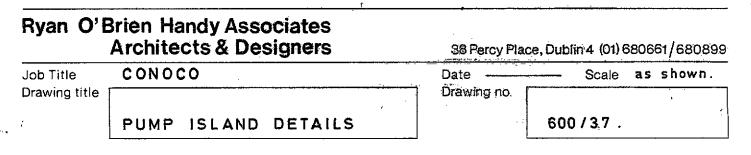

ENSTALLATION INSTRUCTIONS FOR INTERCEPTOR TANK.

The interceptor must be handled with care and not subjected to impact or contact with sharp projections. Inspect for damage before installation.

- 1. Mark out the excavation area, leaving a minimum clearance of 250 mm to all sides.
- 2. Excavate a hole to a minimum depth of 1133 mm below the level of the outlet invert.
- 3. Pour concrete (Grade 20) base to a depth of 150 mm, minimum, ensuring that the surface is smooth and level, at 983 mm below the outlet invert. Allow the concrete to set before proceeding further.
- 4. Carefully lower the Interceptor onto the base and level to correct inverts. Align inlet and outlet with drain runs, checking inlet is at the correct end.
- 5. Remove discs from the air vent spigots and half fill each tank with clean water* to ensure that there is no movement when the concrete surround is poured. The Interceptor must remain at all times square and level.
- 6. Pour the concrete (Grade 12) to underside of inlet and outlet spigots, allowing sufficient clearance for pipe connection. Connect all pipework and seal.
- 7. Continue to pour the concrete to a depth of 230 mm above the shoulder of main tanks and allow time for initial set.
- 8. Remove the protective covers from upstands at pre-cut marks with a fine saw and trim excess material down to the top of the concrete.
- Replace interceptor protective covers onto the upstands. Build up manhole chambers to the required level. Manholes formed with solid concrete blocks (to I.S.20) bedded in gauged mortar and rendered both sides with 2 no. coats of sand/cement plaster, finished smooth.
- 10. Top up interceptor with clean water to correct level.
- 11. Position heavy duty manhole covers (to B.S.497: 1976) square and level. Bed frame in cement sand ready for laying finished surface.


IMPORTANT

*Interceptor only to be filled with clean water when in position.

UPSIA
the cu
unit or
sucker
during
to sie
thed

inict invert

INLET, 100 dic solvent socket

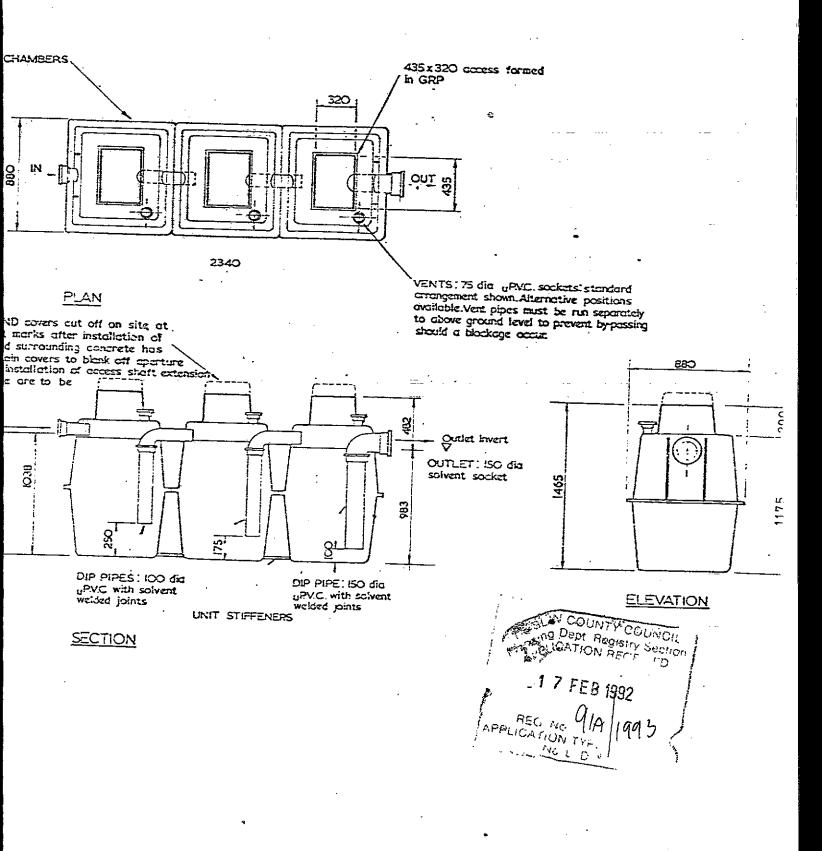

Ryan O'Brien Handy Associates **Architects & Designers**

38 Percy Place, Dublin 4 (01) 680661 / 68089.

Job Title Drawing title' Petrol Interceptor.

Date May 1989

Scale

Drawing no.

600/6.



BERNARD FINNEGAN LTD.

CONSULTING ENGINEERS

SUNBEAM INDUSTRIAL ESTATE, MALLOW ROAD, CORK. IRELAND.

Telephone 353-21-301077 Fax. No. 353-21-301090__

CALCULATIONS

FOR

CANOPY

FOR

PEG No 910 1993

APPLICATION TYPE OF PARTICIPATION TYPE OF PARTICI

WHITECHURCH FILLING STATION,

RATHFARNHAM,

DUBLIN 16.

S.F.L. Engineering Ltd., Callan, Co.Kilkenny, Ireland.

5 January 1991.

NOTES ON CALCULATIONS.

1.0 LOADING

- 1.1 LIVE LOAD complies with B.S. 6399: Part 3: 1988, Loading for Buildings: Code of practice for imposed roof loads.
- 1.2 WIND LOAD is calculated in accordance with B.S. Code of Practice CP. 3, Chapter V, Part 2, 1972, and B.R.E. Digest No. 284, Wind Loads on Canopy Roofs. Ground Roughness Category 3 has been assumed.

2.0 STEELWORK

- 2.1 STEEL BEAMS and COLUMNS are designed in accordance with B.S. 449, Part 2, 1969, and B.S. 5950, Part 5, 1987.
- 2.2 STEEL GRADE is Grade 43 A.
- 2.3 LIVE LOAD DEFLECTION of beams is limited to span/360.
 LIVE LOAD DEFLECTION of cantilevers is limited to span/180.
 LIVE LOAD DEFLECTION of edge of TWO POST CANOPIES is limited to Total Width/240.
- 2.4 DEAD LOAD DEFLECTION to be countered by cambering and / or shimming.
- 2.5 TORSIONAL RESTRAINT to be provided to beams at all connections.
- 2.6 FLANGES OF FASCIA BEAMS to be adequetely restrained against twisting and buckling.
- 2.7 JOINTS to be detailed to adequetely transfer all forces which occur.

. . .

.

3.0 FOUNDATIONS

- 3.1 FOUNDATIONS are designed to B.S.8110, The Structural Use of Concrete, 1985.
- 3.2 CONCRETE grade is C 30.
- 3.3 REINFORCEMENT has Characteristic Strength of 460 N/m.m.^2
- 3.4 COVER to reinforcement is 50 m.m.
- 3.5 ALLOWABLE SOIL BEARING PRESSURE under foundations has been assumed as 100 KN/M^2.

 This should be reliably confirmed before foundations are built.

CANOPY MATERIALS SPECIFICATION

1. ROOF SHEETING.

32 x 0.5 m.m. "Alugalv", single skin steel sheeting as manufactured by TEGRAL METAL FORMING LTD.,

Athy, Co.Kildare, Ireland.

Tel. 353-507-31610.

Max span (single span) = 2300 m.m. Max span (double span) = 2600 m.m. Live load taken as 0.60 Kn/m.sq. Deflection limited to span/200

2. CEILING SHEETING.

19.1 x 0.5 m.m. "Rigidal", single skin aluminium sheeting as manufactured by BRITISH ALCAN BUILDING PRODUCTS LTD.,
Blackpole Trading Estate,
Worcester WR3 8TJ
Tel. 0905-754030.

3. FASCIA

1.5 m.m. thick non structural "Zintec" steel fascia, with matt white stoved enamel finish.


4. GUTTERS

250 wide x 100 deep, made from 1.5 m.m. thick galvanised steel, with bolted joints sealed with silicone sealant.

5. ROOF AND CEILING PURLINS

"MULTIBEAM" sections as manufactured by KINGSPAN LTD.,
Kingscourt,
Co.Cavan,
Ireland.
Tel. 353-42-67172.

MULTIBEAMS are cold formed from hot dipped galvanised steel coil to B.S. 2989: 1982. Grade of steel is Z 28, with a minimum yield stress of 280 N/m.m.sq. Average zinc coating thickness is 0.02 m.m. to each side.

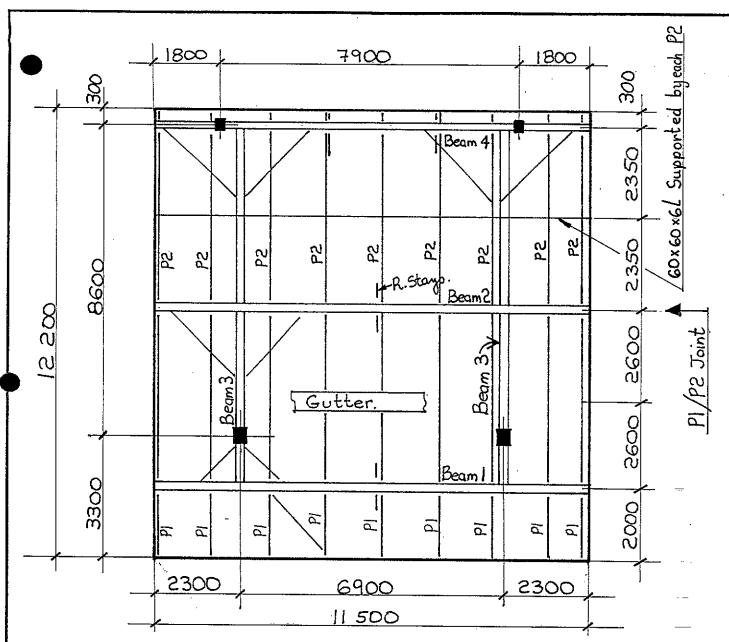

4

SECTION SIZES.

Ht.to underside... 4200

Purlin pl...... 55062 Multibeam at 1500 c/c.

Purlin p2...... 55062 Multibeam at 1500 c/c.

Beam 1...... 203 x 133 x 25 (Stiffs at conns, rafter stays)

Beam 2..... 203 x 133 x 25 (Stiffs at conns, rafter stays)

Beam 3..... 305 x 165 x 40 (Stiffs at conns and at col)

Beam 4..... 203 x 133 x 25 (Stiffs at conns, rafter stays).


Main Column..... 400 x 200 x 10

Rere column..... 400 x 200 x 6.3. Rear Found: 1800 x 1800 x 600 Central.

Baseplate..... 600 x 400 x 20, 12 x 150 stiffs, 6/24 dia.bolts.

Main Foundation... 3000 x 1800 x 600.

BERNARD FINNEGAN LTD.	CLIENT	DRAWN BY B.F.
CONSULTING ENGINEERS	S.F.L. Engineering Ltd.	SCALE ! OO
SUNBEAM INDUSTRIAL ESTATE MALLOW ROAD, CORK, IRELAND	Whitechurch F.S. Rathfarnam.	DATE 31-1-92
TEL 353-21-301077 FAX. 353-21-301090	DRG. TITLE Roof Plan	DRG.NO. 284-1

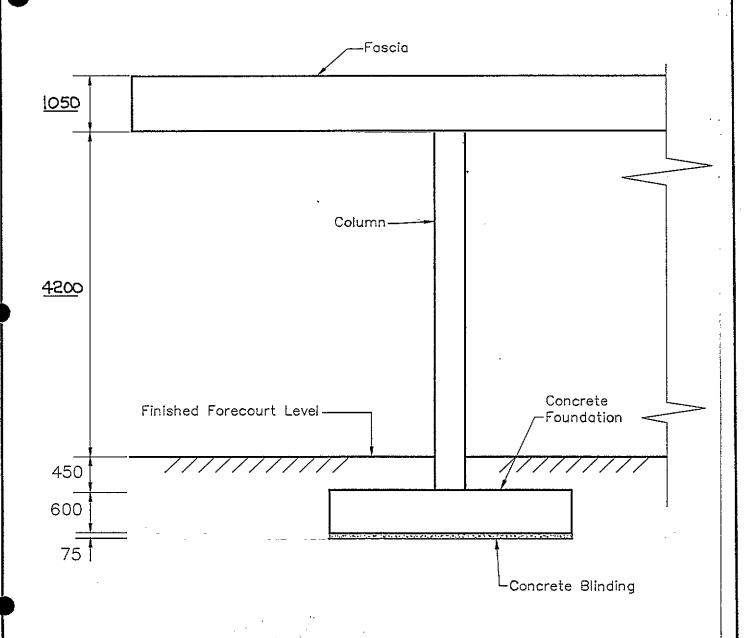

SECTION THROUGH CANOPY AND BASE

CONSULTING ENGINEERS	BERNARD	FINN	NEGAN	LTD.	
	CONSULTING ENGINEERS				

SUNBEAM INDUSTRIAL ESTATE MALLOW ROAD, CORK, IRELAND TEL. 353-21-301077 FAX. 353-21-301090

CLIENT	
S.F.L. Engineer	<u>ing Ltd.</u>
PROJECT,	
Whitechurch F.S. F	<u> Pathfarnham</u>

DRG. TITLE


Typical Section


B.F DRAWN BY

SCALE 1:50

DATE 5-2-92

DRG.NO. 284-2

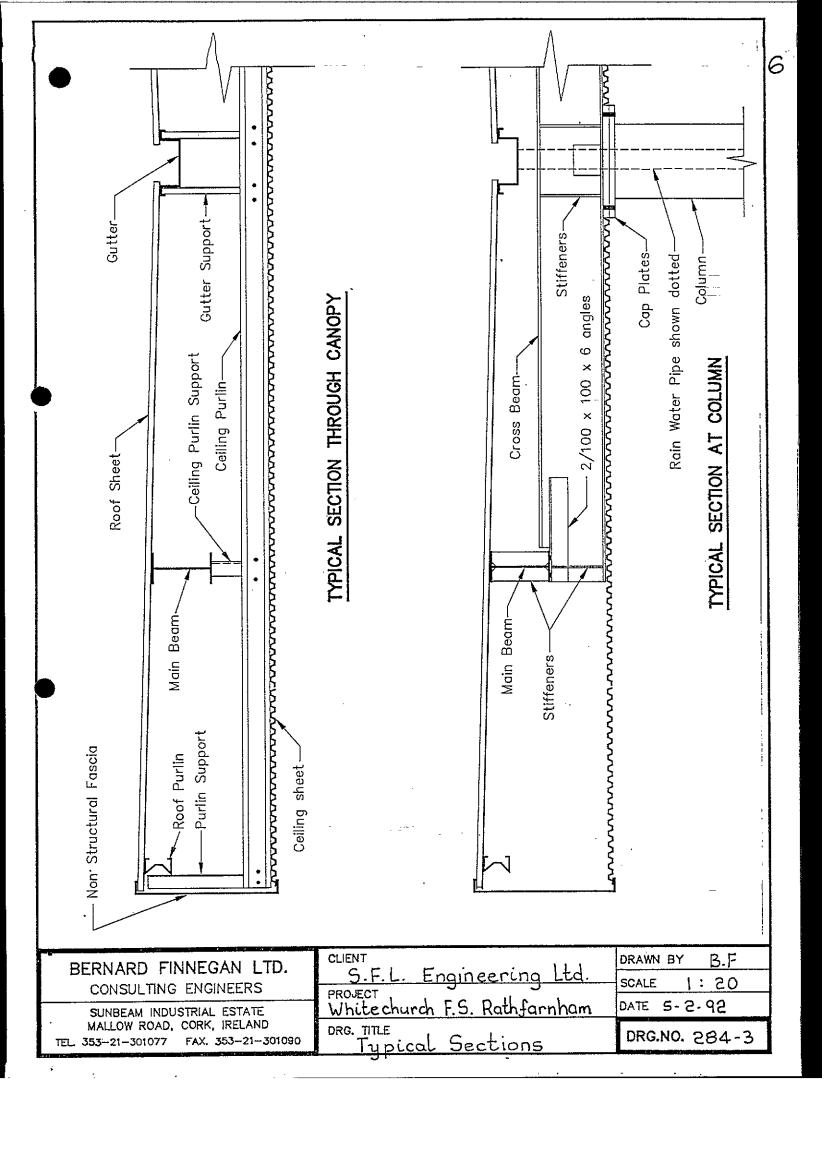

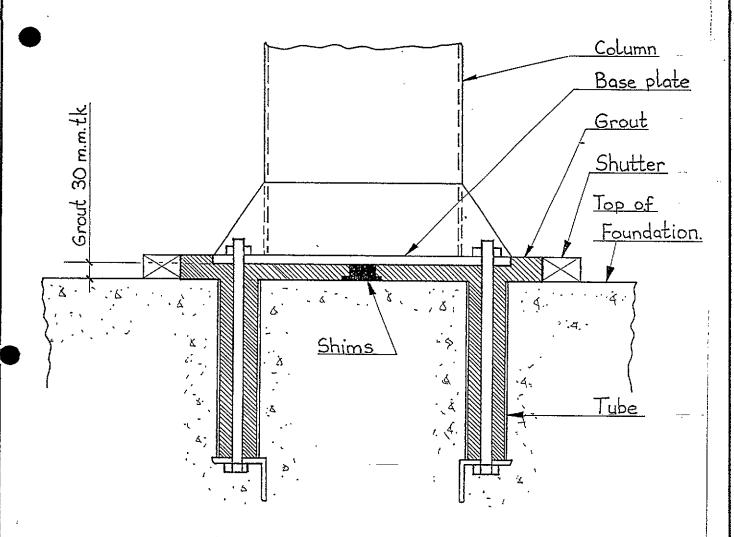


BUILDER'S WORK DURING CANOPY ERECTION.

- 1. All water and dirt to be removed from holding down bolt tubes before columns are erected.
- Column base plates are to be grouted by the Builder after columns are squared and plumbed.
- 3. Grout is to be a proprietary "non-shrink" cementicious grout, mixed and placed in accordance with manufacturers instructions.
- 4. A timber shutter is to be constructed to top of baseplate level as shown, before grouting commences.
- .5. Grout is to be fully worked into holding down bolt tubes and total area under baseplate.

BERNARD FINNEGAN LTD. CONSULTING ENGINEERS	S.F.L. Engineering Ltd.	DRAWN BY B.F.
SUNBEAM INDUSTRIAL ESTATE		DATE 5-2-92
MALLOW ROAD, CORK, IRELAND TEL 353-21-301077 FAX. 353-21-301090	DRG. TITLE Grouting Details.	DRG.NO. 284-4

5-2-92.

```
LOADING.
1. Superimposed Loading : 0.60 Kn/m<sup>2</sup>, BS 6399 : Part 3
                     :
2. Dead Loading
                           0.15 Kn/m^2, Deck, Purlins, Soffit.
                           Weight ----> 0.19 kn. / m.
3. Fascia
          1050 deep :
4. Wind Loads.
    Basic Wind Speed
                             44 m./sec.
                Sl
                            0.65 (Ground Roughness 3, Class B)
                S2
                S3
                            1.00
                ۷s
                            28.6 m./sec.
                            0.50 \text{ kn./m}^2
   Fascia Horz. Load
                           1.00 kn./m
0.15 kn./m<sup>2</sup>
-0.65 kn./m<sup>2</sup>
-0.25 kn./m<sup>2</sup>
                                         (Cp
(Cp
                                                     1.9 )
   Wind Pressure
                                                     0.3)
                      =
                                                     -1.3 )blocked
   Wind Suction
                                         (Cp
                                                    -0.5 )unblock.
   Wind Suction
                                        (Cp
SNOW LOADING to BS 6399 Part 3 1988.
Area Snow Load, Sb =
                            0.5 \text{ kn./m}^2
                            150 m. above mean sea level.
    Altitude
                      =
    Site Snow Load, So
                           0.57 \text{ kn./m}^2
                     =
             H1
                      =
                            200 m.m.
             H2
                       =
                            120 m.m.
           (h1+h2)/So
                           0.56
                       =
                           0.8
                          0.46 kn./m<sup>2</sup>
   Roof Snow Load, Sd =
   Minimum Snow Load
                           0.60 \text{ kn./m}^2
   Design Snow Load =
                            0.60 \text{ km./m}^2
```

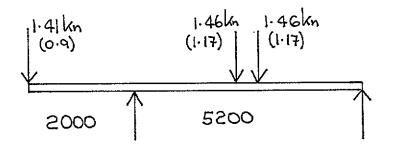

WHITECHURCH FILLING STATION, PURLIN 1

ESTIMATION OF LOADING FOR PURLIN

STRENGTH DESIGN (Dead Load + Live Load)

Point Load 1 = 1.50 x 1.00 x 0.75 + 1.50 x 0.19 = 1.41 Kn.

Point Load 2 = $1.50 \times 1.30 \times 0.75$ 1.46 Kn.

Point Load 3 = 1.50 x 0.00 x 0.90 + 1.50 x 0.00 0.00 Kn.

DEFLECTION DESIGN (Live Load only)

Point Load $1 = 1.50 \times 1.00 \times 0.60$ = 0.90 Km.

Point Load 2 = 1.50 x 1.30 x 0.60 = 1.17 Km.

Point Load 3 = 1.50 x 0.00 x 0.60 = 0.00 Km

```
CANTILEVER----SPAN----CANTILEVER.
BEAM DESIGN.
Span 1 = 2.00 m.
Span 2 = 5.20 m.
                       (COLD ROLLED SECTIONS )
Span.... 0.000 m.
Fascia... 1050 m.m.
Span 3 =
          0.00 m.
Pt.Load 1
             =
                   1.41 Kn. (LL+DL)
                                              0.90 Kn.
                                                        (LL.)
                                              1.17 Kn.
Pt.Load 2
             =
                   1.46 Kn. (LL+DL)
                                                        (LL.)
             =
Pt.Load 3
                    1.46 Kn.
                                             1.17 Kn.
                             (LL+DL)
                                                        (LL.)
                   0.00 Kn. (LL+DL)
Pt.Load 4
             =
                                             0.00 Kn.
                                                        (LL.)
                 TRY 55062 MULTIBEAM.
        Ixx = 156.99 \text{ cm}^4.
Zxx = 22.32 \text{ cm}^3.
              = 22.32 cm<sup>3</sup>.
= 5.10 cm<sup>2</sup>.
        A
               = 140.00 m.m.
        D
                  2.23 cm.
        Ry
        t
                    1.58 m.m.
                  73.00 m.m.
DEFLECTION DESIGN.
.=-- -

      Span 1
      Span 2
      Span 3

      d1 =
      7.28 d1 =
      20.79 d1 =
      0.00


      d2 =
      2.93 d2 =
      -9.45 d2 =
      0.00

      d3 =
      -8.00 d3 =
      0.00 d3 =
      0.00

_______
           2.22 11.34
11.11 26.00
                                            0.00 Total Deflections
           11.11
                                            0.00 Allow. Deflections
STRENGTH DESIGN
                                                              4.99
M1 = 4.31 Kn.m. Mh
                                                            - Mo
M1 = 4.31 \text{ Kn.m.} Mb = 5.69 \text{ kn.m.}

M2 = 5.66 \text{ Kn.m.} 4.16 \text{ Mb} = 5.51 \text{ kn.m.}
                                            5.51 kn.m.
                                                              7.35
м3
      = 0.00 \text{ KN.m.}
                             Mb
                                       =
                                             ERR kn.m.
REACTIONS.
                              - -
=======
   Ra = 3.41 Kn.
Ra = 2.42 Kn.
                             Rb = 0.92 Kn. DL+LL.
Rb = 0.82 Kn. LL.
  Ra = -
```

WHITECHURCH FILLING STATION, PURLIN 1 31-1-92.

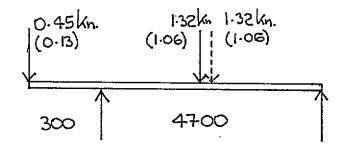

WHITECHURCH FILLING STATION, PURLIN 2

3

ESTIMATION OF LOADING FOR PURLIN

STRENGTH DESIGN (Dead Load + Live Load)

Point Load 1 = $1.50 \times 0.15 \times 0.75 +$ 1.50 x 0.19 = 0.45 Km.

Point Load 2 = 1.50 x 1.18 x = 0.75= 1.32 Km.

Point Load 3 = 1.50 x 0.00 x 0.90 + 1.50×0.00 = 0.00 Km.

DEFLECTION DESIGN (Live Load only)


Point Load 1 = $1.50 \times 0.15 \times 0.60$ = 0.13 Kn.

Point Load 2 = $1.50 \times 1.18 \times 0.60$ 1.06 Kn.

Point Load 3 = $1.50 \times 0.00 \times 0.60$ = 0.00 Km.

```
WHITECHURCH FILLING STATION, PURLIN 2 31-1-92.
                     CANTILEVER----SPAN----CANTILEVER.
BEAM DESIGN.
BEAM DESIGN.
                   (COLD ROLLED SECTIONS)
Span.... 0.000 m.
Fascia... 1050 m.m.
Span 1 = 0.30 \text{ m}.
Span 2 =
         4.70 m.
         0.00 m.
Span 3 =
                                        0.13 Kn.
1.06 Kn.
1.06 Kn.
                                                  (LL.)
               __ 0.45 Kn. (LL+DL)
Pt.Load 1
           =
           = 1.32 Kn. (LL+DL)
                                                  (LL.)
Pt.Load 2
                 1.32 Kn. (LL+DL)
0.00 Kn. (LL+DL)
                                                  (LL.)
Pt.Load 3
           =
                                        0.00 Kn.
                                                  (LL.)
Pt.Load 4
           =
               TRY 55062 MULTIBEAM.
            = 156.99 cm<sup>4</sup>.
       Ixx
            = 22.32 cm<sup>3</sup>.
= 5.10 cm<sup>2</sup>.
       \mathbf{Z} \mathbf{x} \mathbf{x}
       A
             = 140.00 m.m.
       D
                _2.23 cm.
       Ry
t
             =
                  1.58 m.m.
       В
                 73.00 m·m·
DEFLECTION DESIGN.
______
          Span 2 Span 3
0.00 d1 = 13.88 d1 =
-1.71 d2 = -0.17 d2 =
-0.89 d3 = 0.00 d3 =
Span 1
                                         0.00
d1 =
d2 = d3 =
                                         0.00
                                         0.00
13.70 0.00 Total Deflections
23.50 0.00 Allow. Deflections
          -2.60
                                        0.00 Allow. Deflections
          1.67
4.99
STRENGTH DESIGN
                                                       Mo
7.35
                         Mb
7.03 kn.m.
M1 = 0.20 \text{ Kn.m.}

M2 = 4.59 \text{ Kn.m.}
                                   =
                                        5.48 kn.m.
                                                        7.35
                         4.40 Mb
                                                        7.35
                                         ERR kn.m.
           0.00 KN.m.
                          -_{\sf Mb}
м3
REACTIONS.
=======
   Ra = 1.80 Kn. Rb = Ra = 1.20 Kn. Rb =
                                 1.29 Kn. DL+LL.
1.05 Kn. LL.
  Ra =
```

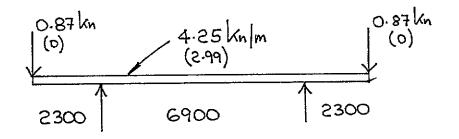

WHITECHURCH FILLING STATION, BEAM 1 31-1 ESTIMATION OF LOADS ON BEAM 1 _____ STRENGTH DESIGN (Dead Load + Live Load) + -= 4.60 x 0.19 Point Load 1 0.00×0.20 0.00×0.00 x 0.75 0.87 Kn. 4.60 x 0.19 ÷ Point Load 2 0.00×0.20 $0.00 \times 0.90 \times 0.75$ 0.87 Kn. 3.41 / 1.50 + U.D. LOAD $(1.00 + 1.30) \times 0.75 +$ 0.25 4.25 Kn./m. DEFLECTION DESIGN (Live Load only) $0.00 \times 0.00 \times 0.60$ Point Load 1 0.00 Kn. $0.00 \times 0.00 \times 0.60$ Point Load 2 = 0.00 Kn. 2.42 / 1.50 ÷ (1.00 + 1.30)x 0.60

2.99 Kn./m.

U.D. LOAD

Beam 1

BEAM DE				CANTILEVER-				· ≐`
Span 1 Span 2 Span 3	=	2.30 6.90 2.30	m •			-		
Pt.Load U.D.Loa Pt.Load	d	= = =	4.25	Kn. (LL+DL) Kn/m. (LL+DL) Kn. (LL+DL))	2.99	Kn. (LL. Kn./m.(LL. Kn. (LL.	.)
Ixx Zxx Ry D/t	:	= = =	133 x 25 2356.00 231.90 3.10 26.00	cm^4 .				- - -
		DESIGN.				• •		
====== Span 1		======	: Span		Span 3			
d1 =	:	0.00	d1 =	17.86				
d2 =	=	2.12	d2 =	-4.88	d2 =	0.00 2.12 $-4.\overline{23}$		
d3 =		-4.23	d3 =	-4.88	d3 = d4 =	-4.23 -2.12		-
d4 =								
======	=====		=======	=======================================	=======	=======		======= lostions
		-4.23 12.78		8.10 19.17			Total Defi	
======	====	12.70	=======	======================================	=== = ==			
000000000		OTON						
STRENGT				Stres	s at ho	oles.	Width	
м1	=			_	85.36		133.00	-
M2	=	25.28			162.92			÷
	=	13.25			85.36			
Moment		22.00			141.77			
Stress			$N/m.m.^2$		-			_
D/t		26.00		•				-
		140.00 4.34	m	Maximum Eff	ective	Length	> 3.5 m.	
Le	====	4.34 :======	========	PIAXIMUM ELL	:==== = :	=======	========	=======
REACTION								
====== Ra	=== · =	25.30	Kn.	Rb =	25.30	Kn. (LL+	⊦DĽ)	 ·
Ra :	=	17.21	Kn.	Rb =	17.21	Kn. (LL)		
======	====	======	=,=,='=====	:==== <u>======</u>	=====	=======	=======================================	

0.95kn (0) 3.58kn/m (2.73) 0.95kn

```
WHITECHURCH FILLING STATION, BEAM 2
                                                   31-1
  ESTIMATION OF LOADS ON BEAM 2
STRENGTH DESIGN (Dead Load + Live Load)
                    5.00 x 0.19 + 0.00 x 0.20 + 0.00 x 0.00 x 0.75
Point Load 1 =
                    0.95 Kn.
                    5.00 x 0.19 + 0.00 x 0.20 + 0.00 x 0.90 x 0.75
Point Load 2 =
                    0.95 Kn.
                   2.21 / 1.50 + ____
(1.18 + 1.30 )x 0.75 +
U.D. LOAD
                    0.25
                    3.58 Kn./m.
DEFLECTION DESIGN (Live Load only)
                  0.00 \times 0.00 \times 0.60
Point Load 1 =
                     0.00 Kn.
                   0.00 \times 0.00 \times 0.60
Point Load 2 =
                     0.00 Kn.
                   1.87 / 1.50 +
U.D. LOAD
                    (1.18 + 1.30) \times 0.60
                    2.73 Kn./m.
```

```
WHITECHURCH FILLING STATION, BEAM 2
                   CANTILEVER----SPAN----CANTILEVER.
BEAM DESIGN.
                   _____
        2.30 m.
6.90 m.
Span 2 =
         2.30 m.
Span 3 =
                                   0.00 Kn. (LL.)
2.73 Kn./m.(LL.)
0.00 Kn. (LL.)
Pt.Load 1 = 0.95 Kn. (LL+DL)
U.D.Load = 3.58 Kn/m.(LL+DL)
Pt.Load 2 = 0.95 Kn. (LL+DL)
      TRY 203 x 133 x 25
   Ixx = 2356.00 \text{ cm}^4.
               231.90 cm<sup>3</sup>.
   Zxx
                3.10
                      cm.
        =
   Ry
D/t
                26.00
DEFLECTION DESIGN.
               Span 2
d1 = 16.31
Span 3
Span 1
                      16.31 d1 = -4.45 d2 = -4.45 d3 =
                                     0.00
         0.00
d1
        1.93
                                      1.93
               d2 =
d2
                                     -3.87
     =
        -3.87
               d3 =
d3
                                     -1.93
                              d4 =
d4
         -1.93
-3.87 7.40 -3.87 Total Deflections 12.78 Allow. Deflections
                                    12.78 Allow. Deflections
STRENGTH DESIGN.
Width
M1 = 11.66 Kn.m.

M2 = 21.33 Kn.m.

M3 = 11.66 KN.m.

Moment = 19.00 Kn.m.

Stress = 81.93 N/m.m.^2

D/t = 26.00
                             75.16
                             137.42
                              75.16
                             122.44
L/ry = 180.00
Le = 5.58 m. Maximum Effective Length > 3.5 m.
 REACTIONS.
Ra = 21.55 Kn. Rb = 21.55 Kn. (LL+DL)
Ra = 15.72 Kn. Rb = 15.72 Kn. (LL)
```


31-1-92.

BERNARD FINNEGAN LTD	. Consulting	Engineers.	021-822	2336
JOB: Whitechurch Filling				
	, Gran		2	Electric de la constant de la consta
Beam 3				
Strength Design.	25.3 kn.	<u>.51</u> .	6kn.	
D.L + L.L.	(17.21)	(5·72)	
Pt 1 = 25.3 Kn.	<u>V</u>			
Pt2=-21.6 kn.		3.9	····	$ \uparrow$ $ \downarrow$
O= 165 x 301/561	1300	860	0	
= 89 N/mm	1 - 0			.
D/T = 30 , l/ry =	150 , lemosc =	= 150 x 38.5 =		
 Deflection Design. 			> 4700 m	im.
L.L. only.		<u> </u>	377.	3 a
Pt 1 = 17.21km	Trend = 4	100 cm4	····	
Pt2 = 15.72km.	I prov =	8523 cm ⁴		
Ra = 13.5+ 25.3 x 86 = 2	42.6km.	30	5 x 165 x 40)
Ra' = 8.6 + 17.21 x do. =				
Rb = 11.49 - 25.3 x 8.6 =	= 7.66 km.			
Rb' = 7-13-17-21 x 1.3/	8.6 = 4.52 kn.			
		· ····································	, <u>i</u>	<u> </u>
Column Design				
Main column				
· · · · · · · · · · · · · · · · · · ·	Super + Wind		<u> </u>	·
	= 42.6 km.		····	<u> </u>
	$= 1.0 \times 5.75$			
	= 1.0_x\$7.5	5 x 5.175	$\frac{12}{2} = 19.4$	· lin.m.
Case 2: Dead	· 	. 000 5		.
Looa	= 42.6 - 28.6 $= 7.6 kg$	4 - 0.25 x 5.	to x 4.6	
Mor	= 30kn.m.	Mn = 2010	100	
1100		- J CONN		
		400 x 200	×(0	ed.
			- i	

```
WHITECHURCH FILLING STATION, BEAM 3 31-1-92.
SPAN (M.)..... 8.600001
  UDL , (KN / M.)....4
  P1 (Kn.)..... 21.55
                    A1 (M.)..... 3.9
  P2 (Kn.)..... 0 A2 (M.)..... 0
  P3 (Kn.).... 0
                A3 (M.)..... 0
  P4 (Kn.).... 0
                a4 (M.)..... 0
  P5 (Kn.)..... 0
                 A5 (M.).... 0
  I (cm<sup>4</sup>.).... 6188.511
                      Z (cm<sup>3</sup>.).... 300.5914
  Ra (Kn.)..... 13.49733 Rb (Kn.)..... 11.49267
```

TO RERUN, ENTER 1; TO RETURN TO PROG. SELECTION, ENTER 21

TO RERUN, ENTER 1; TO RETURN TO PROG. SELECTION, ENTER 2

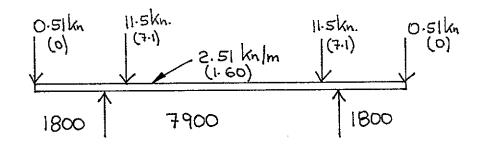

```
WHITECHURCH FILLING STATION BEAM 4
                                            31-1
  ESTIMATION OF LOADS ON BEAM 4
STRENGTH DESIGN (Dead Load + Live Load)
                       x 0.19
                                + ---
Point Load 1
             = ...2.70
                          0.20
                       х
                  0.00
                  0.00
                       Х
                          0.00 \times 0.75
                -0.51 Kn.
                        x 0.19
                 2.70
Point Load 2
                       x 0.20
                  0.00
                  0.00 \times 0.90
                                x . 0.75
                  0.51 Kn.
                  1.80 / 1.50
U.D. LOAD
                       + 1.18 )x 0.75 +
                 (0.15
                  0.31
                  2.51 \text{ Kn./m.}
DEFLECTION DESIGN (Live Load only)
Point Load 1 = __0.00 x 0.00 x 0.60
                  0.00 Kn.
             = 0.00 \times 0.00 \times 0.60
Point Load 2
                  0.00 Kn.
                 1.20 / 1.50 +
U.D. LOAD
                 (0.15 + 1.18) \times 0.60
                 1.60 Kn./m.
```

```
CANTILEVER----SPAN----CANTILEVER.
BEAM DESIGN.
Span 1 =
         1.80 m.
span 2 =
         7.90 m.
Span 3 =
         1.80 m.
               0.51 Kn. (LL+DL)
2.51 Kn/m.(LL+DL)
Pt.Load 1
U.D.Load
Pt.Load 2
                                    0.00 Kn. (LL.)
          =
          = 0.51 Kn. (LL+DL)
= 2.51 Kn/m.(LL+DL)
= 0.51 Kn. (LL+DL)
                                    1.60 Kn./m.(LL.)
                                    0.00 Kn. (LL.)
      TRY 203 x 133 x 25
              2356.00
                     cm^4.
      = -
   Ixx
                     cm^3.
               231.90
   \mathbf{Z}\mathbf{x}\mathbf{x}
   Ry
        =
                3.10
                      cm.
   D/t
                26.00
DEFLECTION DESIGN.
______
                Span 2
                             Span 3
Span 1
         0.00
               d1 = 16.38
                                    0.00
d1 =
                            d1 =
    =
         0.42
              d2 =
                      -2.09
                             d2 =
                                    0.42
d2
         -5.48
              d3 =
                      -2.09
                             d3 =
                                    -5.48
d3
   =
                             d4 =
                                    -2.74
d4
        -2.74
-7.80 12.20 -7.80 Total Deflections
                                    10.00 Allow. Deflections
                      21.94
STRENGTH DESIGN.
                         Stress at holes.
                                          Width
M1 = 4.99 Kn.m.

M2 = 19.56 Kn.m.

M3 = 4.99 KN.m.

Moment = 24.00 Kn.m.
                           32.13
                                          133.00
                            126.06
                             32.13
                             154.66
Stress =
       103.49 N/m.m.^2
D/t =
        26.00
L/ry = 130.00

Le = 4.03 \text{ m.} Maximum Effective Length > 2.7 \text{ m.}
______
REACTIONS.
=======
Ra = 14.93 Kn.
Ra = 9.19 Kn.
                             14.93 Kn. (LL+DL)
                   Rb
                         = - 9.19 Kn. (LL)
                   Rb
```

WHITECHURCH FILLING STATION BEAM 4 31-1-92.

WHITECHURCH FILLIN	G STATION	N, MAIN	COL 5	-2-92.		
COLUMN DESIGN.	:	CASE 1	CASE 2	!	·	-
Max. Load. Moment x-x (a) Moment x-x (b)	= ··· = =	42.60 30.00 0.00 20.00	7.60 30.00	KN.M. KN.M.		_
Moment y-y						•
Height Eff. Length x-x Eff. Length y-y Canopy Width.	= = = =	9.30 9.30	4.65 9.30 9.30 0.00	M. M.		
_		x 200 x 10	R.H.S.	am^2		
A Z x-x Z y-y I x-x	=	·	_1207.00 _814.00 _4140.00	cm ³ cm ³ cm ⁴		_
I y-y ry D/t	=	-	8138.00 8.39			-
Lateral Defl. x-x Allow Defl. x-x Lateral Defl. y-y Allow Defl, y-y	=	4.27 25.83 8.43 25.83	4.27 25.83 8.43 25.83	m · m · m · m · m · m · m · m · m ·	<u></u> .	
Edge Defl. Allow. Edge Defl.	=	0.00	0.00	m • m • m • m •		
STRENGTH DESIGN.						_
Compression. Leff./ry Pc Ax.Str.	=	66.41		N./m.m.^2 N./m.m.^2		==-
Bending. Leff./ry	=	55.42	55.42			
D/t Pcb. Bend.Str	=	0.00 165.00 24.86	0.00 165.00 24.86	N./m.m.^2 N./m.m.^2	-	
COEFFICIENT	= .	0.21	0.16	< 1.0		

BERN	IARD FINNEGAN LTD. Consulting Engineers. 021-822336
JOB:	Whitechurch Filling Station DATE: 5-2-92 PAGE: 22
	Rear Column.
	Case 1: Dead + Super + wind // to shop. Load = 14.93 + 7.66 = 22.6 Kn.
	Maca = 1.0x 5 x 5.175/2 = 12.94 km.m.
	Case 2: Dead + wind // to shop.
8.88	Local = 14.93-9.19 + 7.66-4.52 - 0.25x5x5x5.75
	= 1.7 kn. Max = 13 kn.m My = 0.
	200 x 200 x 6.3
	Rear Found. Cases as for near col, with case 3 added.
	Case 3: Dead + wind I to shop. Load = do - 0.65 x 5 x 5.75 = -10 Kn
	$M_{bc} = 0, M_{y} = 0$
	1800 x1800 x600 Central on col.

```
WHITECHURCH FILLING STATION, REAR COL, 5-2-92.
COLUMN DESIGN.
                               CASE 1 CASE 2
22.60 1.70 KN.
13.00 13.00 KN.M.
0.00 0.00 KN.M.
0.00 0.00 KN.M.
Max. Load. ==
Moment x-x (a) =
Moment x-x (b) =
                  =
                   =
Moment y-y
                                 4.65
                                          4.65 M.
Height
                                          9.30 M.
Eff. Length x-x = Eff. Length y-y =
                                  9.30
                                           9.30 M.
                                  9.30
                                           0.00 M.
                                  0.00
                   =
Canopy Width.
                   try 200 x 200 x 6.3 r.h.s.
                                  _ 48.60 cm^2
                  = .
=
                                     ...303.00 cm<sup>3</sup>
          \mathbf{z}_{\mathbf{x}-\mathbf{x}}
          Z y-y
I x-x
I y-y
                                      =303.00 cm<sup>3</sup>
                                  --- - 3033.00 cm<sup>4</sup>
                  =
                                  3033.00 cm<sup>4</sup>
                   =
                                        7.90 cm.
                    =
          ry
          D/t
                             14.71 14.71 m.m.
25.83 25.83 m.m.
0.00 0.00 m.m.
25.83 25.83 m.m.
Lateral Defl. x-x =
Allow Defl. x-x =
Lateral Defl. y-y =
Allow Defl, y-y =
Edge Defl.
                                 0.00
                                           0.00 m.m.
                              0.00 0.00 m·m.
Allow. Edge Defl. =
STRENGTH DESIGN.
Compression.
                              117.72 117.72
60.25 60.25 N./m.m.^2
4.65 0.35 N./m.m.^2
          Leff./ry =
          Pc =
          Ax.Str. =
Bending.
                             58.86 58.86
0.00 0.00
165.00 165.00
          Leff./ry =
          D/t =
                                          165.00 N./m.m.^2
          Pcb.
                   =
                                42.90 42.90 N./m.m.^2
          Bend.Str.=
                                 COEFFICIENT
```

WHITECHURCH FILL	ING STATION,	MAII	OCL,	Ę	5-2-92.		
BASEPLA	TE DESIGN	RECTANO	GULAR (COLUMN			
DIMENSIONS.		L	ENGTH	WIDTH	THICK		-
	COLUMN: BASEPL: H.D. BOLTS STIFFS		400 600 3 2		20 24 12		
LOADING.		CASE	1 y-y	CA:		···	=
	LOAD : MOMENT :	44.6 30.0	44.6 20.0	9.6 30.0	9.6 20.0	Kn. Kn.m	•
RESULTANT FORCES			ACTU	AL		ALLOW	ABLE
Depth to Neutral Compressive Force Tensile Force Stress in grout BSPL bend. stress Stiff. bending a Actual H.D.Tensing Required H.D.Tensing Stiff. bending a Stiff. bending a Stiff. bending a stiff.	under BSPL. ss at column stress ion at H.D.bolt.	83.6 39.0 2.4 43.2 13.0 18.2	85.2 40.6 2.6 109.6 20.3 28.4 100.1	65.8 56.2 1.9 34.0 18.7 26.2 92.3	$29.4 \\ 41.2$	6.5 206.0 206.0	m.m. Kn. Kn. N./mm2 N./mm2 N./mm2 Kn. Kn. N./mm2

	FOUNDATION I	ESIGN				
		CASE 1	CASE 2	CASE 3		
Max. Load	=	44.60	9.60	0.00	KN.	
Moment X-X	=	34.20	34.20	0.00	KN.M.	
Moment Y-Y	= .	22.80	22.80	0.00	KN.M.	
Base Length	=	3.00	3.00			
Base Width	=	1.80	1.80		M -	
Base Thickness	=	0.60	0.60	0.60	М.	_
Base Area	= . ::	5.40	5.40		M^2.	-
Base Z x-x	=	2.70				-
Base Z y-y	=	1.62	1.62	1.62	M^3.	
STRESSES UNDER E		0.00	1 50		7237 /34 ^ ♠	
Super Load	<u>=</u>	8.26	1.78 7.20			
Soil	<u>=</u> - ·		14.40			
Base	=		12.67			
Wind x-x	= -	14.07	14.07	0.00		
Wind y-y	=	14.07	14.07	0.00	KN./PI 2.	
MAX. STRESSES : Wind x-x	=	42.53	36.04	21.60	KN./M^2	< 100
Wind x-x Wind y-y	=	43.93	37.45	21.60		< 100
MIN. STRESSES :	-	40.95		21.00	MN•/FI Z	
Wind x-x	=	17.19	10.71	21.60	KN./M^2	> 0
Wind y-y	=	15.79	9.30	21.60	KN./M^2	> 0
FACTOR OF SAFETY	<i>7</i> :					
O.T.M. x-x	=	34.20	34.20	0.00	KN.M.	
R.M. x-x =	· =	174.96	174.96	174.96	KN.M.	
F.O.S. x-x	=	5.12	5.12	ERR		> 1.5
O.T.M. y-y	. 		22.80		KN.M.	
R.M. y-y	=	104.98	104.98	104.98	KN.M.	_
F.O.S. y-y	=	4.60	4.60	ERR		> 1.5
FOUNDATION REIN	NFORCEMENT					
			= .4.4 0.0	 lem /== 0.2	· /==++\	.
Presure under i	coungation	= -		kn./m ² . kn./m ² .		
	Moment	· =	79.20		. 52.000,	
	M/bd^2fcu	=	0.009			
	z	=		m.m.		
	Ast			m.m.^2 /	m.	
Minimum r	percentage	<u> </u>			m.m.^2 / m	١.
ActualT16		=			mProvid	
(Or equivaler						


	FOUNDATION	DESIGN	·	- · ·			
		CASE 1	CASE 2	CASE 3			
Max. Load	=	24.60	3 70	-10.00	KN.		
Moment X-X	=	14.82	14.82	0.00	KN.M.		
Moment Y-Y	=	0.00	0.00	0.00	KN.M.		
				0.00	••••		
Base Length Base Width Base Thickness	=	1.80	1.80				
Base Width	=	1.80	1.80	1.80			
Base Thickness	= ···	0.60	0.60	0.60	М.	-	
Base Area	= '	3.24	3.24	3.24	M^2.		
Base Z x-x	=	0.97	0.97	0.97	м^3.		
Base Z y-y	=	0.97					
base z y-y		0.57	0.5,	0.5.	11 01		
STRESSES UNDER		m F.A		2 00	7737 /3400	-	
Super Load	=	7.59	1.14	-3.09			
Soil	=	7.20	7.20	7.20	$KN./M^2$		
Base	=	14.40	14.40	14.40	KN./M^2		
Wind x-x	· =		15.25	0.00	$KN./M^2$		
Wind y-y	=	0.00	0.00	0.00	$KN./M^2$	•	
MAX. STRESSES :							
Wind x-x	=	44.44	37.99	18.51	$KN./M^2$	ż	100
Wind y-y		29.19	22.74	18.51			
MIN. STRESSES :		23.19	224,3	10.77	· MM • / ti =	- `	
	= -	12 05	7.50	18.51	KN./M^2	. >	n
Wind x-x							
Wind y-y	=	29.19	22.74	TO - 2T	RN - / PI Z		U
FACTOR OF SAFET	Y:			_	-		
O.T.M. x-x	=	14.82	14.82	0.00	KN.M.		
R.M. x-x	=	62.99	62.99	62.99	KN.M.		
F.O.S. x-x	. =	4.25	4.25	ERR		>	1.5
0 m W	_	0 00	0 00	0.00	ENT M		
О.Т.М. у-у	=	62.99	62.00	62.99			
R.M. y-y	= _				KIN • FI •		1.5
F.O.S. y-y	=	ERR	ERR	ERR			1.5
FOUNDATION RE	INDOD COMENIE						
ROUNDALION RES		: -·	-			٠.	
Presure under	foundation	<i>,</i> = .	- 45.00	$kn./m^2$.	(nett)		
		= .	72.00	$kn./m^2$.	(gross)		
	Moment	=	29.16		_		
	M/bd^2fcu	= =	0.003			-	
	M/ Du Zicu Z		523	m.m.			
	Ast	-	139	m.m.^2 /	m.		
Minim		· = -	- 13% ·	= 715	m.m.^2 /	m .	
	percentage		1010		mProvi	 707	
ActualT1		=	TOTO	m + m + 4 /	M LIOAT	سحيب	
(Or equivale	ent mesh)					_	

OUTLINE SPECIFICATION

for

THE REDEVELOPMENT

o f

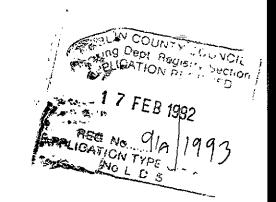

WHITECHURCH PETROL FILLING STATION, WHITECHURCH ROAD DUBLIN.14.

for

CONOCO IRELAND LTD.

under the supervision of

RYAN O'BRIEN HANDY ASSOCIATES

December 1991

- All work is to be carried out strictly in accordance with the Requirements and Regulations of the Local Authority, Building Bye-Laws, Draft Building Regulations and Fire Officer.
- All material to be used to be of Irish manufacture and to I.S.S. where applicable and to be the best of their respective kind.
- All Local Authority charges, i.e. water supply connections, drainage connections, E.S.B. and Bord Telecom Charges should not be included in the tender. All such charges will be paid by the Client or be refunded by the Client to the Contractor should the Contractor pay same so as to avoid unnecessary delays.
- It will be the responsibility of the Contractor to inform the Building Control Department with due notice when the foundation trenches, drains, etc., are ready for inspection.
- The Contractor is to include for making good all surfaces where disturbed to match existing finishes after the completion of all works.
- The Contractor is to include for removing all rubbish from the site and to leave the site in a neat and clean condition after the completion of all works.
- As petrol and diesel oil are stored and dispensed on this site, safety is paramount. It is the responsibility of the Contractor to take all precautions necessary while carrying out the works. No welding, cutting of mesh, etc., is to be carried out in the vicinity of the underground tanks or petrol pumps. Contractor to consult with Architects and pipework specialists regarding the positions of existing pipework, electrical ducts, etc., before any excavation work is carried out. Contractor to include for careful excavation in these areas so as to avoid any damage to the pipelines, etc. Before any work commences, Contractor to agree the safety standards necessary with the Architects and Client.
- Contractor to include for very careful excavation of ground surfaces etc., especially around the tanks and across the forecourt so as to avoid drainage to pipe lines, existing electrical ducts, air and water lines etc. It will be the responsibility of the Contractor to consult with the Client, Specialist Firms, Electrician and Architects regarding approx. positions and depths of these services before commencing this work.
- Two existing single compartment underground petrol storage tanks are to be degassed and then removed from the ground and taken away from the site, in accordance with the Dangerous Substances Act. A specialist firm will carry out the degassing of the tanks and the removal of all existing underground pipework from same. The Fire Officer will be given due notice before this work is carried out.
- 2 no. new underground petrol stroage tanks are to be installed where shown on drawing no: 2898/02 strictly in accordance with detail drawing no. 600/16C and in accordance with the Dangerous Substances Act and the Local Fire Officer's requirements. The fitting out and hydraulic water testing of these tanks, all pipework installation of gauges, self-services equipment, etc., are to be carried out by a specialist firm. The Fire Officer is to be informed when this work is being carried out so that he can inspect all stages of the work.
- 11 Contractor is to include for building all manhole chambers with 225mm solid concrete blocks (approx. size 900 x 750 x 950 mm deep). The walls and floors of these chambers to be rendered with 3 no. coats sand and cement. The rendering is to be finished neatly around all pipework and tank manlid.
- The existing E.S.B. supply to the site is to be brought to the new building in an underground duct where a fuseboard, meteres, isolation switches, etc. will be installed in the store. All wiring on the site to the pumps, canopy, sign, lights, etc. are to be laid in 100mm diameter 'Wavin' ducts, 300mm minimum below ground level with adequate inspection chambers and drawpits. All electrical work is to be carried out strictly in accordance with the most recent E.S.B. Regulations and Requirements.
- 13 Contractor to include for taking a 25mm 'Hydrodare' connection from main supply to the new building.
 Include for 25mm full way stop valves on all connections. Pipes to be 450mm minimum below ground level.
- 14 Contractor to include for new planting areas and boundary walls as indicated on drawing no. 2898.
- The new surface water drains on the site are to be installed in accordance with the layout drawing. Drains generally to be PVC ('Wavin' or similar) to sizes indicated and to be laid in trenches in straight lines to the required depth and falls. All joints are to be made in strict accordance with the manufacturer's instructions. All drains are to be laid on a minimum 150mm concrete (Grade 12) bed and encased in 150mm concrete

- (Grade 12). The trenches are to be back-filled in layers, the material being carefully rammed to consolidate it, care being taken not to damage the pipes and joints. All drains to be water tested for leaks in accordance with CP301.
- Manhole chambers on the surface water drains to be constructed with 225mm hollow concrete blocks rendered with 3 no. coats sand and cement waterproof rendering internally; half round channels formed with easy bends with sand and cement benching to sides. Provide and fit step irons in chambers if necessary. Provide and fit heavy duty cast iron covers and frames bedded in grease.
- All A.J.'s to be PVC (Wavin or similar). Provide 250 x 250mm PVC square rising pieces up to ground level, and finish at top with 275 x 275mm galvanised cast iron covers and frames set in cement mortar and sealed in grease. All A.J.'s to be set on bed of concrete 150mm thick (concrete grade 12).
- 18 Contractor to supply and install PVC gulley traps where shown on drawings.
- The Contractor is to supply and install a prefabricated Conder petrol interceptor trap in accordance with the Manufacturer's instructions, as per detail drawing no. 600/6, on the surface water drain where indicated on the drawings and at the car wash outfall. The Contractor is to supply and install 3 no. 100mm diam. p.v.c. vent pipes to the chambers of the interceptor which are to be joined together underground and 1 no. 100mm diam. p.v.c. pipe to be brought underground to an agreed position on site, up to ground level. A Specialist Firm will supply and fit the upright section above ground. The Contractor is to supply and fit 3 no. heavy duty manhole covers and frames over the 3 no. interceptor chambers.
- The Contractor is to provide and install new 'ACO' drainage channels type C 250 and new 'ACO' silt gulleys where indicated on the drawings.
- New foul drains indicated are to be installed strictly in accordance with the drawings 2898/04, and as described previously for Surface Water Drains.
- Manhole chambers on foul drain to be constructed with 225mm solid concrete blocks rendered inside and outside with 3 no. coats sand and cement waterproof rendering, half round channels formed with easy bends with sand cement benching at 1:12 to sides. Provide and fit step irons to chambers as necessary and provide and fit heavy duty cast iron covers and frames, sealed in grease.
- 23 All A.J.'s to be installed as previously described in Clause No. 18.
- 24 Provide and fit PVC gulley traps where shown.
- 25 Contractor to include for 150mm minimum of well consolidated hardcore under all new ground surfaces.
- The forecourt area under the canopy is to be surfaced with concrete paving setts laid in strict accordance with the manufacturer's instructions and specification.
- The remainder of the forecourt, as indicated, 250mm deep reinforced concrete (grade 20) laid to falls as detailed on drawing no. 2898/04).
- A new canopy is to be erected on site in position indicated on drawing. The canopy, with illuminated fascias on three sides, is to be fabricated, supplied and erected by a specialist firm. The canopy shall be constructed with R.H.S. steel stanchions, steel intermediate members with aluminium top sheeting, soffite sheeting and steel fascias.
- The new shop/store building is to be built strictly in accordance with detail drawings nos. 2898/06, and Structural Engineer's drawings.
- Foundations to be constructed as per details on drawing no. 2898/06, concrete grade 20. Footings to be reinforced top and bottom with A252 mesh.
- New external front wall to be 400mm cavity wall with 100mm split fluted WHITE Forticrete Masonry blocks (400 range) outer leaf as per detail drawing, with matching WHITE Forticrete cill block details at plinth, around and over projecting window head band as shown with matching WHITE Forticrete parapet copings; 100mm cavity with 50mm rigid insulation board fixed against inner leaf with 100mm solid concrete block inner leaf to suit Forticrete modular dimensions (400 range). Carry round the split fluted face around

- all window and door opes (to face of frames). Cavity wall ties to be used at no less than 4 no. per sq.m. with ties at openings, ensuring that all mortar droppings are cleaned off the ties and out to the cavity.
- 32 All internal walls to be 225mm or 100mm solid concrete block as indicated.
- 33 All walls to be plastered internally with 12mm hardwall plaster and skim.
- Roof constructed using two layers of 'Derbiqum S.P.' roofing membrane on a base layer of 30mm thick 'Korktherm' insulation on 'Nilperm' vapour barrier on 'Kingspan' ('See-form'), roof decking on 'Multibeam' purlins Ref. no: 65609 on 254 x 146 x 31 kg/m. universal beams, laid to fall.
- 35 All flashings generally to be No. 5 lead flashing.
- Floors to consist of a levelling screed on 150mm thick concrete (grade 20) floor slab on 1000 gauge Visqueen DPM on 50mm sand blinding on 150mm well consolidated hardcore.
- 37 Include for 1000 gauge visqueen DPC's where shown on drawings.
- Lintols generally to be prestressed concrete units, used strictly in accordance with manufacturer's instructions or as per details shown on the drawings.
- Concrete beams at the front and sides of the building to be cast insitu (grade 30) as per detail on drawing no. 2898/06 + 600189 and in accordance with engineer's details and specification.
- Front face of building to consist of aluminium framed shopfronts as shown. Entire shopfronts, including main door to be aluminium coated with white PVC or white syntha pulvin finish. Framing to be 'shopfront type' box section or similar. Glass in windows AND door to be 12.5mm laminated plated glass.
- External doors and frames to be steel Martin Roberts Guardian Standard doorsets. Hinges to be standard recessed BH1 100mm x 75mm x 26mm template drilled butt hinges 3 hinges per door. Door to Store to have a PH73 panic bolt set and door to toilet to have a MKC 241 upright mortice cylinder sash lock.
- Door and frame from shop to lobby to be standard 1 hour fire check door.
- 43 All other internal doors and frames to be standard flush plywood finished doors.
- 44 Include for providing and fitting 100 x 200mm selected wall tiles to a height of 1.65m around all walls in toilet and ventilated lobby. Wall tiles to be carried down to floor level.
- Provide and fit 100 x 23mm skirtingboards around all walls in building except areas which have wall tiles, where the wall tiles are to be carried down to the floor.
- 46 Provide and fit 225 x 225mm air vents where shown.
- Contractor to include for a suspended ceiling 'Armstrong Microlook Image 600 x 600 x 17mm white tiles' in the shop area and 'Armstrong Minuboard 600 x 600 x 17mm white tiles' in ALL other areas. Suspended ceilings to be supplied and installed by a specialist firm.
- 48 Provide and fit PVC soil and vent pipe where shown.
- 49 Rainwater gutters to be an approved 125mm aluminium gutter. R.W.P.'s to be 100mm diameter PVC.
- The Contractor is to locate the existing water supply to the site. Include for bringing a 25mm hydrodare connection into the building to a water storage tank which is to be located in store.
- Provide and fit an 80 gallon fibreglass storage tank (with overflow pipe) on iron angle bearers in Store exact location to be decided on site. Include for insulating tank and encasing tank with removable timber sheetings. Include for ball cock mechanism and overflow pipe.
- Contractor to include for the supply and fitting of 1 no. Vitreous china low level w.c. suite with overflow pipes and 1 no. 300 x 500mm (approx.) Vitreous china wash hand basin including 2 no. taps in the toilets.

- 53 Include for the supply and installation of 1 no. standard stainless steel sink and base unit with presses under.
- Include for taking 1 no. 12mm spur for drinking water off rising main to the sink unit in the kitchen.
- Include for the following fullway stop valves 25mm on service entry to the building; 12mm on spur to sink unit, the 2 no. w.c.'s, the 2 no. cold water taps on w.h.b.'s.
- Include for bringing 12mm supply pipes from the water storage tank to the w.c. the cold water taps on the w.h.b.'s and 2 no. electric undersink water heaters. The nominated Electrician will supply and fit undersink water heaters. As some undersink water heaters require connections from the rising main rather than the tank, Contractor should check with the Electrician before installing the pipework. Provide and fit 12mm pipes from undersink water heaters to hot taps at both w.h.b.'s and sink unit.
- Dry powder fire extinguishers and 'No Smoking Turn Off Engine' signs are to be provided on the forecourt as required by the Dangerous Substances Act and the Fire Officer's Requirements. The positions in which the petrol tanker will stand while filling the underground storage tanks must also be marked on the concrete apron.
- All surfaces are to be made good after the completion of all works and all rubbish is to be carted away and the site left in a neat and clean condition.

RYAN O'BRIEN HANDY ASSOCIATES

December 1991

Dublin County Council Comhairle Chontae Atha Cliath Planning Department



Bloc 2, Ionad Bheatha na hEireann, Bloc 2, Irish Life Centre, Sraid na Mainistreach lacht, Lower Abbey Street, Baile Atha Cliath 1. Dublin 1. Telephone (01) 724755 Fax (01) 724896

NOTIFICATION OF DECISION TO GRANT PERMISSION LOCAL GOVERNMENT (PLANNING AND DEVELOPMENT)ACTS 1963-1990.

Decision Order Number: P/ 0663 /92 Date of Decision: 13th February 1992

Register Reference: 91A/1993 Date Received: 18th December 1991

Applicant : Conoco Ireland Ltd.,

Development : Redevelopment of Jet Petrol Filling Station, to include

a new shop/office/store building, replacement

underground petrol storage tanks and alterations to

existing canopy.

Location : Jet Petrol Filling Station, Whitechurch Rd.,

Rathfarnham

Floor Area : Sq.Metres

Time Extension(s) up to and including :

Additional Information Requested/Received: //

In pursuance of its functions under the above mentioned Acts, the Dublin County Council, being the Planning Authority for the County Health District of Dublin, did by Order dated as above make a decision to GRANT PERMISSION in respect of the above proposal.

Ryan O'Brien Handy Assoc., 6 Percy Place, Dublin 4.

NOTES

- 1. An appeal against the decision may be made to an Bord Pleanala. The applicant may appeal within one month from the date of receipt by him of this notification. ANY OTHER PERSON may appeal within twenty one days beginning on the date of this decision.
- 2. An appeal shall be in writing and shall state the subject matter and grounds of appeal. It should be addressed to:—

An Bord Pleanala, Blocks 6 and 7, Irish Life Centre, Lower Abbey Street, Dublin 1.

- **3.** An appeal lodged by an applicant or his agent with An Bord Pleanala will be invalid unless accompanied by the prescribed fee.
- (a) An appeal against a decision relating to commercial development by the person by whom the application was made must be accompanied by a fee of £100 (one hundred Pounds).
- "Commercial Development" means development for the purposes of any professional, commercial or industrial undertaking, development in connection with the provision for reward of services to persons or undertakings, or development consisting of the provision of two or more dwellings, but does not include development for the purposes of agriculture.
- (b) An appeal other than an appeal mentioned at (a) above, including third party appeal must be accompanied by a fee of £50 (fifty pounds).
- (c) A party to an appeal making a request to An Bord Pleanana for an Oral Hearing of an appeal must, in addition to the prescribed fee, pay to An Bord Pleanana a fee of £50 (fifty pounds).
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- 4. If the Council makes a decision to grant permission / approval and there is no appeal to An Bord Pleanala against this decision, PERMISSION / APPROVAL will be granted by the Council as soon as may be after the expiration of the period for the taking of such an appeal. If every appeal made in accordance with the Acts has been withdrawn, the Council will grant the PERMISSION / APPROVAL after the withdrawal.
- **5.** Approval of the Council under the Building Bye-Laws must be obtained for new work and the terms of the approval must be complied with in the carrying out of the work before any development which may be permitted is commenced. Approval under the Building Bye-Laws is not applicable to garden walls and entrances etc. Approval under the Building Bye-Laws cannot be obtained in cases involving retention of works previously carried out.

Dublin County Council Comhairle Chontae Atha Cliath





Reg.Ref. 91A/1993
Decision Order No. P/ 0663 /91
Page No: 0002

Bloc 2, Ionad Bheatha na hEireann, Bloc 2, Irish Life Centre, Sraid na Mainistreach Iacht, Lower Abbey Street, Baile Atha Cliath 1. Dublin 1. Telephone (01) 724755 Fax (01) 724896

Subject to the Conditions on the attached Numbered Pages.

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Dublin County Council Comhairle Chontae Atha Cliath Planning Department

Reg.Ref. 91A/1993 Decision Order No. P/ 0663 /91 Page No: 0003



Bloc 2, Ionad Bheatha na hÉireann, Bloc 2, Irish Life Centre, Sraid na Mainistreach Iacht, Lower Abbey Street, Baile Atha Cliath 1. Dublin 1. Telephone (01) 724755

CONDITIONS / REASONS

- 01 The development to be carried out in its entirety in accordance with the plans, particulars and specifications lodged with the application save as may be required by the other conditions attached hereto.

 REASON:To ensure that the development shall be in accordance with the permission and that effective control be maintained.
- 02 That before development commences, approval under the Building Bye- Laws be obtained and all conditions of that approval be observed in the development.

 REASON: In order to comply with the Sanitary Services Acts, 1878-1964.
- 03 That no flag poles or bunting shall be erected on the site without the prior approval of the Planning Authority.
- 03 REASON: In the interest of the proper planning and development of the area.
- 04 Prior to commencement of development to applicant is to ascertain the requirements of the Chief Fire Officer. The applicant is to strictly adhere to these requirements in the development.
- 04 In the interest of safety and the avoidance of fire hazard.
- 05 Prior to commencement of development the applicant is to ascertain the requirements of the Supervising Environmental Health Officer. The applicant is to strictly adhere to these reguirements in the development.
- 05 In the interest of public health.
- 06 That no L.P.G. tanks are to be provided on site without the prior approval of the Planning Authority.
- 06 REASON: In the interest of the proper planning and development of the area.
- 07 That the height of the proposed illuminated sign at the front of the site is not to exceed the height of the canopy.
- 07 REASON: In the interest of the proper planning and development of the area.
- 08 That the footpath at the entrance is to be provided in accordance with the requirements of the Area Engineer, Roads Maintenance Section of Dublin County Council.
- 08 REASON: In the interest of the proper planning and development of the

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Dublin County Council Comhairle Chontae Atha Cliath Planning Department



Bloc 2, Ionad Bheatha na hEireann, Bloc 2, Irish Life Centre, Sraid na Mainistreach lacht, Lower Abbey Street, Baile Atha Cliath 1. Dublin 1. Telephone (01) 724755 Fax (01) 724896

Reg.Ref. 91A/1993 Decision Order No. P/ 0663 /91

Page No: 0004 area.

- 09 That the level of illumination at the site is to be in accordance with the requirements of the Roads Department. In this regard the level of illumination and orientation of any lamps may be reviewed at any time by Dublin County Council. Any required alterations requested by Dublin County Council are to be carried out at the applicants expense.
- 09 REASON: In the interest of the proper planning and development of the area.
- 10 That the proposed external door from the store is to be omitted from the proposed development.

 REASON: The door opens directly onto a laneway used by the adjoining factories. The location of a door in this position would be prejudicial to public safety.
- 11 That the water supply and drainage arrangements, including the disposal of surface water, are to be strictly in accordance with the requirements of the Sanitary Services Department.
- 11 REASON: In order to comply with the Sanitary Services Acts, 1878-1964.

NOTE 1: The applicant should note that the proposed development must adhere to the reguirements of the Dangerous Substances Act, 1970.

NOTE 2: The applicant should note that the provision of the Water Pollution Act must be adhered to.

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Dublin County Council Comhairle Chontae Atha Cliath Planning Department

Building Control Department, Liffey House, Tara Street, Dublin 1. Telephone:773066



Bloc 2, Ionad Bheatha na hEireann, Bloc 2, Irish Life Centre, Sraid na Mainistreach lacht, Lower Abbey Street, Baile Atha Cliath 1. Dublin 1. Telephone (01) 724755 Fax (01) 724896

Date: 19th December 1991

Register Reference: 91A/1993

LOCAL GOVERNMENT (PLANNING AND DEVELOPMENT) ACTS, 1963 TO 1990

Dear Sir/Madam,

DEVELOPMENT: Redevelopment of Jet Petrol Filling Station, to

include a new shop/office/store building, replacement underground petrol storage tanks and alterations to

existing canopy.

LOCATION : Jet Petrol Filling Station, Whitechurch Rd.,

Rathfarnham

APPLICANT : Conoco Ireland Ltd.,

APP. TYPE : PERMISSION

With reference to the above, I acknowledge receipt of your application received on 18th December 1991.

Yours	faithfully,	
• • • • •	•••••	• • • •

for PRINCIPAL OFFICER

Ryan O'Brien Handy Assoc., 6 Percy Place, Dublin 4.

Du County Council Comhairle Chontae Atha Cliath



Planning Application Form/ Bye - Law Application Form

If none, give description sufficient to identity). Name of applicant (Principal not Agent). Conoco Ireland Ltd. Address. CONOCO House, Deansgrange, Co. Dublin Tel. No. 2896644 Nome and address of Ryan O'Brien Handy Associates person or firm responsible for preparation of drawinge 6 Percy Place, Dublin 4. Tel. No. 680899 Name and address to which motifications should be sent 6 Percy Place, Dublin 4. Tel. No. 680899 Name and address to which motifications should be sent 6 Percy Place, Dublin 4. Tel. No. 680899 Name and address to which motifications should be sent 6 Percy Place, Dublin 4. Tel. No. 680899 Reditave lopment of existing pertrol filling station, Including proposed development of existing pertrol filling station, Including proposed development of existing pertrol filling station, Including or buildings to be retained on she, please state: In the case of any building or buildings to be retained on she, please state: In the case of any building or buildings to be retained on she, please state: In the case of any buildings or buildings to be retained on she, please state: In the case of any buildings or buildings to be retained on she, please state: In the case of any buildings or buildings to be retained on she, please state: In the case of any buildings proposed to be retained on the please state: In the case of any buildings proposed development or during states of the establic case; states and the please state the extant to which the Draft Building Regulations have been taken in account in your proposal: See attached notice. Ace you now applying also for an approval under the Building Bye Lawa? Yes Na My Place / in appropriate box. Newspaper notice, 4 copies of specification, location map, Drawing nos. 2898/01,02,03,04,06, 600/6,16C,37,89, 3200/201, Brawing nos. 2898/01,02,03,04,06, 600/6,16C,37,89, 3200/201, Signature of Applicant (or his Agent) In a reduced fee is tendered details of previous relevant payment should be given Pare Payable C 270, 10 Basis of Calculation Plann	PLEASE READ INSTRUCTIO	INS AT BACK BEFORE COMPLETING FOR	RM. ALL QUE	STIONS MUST BE A	NSWERED.	
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1. In the case of any building or buildings to be retained on site, please state: (a) Present use of each floor or use when last used. (b) Proposed use of each floor OD Does the proposal involve demolition, partial demolition or change of use of any habitable house or part thereof? (a) Area of Site (b) Floor area of proposed development (b) Floor area of proposed development (c) Floor area of buildings proposed to be retained within site State applicant's legal interest or estate in site (i.e. freehold, leashold, etc.) Are you now applying also for an approval under the Building Begulations have been taken in account in your proposal: See attached notice. List of documents enclosed with application. Newspaper notice, 4 copies of specification, location map, Drawing nos. 2898/01,02,03,04,06. 600/6,16C,37,89. 3200/201, Gross floor space of proposed development (See back) No of dwellings proposed (if any) N/A Class(es) of Development 8 4 Please state the extent to which the Draft Building Planning Class 8 - \$100. Class 4 - \$97.20 x \$1. If a reduced fee is tendered details of previous relevant payment should be given 13th December 1991 Application Type Register Reference 156. 4 Rethramhana, to include a new such and alterations to the extention of the extention of the extention of the extention of the extentions to the extentions to the extentions to the extentions of the extentions to the extentions of the exte	Method of drainage Mal	ns drainage 8. Source of Wa	ter Supply	Rising Mai	n	
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Approval should be sought only where an outline permission was previously granted. Outline permission may not be sought for the extention of structures or continuance of uses. Portal address of site or building Jet Petrol Filling Station. (If none, give address of title or building building to the permission with its provided by the provided by						
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LOCAL GOVERNMENT (PLANNING & DEVELOPMENT) REGULATIONS 1977 to 1984.



Outline of requirements for applications for permission or Approval under the Local Government (Planning & Development) Acts 1963 to 1983. The Planning Acts and Regulations made thereunder may be purchased from the Government Publications Sales Office, Sun Alliance House, Molesworth Street, Dublin 2.

- Name and Address of applicant.
- Particulars of the interest held in the land or structure, i.e. whether freehold, leasehold, etc. 2.
- 3. The page of a newspaper, circulating in the area in which the land or structure is situate, containing the required statutory notice. The newspaper advertisement should state after the heading Co. Dublin.
 - (a) The address of the structure or the location of the land.
 - (b) The nature and extent of the development proposed. If retention of development is involved, the notice should be worded accordingly. Any demolition of habitable accommodation should be indicated.
 - The name of the applicant.
 - NB. Applications must be received within 2 weeks from date of publication of the notice.
- Four (4) sets of drawings to a stated scale must be submitted. Each set to include a layout or block plan, proposed and existing services to be shown on this drawing, location map, and drawings of relevant floor plans, elevations, sections, details of type and location of septic tank (if applicable) and such other particulars as are necessary to identify the land and to describe the works or structure to which the application relates (new work to be coloured or otherwise distinguished from any retained structures). Buildings, roads, boundaries and other features bounding the structure or other land to which the application relates shall be shown on site plans or layout plans. The location map should be of scale not less than 1: 2500 and should indicate the north point. The site of the proposed development must be outlined in red. Plans and drawings should indicate the name and address of the person by whom they were prepared. Any adjoining lands in which the applicant has an interest must be outlined in blue.
- In the case of a proposed change of use of any structure or land, requirements in addition to 1, 2, & 3 are:
 - (a) a statement of the existing use and the proposed use, or, where appropriate, the former use and the use proposed.
 - (b) (i) Four (4) sets of the drawings to a stated scale must be submitted. Each set to consist of a plan or location map (marked or coloured in red so as to identify the structure or land to which the application relates) to a scale of not less than 1:2500 and to indicate the North point. Any adjoining lands in which the application has an interest must be outlined in blue.
 - (ii) A layout and a survey plan of each floor of any structure to which the application relates.
 - (c) Plans and drawings should indicate the name and address of the person by whom they were prepared.
- Applications should be addressed to: Dublin County Council, Planning Department, Irish Life Centre, Lr. Abbey Street, Dublin 1. Tel. 724755.

SEPTIC TANK DRAINAGE: Where drainage by means of a septic tank is proposed, before a planning application is considered, the applicant may be required to arrange for a trial hole to be inspected and declared suitable for the satisfactory percolation of septic tank effluent. The trial hole to be dug seven feet deep at or about the site of the septic tank. Septic tanks are to be in accordence with I.I.R.S. S.R. 6:75.

INDUSTRIAL DEVELOPMENT:

The proposed use of an industrial premises should, where possible, be stated together with the estimated number of employees, (male and female). Details of trade effluents, if any, should be submitted.

Applicants to comply in full with the requirements of the Local Government (Water Pollution) Act,1977 in particular the licencing provisions of Sections 4 and 16.

SUMMARY OF CLASSES OF DEVELOPMENT/ FEES


CLASS NO.	DESCRIPTION		<u>FEE</u>
1.	Provision of dwelling - House/Flat.		£32.00 each.
2.	Domestic extensions/other improvements.		£16.00 each.
3.	Provision of agricultural buildings (See Regs.)		£40.00 minimum.
4.	Other buildings (i.e. office, commercial, etc.)		£ 1.75 per sq.metre (Min. £40.00).
5.	Use of land (Mining, deposit or waste).		£25.00 per 0.1 ha. (Min. £250.00).
6.	Use of land (Camping, parking, storage).		£25.00 per 0.1 ha. (Min. £40.00).
7.	Provision of plant/machinery/tank or other structure for storage purposes.		£25.00 per 0.1 ha. (Min. £100.00).
8.	Petrol filling station.		£100.00.
9.	Advertising structures.	-	£ 10.00 per sq. m. (Min. £40.00).
10.	Electricity transmission lines.		£ 25.00per 1,000m.(Min. £40.00).
11.	Any other development.		£ 5.00 per 0.1ha. (Min. £40.00),

Cheques etc. should be made payable to: Dublin County Council.

Gross Floor space is to be taken as the total floor space on each floor measured from the inside of the external walls.

For full details of Fees and Exemptions see Local Government (Planning and Development) (Fees) Regulations 1984.

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Ryan O'Brien Handy Associates

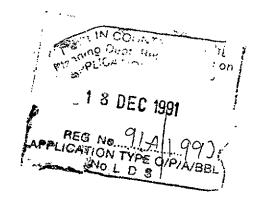6 Percy Place Dublin 4 Telephone 680 899 Facsimile 680 089


DRAFT BUILDING REGULATIONS

It is the practise of this office to take account of the Draft Building Regulations as issued by the Minister for the Environment in the design of buildings but this is not to be interpreted as a guarantee that the provision of the Draft Building Regulations have been implemented in full or in any particular respect in this proposal.

RYAN O'BRIEN HANDY ASSOCIATES Architects & Designers, 6 Percy Place, Dublin 4.

> 111 Wellington Street Luton LU1 5AF

Partners
Denis Handy
DIP ARCH MRIAI MSDI
JOHN McCarthy
DIP ARCH MRIAI MSDI
ASSOCIOTES
Denis Whelan
RIAI (TICH)
Kenneth McEwan
BSC (HONS)
Noel Doyle

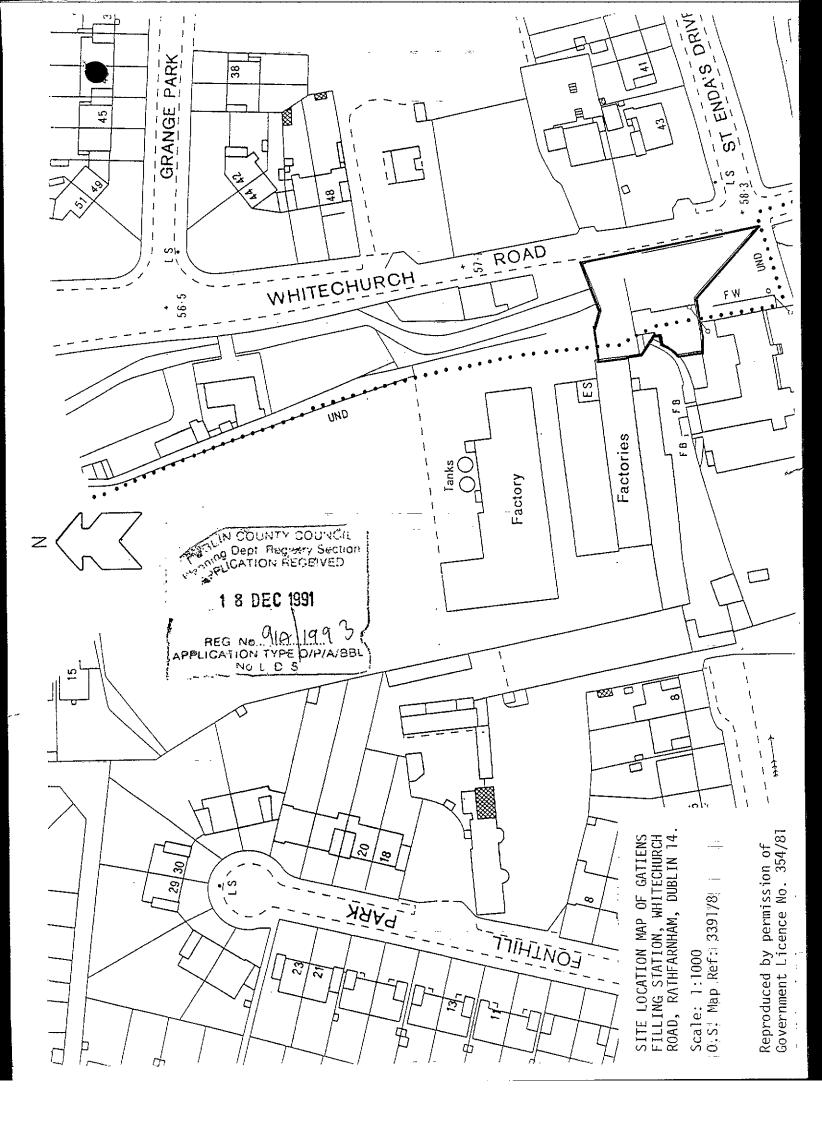


INSTALLATION INSTRUCTIONS FOR INTERCEPTOR TANK.

The interceptor must be handled with care and not subjected to impact or contact with sharp projections. Inspect for damage before installation.

- 1. Mark out the excavation area, leaving a minimum clearance of 250 mm to all sides.
- 2. Excavate a hole to a minimum depth of 1133 mm below the level of the outlet invert.
- 3. Pour concrete (Grade 20) base to a depth of 150 mm, minimum, ensuring that the surface is smooth and level, at 983 mm below the outlet invert. Allow the concrete to set before proceeding further.
- 4. Carefully lower the Interceptor onto the base and level to correct inverts. Align inlet and outlet with drain runs, checking inlet is at the correct end.
- 5. Remove discs from the air vent spigots and half fill each tank with clean water* to ensure that there is no movement when the concrete surround is poured. The Interceptor must remain at all times square and level.
- 6. Pour the concrete (Grade 12) to underside of inlet and outlet spigots, allowing sufficient clearance for pipe connection. Connect all pipework and seal.
- 7. Continue to pour the concrete to a depth of 230 mm above the shoulder of main tanks and allow time for initial set.
- 8. Remove the protective covers from upstands at pre-cut marks with a fine saw and trim excess material down to the top of the concrete.
- 9. Replace interceptor protective covers onto the upstands. Build up manhole chambers to the required level. Manholes formed with solid concrete blocks (to I.S.20) bedded in gauged mortar and rendered both sides with 2 no. coats of sand/cement plaster, finished smooth.
- 10. Top up interceptor with clean water to correct level.
- 11. Position heavy duty manhole covers (to B.S.497: 1976) square and level. Bed frame in cement sand ready for laying finished surface.

IMPORTANT

*Interceptor only to be filled with clean water when in position.

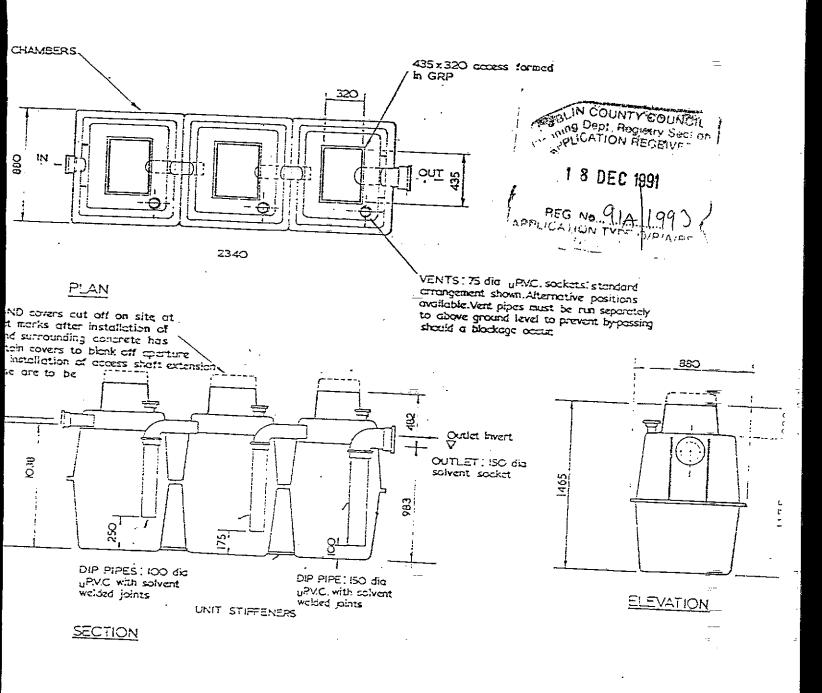

Ryan O'Brien Handy Associates Architects & Designers

Job Title

Drawing title

Petrol Interceptor.


38 Percy Place, Dublin 4 (01) 680661/68089

Date May 1989


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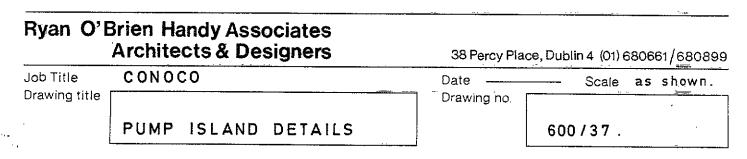
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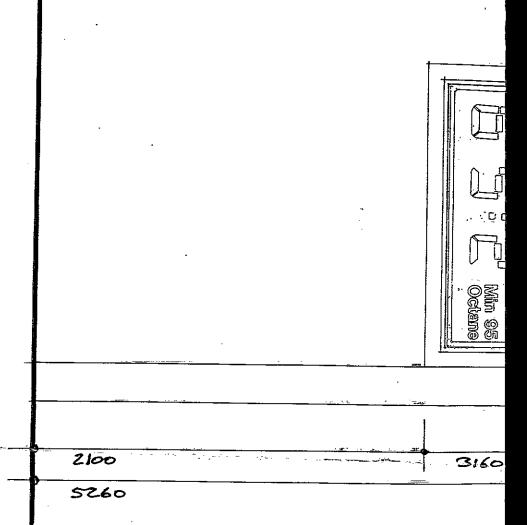


SINGLE PUMP ISLAND (scale 1:20)

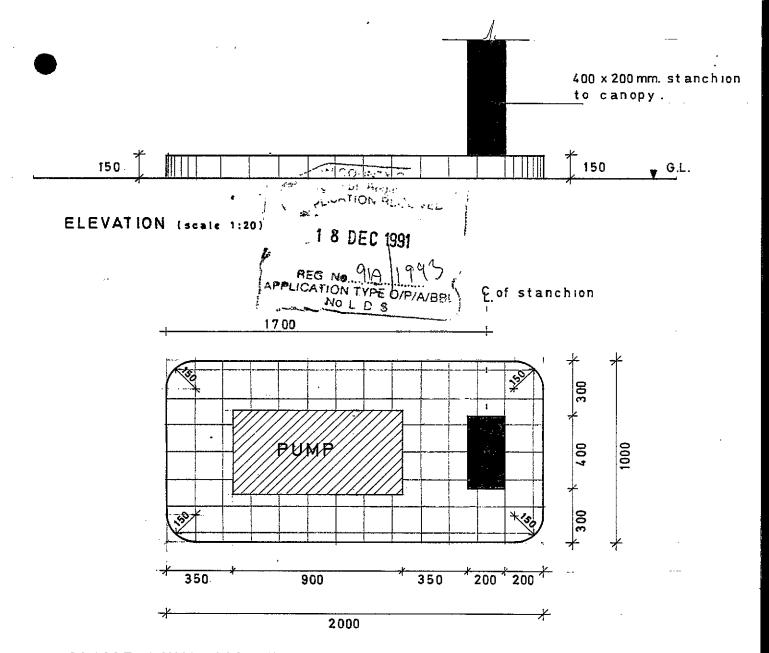

DOUBLE PUMP ISLAND (scale 1:50)



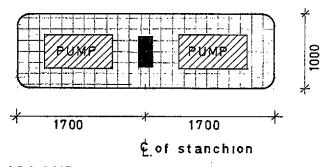

1 8 DEC 1991 ED WOR


ELEVATION


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Date: MAK. '91. Drg. No: 3220/20

...ó Percy Place Dublin 4 Handy Associates O'Brien Ryan



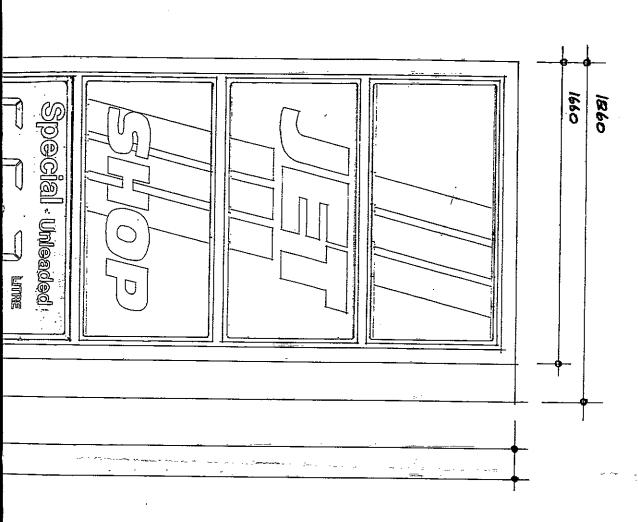

SECTION A-A

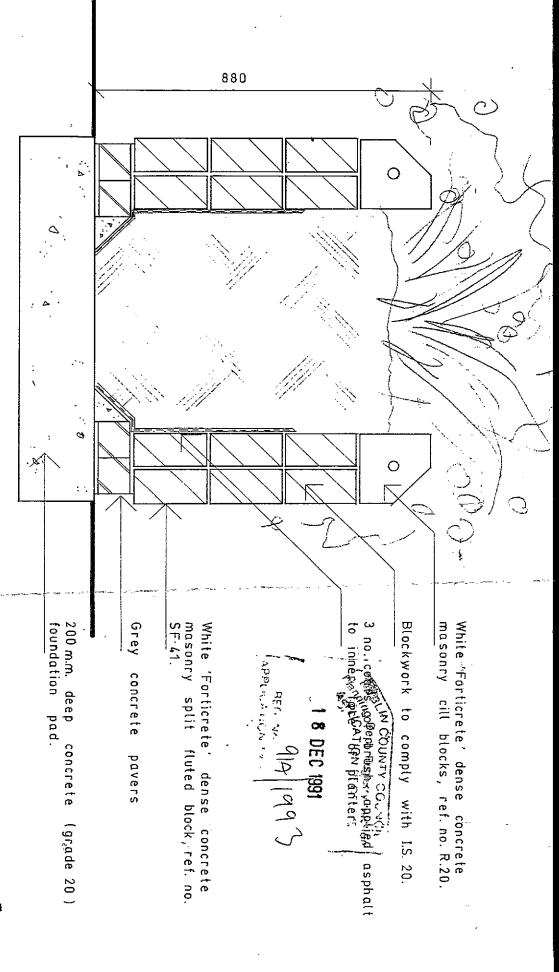CONOCO

Use only figured dimensions.

Planter Detail

Revisions:

Date: Nov. 91

Scale: 1:10 +1:20

Drawing Copyright ©


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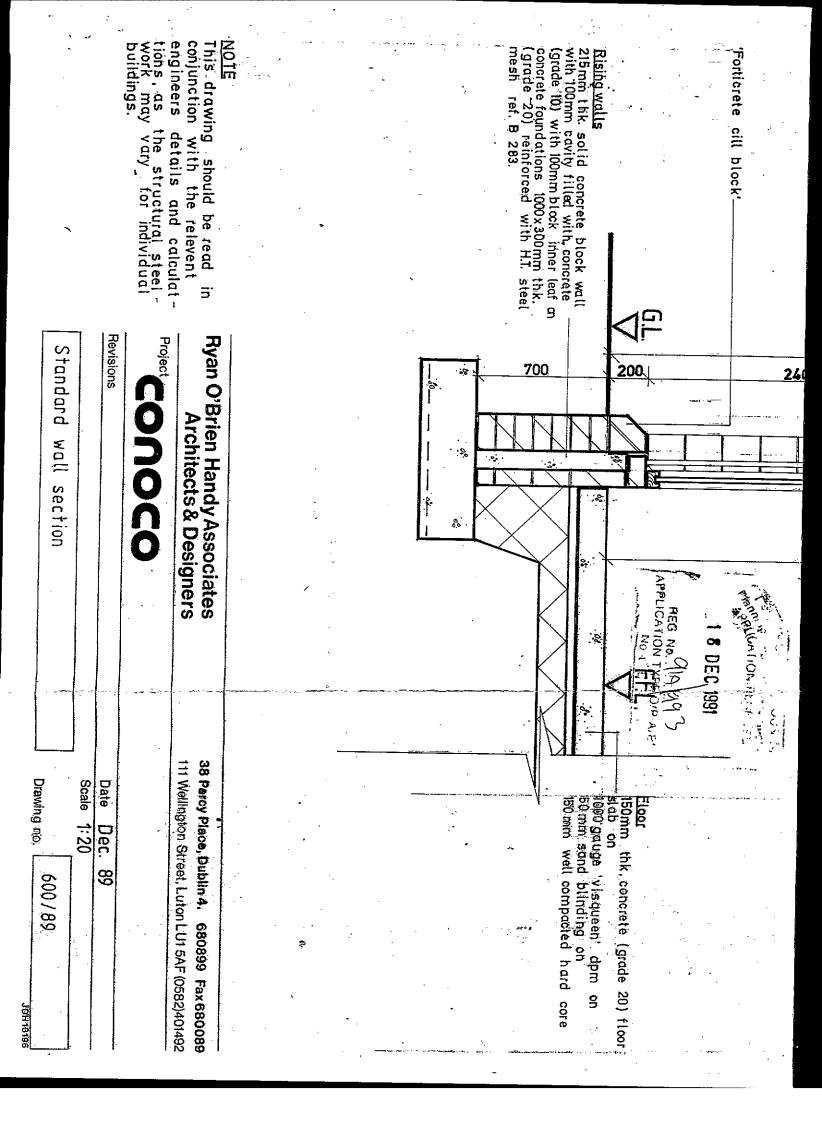
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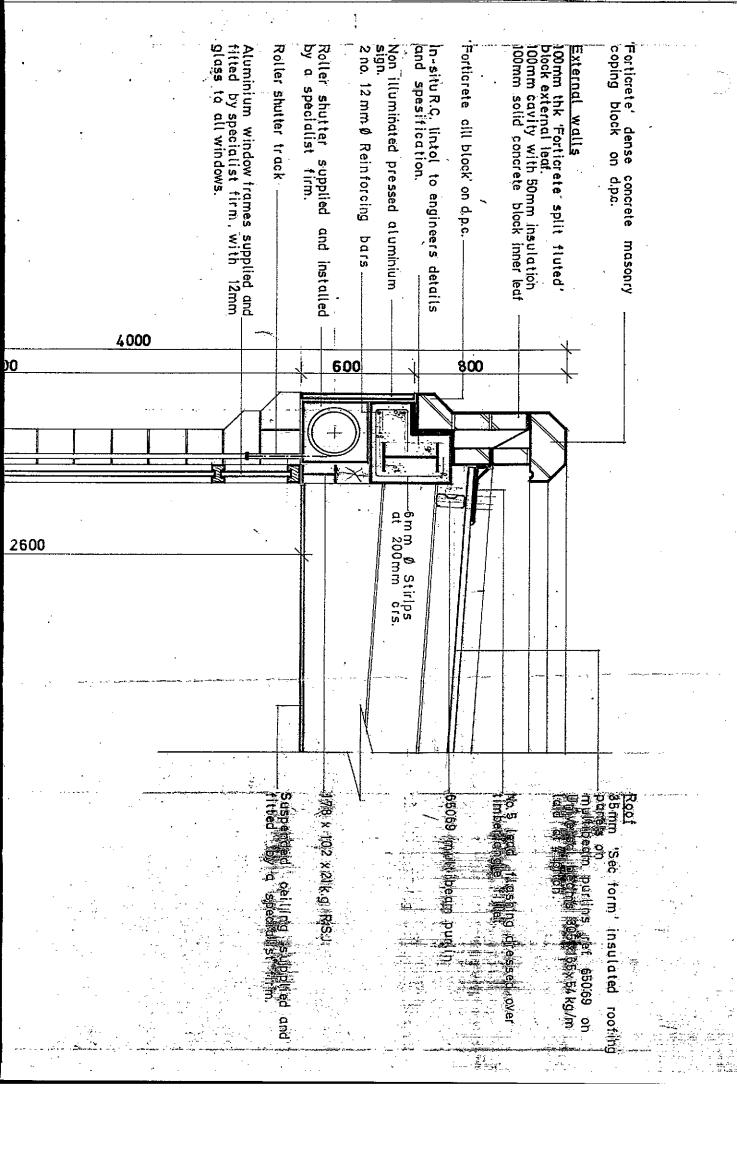
ROBH ARCHITECTS & DESIGNERS


Ryan O'Brien Handy Associates


6 Percy Place Dublin 4 111 Wellington Street Luton LUI SAF






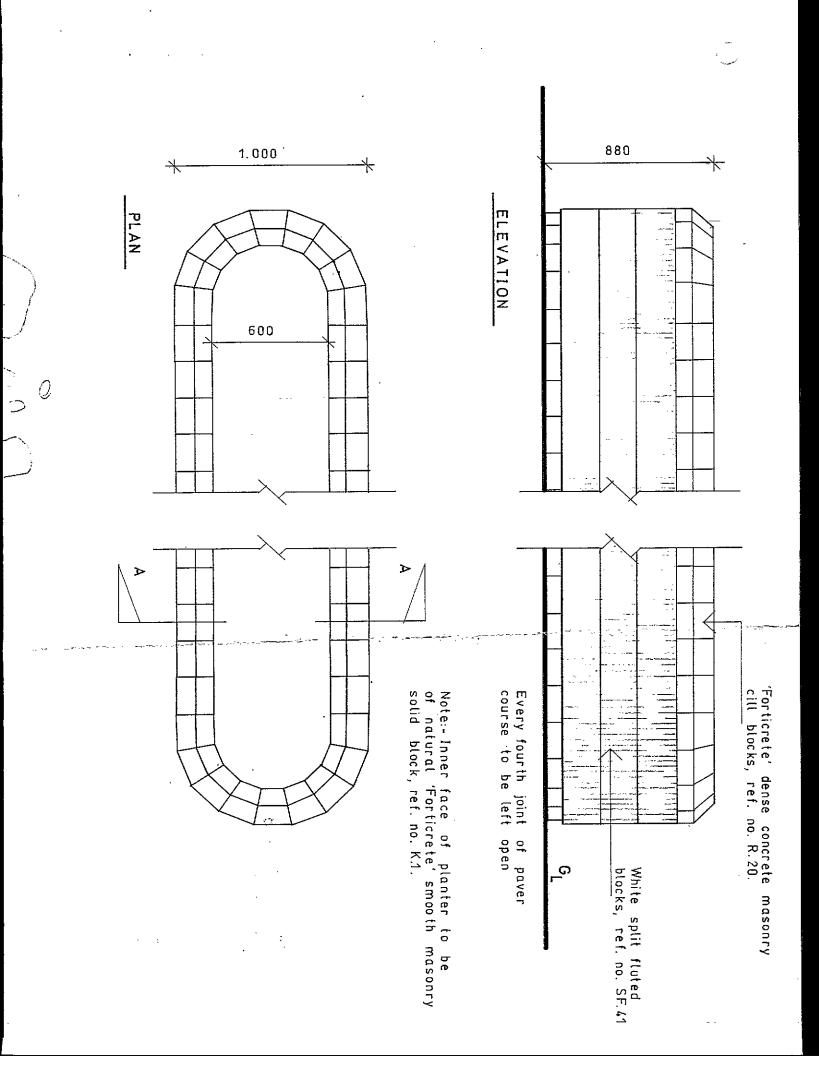

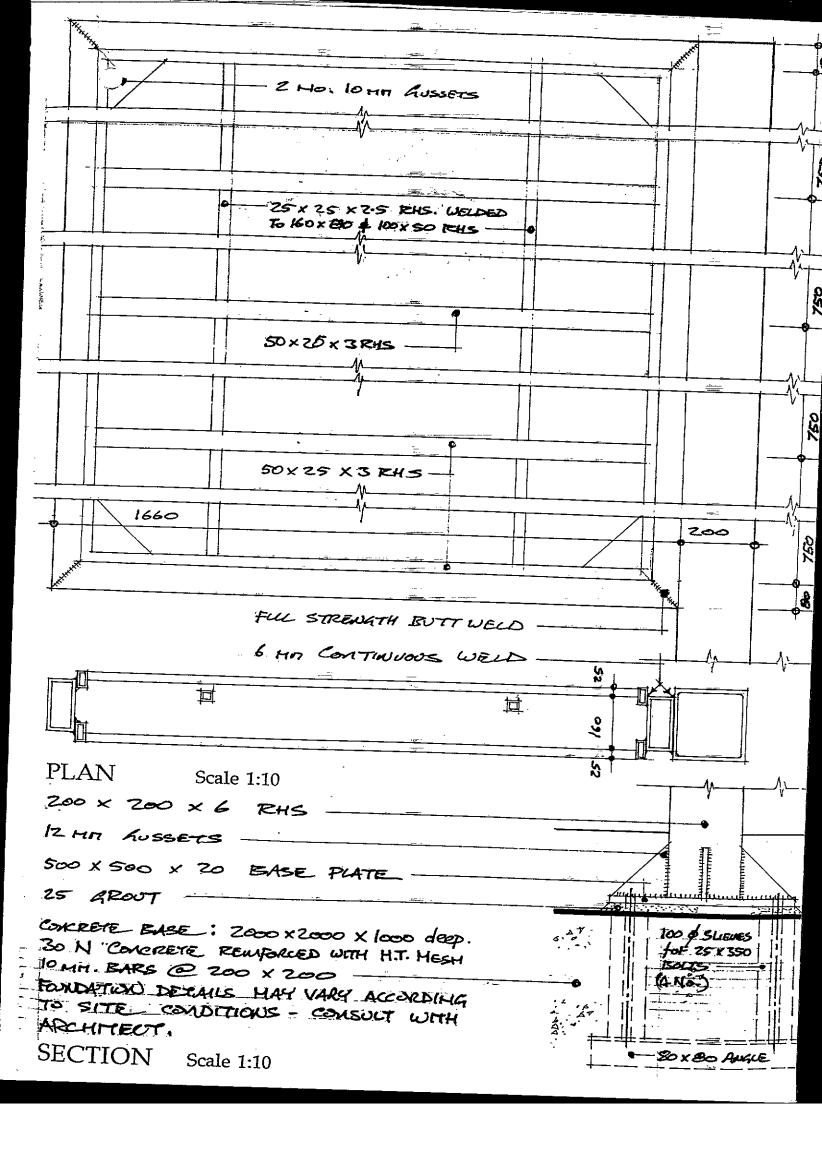

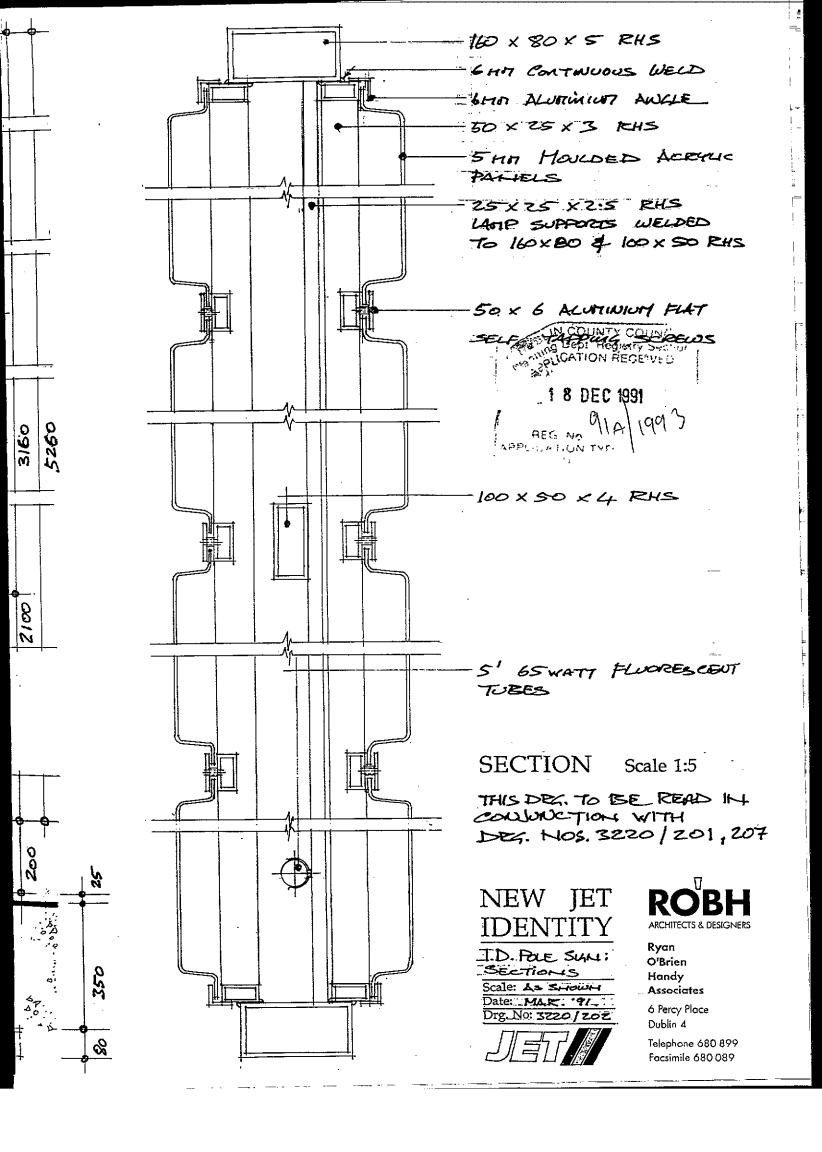

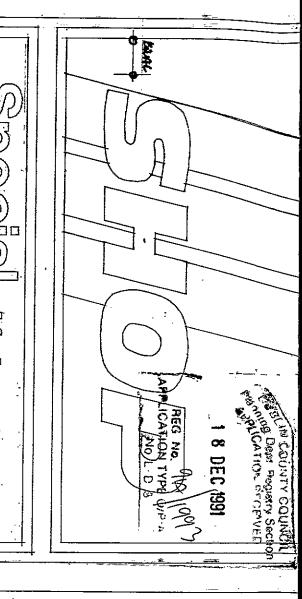

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O'Brien

Ryan

ROBH BH

ARCHITECTS & DESIGNERS

Dublin 4 6 Percy Place Handy Associates

The Moline Holine

TOP 3 PAYTELS:
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SHOP

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_ 1 8 DEC 1991

OUTLINE SPECIFICATION

for

THE REDEVELOPMENT

o f

WHITECHURCH PETROL FILLING STATION, WHITECHURCH ROAD DUBLIN.14.

for

CONOCO IRELAND LTD.

under the supervision of

RYAN O'BRIEN HANDY ASSOCIATES

December 1991

All work is to be carried out strictly in accordance with the Requirements and Regulations of the Local Authority, Building Bye-Laws, Draft Building Regulations and Fire Officer.

All material to be used to be of Irish manufacture and to I.S.S. where applicable and to be the best of their respective kind.

- All Local Authority charges, i.e. water supply connections, drainage connections, E.S.B. and Bord Telecom Charges should not be included in the tender. All such charges will be paid by the Client or be refunded by the Client to the Contractor should the Contractor pay same so as to avoid unnecessary delays.
- It will be the responsibility of the Contractor to inform the Building Control Department with due notice when the foundation trenches, drains, etc., are ready for inspection.
- The Contractor is to include for making good all surfaces where disturbed to match existing finishes after the completion of all works.
- The Contractor is to include for removing all rubbish from the site and to leave the site in a neat and clean condition after the completion of all works.
- As petrol and diesel oil are stored and dispensed on this site, safety is paramount. It is the responsibility of the Contractor to take all precautions necessary while carrying out the works. No welding, cutting of mesh, etc., is to be carried out in the vicinity of the underground tanks or petrol pumps. Contractor to consult with Architects and pipework specialists regarding the positions of existing pipework, electrical ducts, etc., before any excavation work is carried out. Contractor to include for careful excavation in these areas so as to avoid any damage to the pipelines, etc. Before any work commences, Contractor to agree the safety standards necessary with the Architects and Client.
- Contractor to include for very careful excavation of ground surfaces etc., especially around the tanks and across the forecourt so as to avoid drainage to pipe lines, existing electrical ducts, air and water lines etc. It will be the responsibility of the Contractor to consult with the Client, Specialist Firms, Electrician and Architects regarding approx. positions and depths of these services before commencing this work.
- Two existing single compartment underground petrol storage tanks are to be degassed and then removed from the ground and taken away from the site, in accordance with the Dangerous Substances Act. A specialist firm will carry out the degassing of the tanks and the removal of all existing underground pipework from same. The Fire Officer will be given due notice before this work is carried out.
- 10. 2 no. new underground petrol stroage tanks are to be installed where shown on drawing no: 2898/02 strictly in accordance with detail drawing no. 600/16C and in accordance with the Dangerous Substances Act and the Local Fire Officer's requirements. The fitting out and hydraulic water testing of these tanks, all pipework installation of gauges, self-services equipment, etc., are to be carried out by a specialist firm. The Fire Officer is to be informed when this work is being carried out so that he can inspect all stages of the work.
- 11 Contractor is to include for building all manhole chambers with 225mm solid concrete blocks (approx. size 900 x 750 x 950 mm deep). The walls and floors of these chambers to be rendered with 3 no. coats sand and cement. The rendering is to be finished neatly around all pipework and tank manlid.
- The existing E.S.B. supply to the site is to be brought to the new building in an underground duct where a fuseboard, meteres, isolation switches, etc. will be installed in the store. All wiring on the site to the pumps, canopy, sign, lights, etc. are to be laid in 100mm diameter 'Wavin' ducts, 300mm minimum below ground level with adequate inspection chambers and drawpits. All electrical work is to be carried out strictly in accordance with the most recent E.S.B. Regulations and Requirements.
- 13 Contractor to include for taking a 25mm 'Hydrodare' connection from main supply to the new building.

 Include for 25mm full way stop valves on all connections. Pipes to be 450mm minimum below ground level.
- 14 Contractor to include for new planting areas and boundary walls as indicated on drawing no. 2898/02.
- The new surface water drains on the site are to be installed in accordance with the layout drawing. Drains generally to be PVC ('Wavin' or similar) to sizes indicated and to be laid in trenches in straight lines to the required depth and falls. All joints are to be made in strict accordance with the manufacturer's instructions. All drains are to be laid on a minimum 150mm concrete (Grade 12) bed and encased in 150mm concrete

(Grade 12). The trenches are to be back-filled in layers, the material being carefully rammed to consolidate it, care being taken not to damage the pipes and joints. All drains to be water tested for leaks in accordance with CP301.

- Manhole chambers on the surface water drains to be constructed with 225mm hollow concrete blocks rendered with 3 no. coats sand and cement waterproof rendering internally; half round channels formed with easy bends with sand and cement benching to sides. Provide and fit step irons in chambers if necessary. Provide and fit heavy duty cast iron covers and frames bedded in grease.
- All A.J.'s to be PVC (Wavin or similar). Provide 250 x 250mm PVC square rising pieces up to ground level, and finish at top with 275 x 275mm galvanised cast iron covers and frames set in cement mortar and sealed in grease. All A.J.'s to be set on bed of concrete 150mm thick (concrete grade 12).
- 18 Contractor to supply and install PVC gulley traps where shown on drawings.
- The Contractor is to supply and install a prefabricated Conder petrol interceptor trap in accordance with the Manufacturer's instructions, as per detail drawing no. 600/6, on the surface water drain where indicated on the drawings and at the car wash outfall. The Contractor is to supply and install 3 no. 100mm diam. p.v.c. vent pipes to the chambers of the interceptor which are to be joined together underground and 1 no. 100mm diam. p.v.c. pipe to be brought underground to an agreed position on site, up to ground level. A Specialist Firm will supply and fit the upright section above ground. The Contractor is to supply and fit 3 no. heavy duty manhole covers and frames over the 3 no. interceptor chambers.
- The Contractor is to provide and install new 'ACO' drainage channels type C 250 and new 'ACO' silt gulleys where indicated on the drawings.
- New foul drains indicated are to be installed strictly in accordance with the drawings 2898/04, and as described previously for Surface Water Drains.
- Manhole chambers on foul drain to be constructed with 225mm solid concrete blocks rendered inside and outside with 3 no. coats sand and cement waterproof rendering, half round channels formed with easy bends with sand cement benching at 1:12 to sides. Provide and fit step irons to chambers as necessary and provide and fit heavy duty cast iron covers and frames, sealed in grease.
- 23 All A.J.'s to be installed as previously described in Clause No. 18.
- 24 Provide and fit PVC gulley traps where shown.
- 25 Contractor to include for 150mm minimum of well consolidated hardcore under all new ground surfaces.
- The forecourt area under the canopy is to be surfaced with concrete paving setts laid in strict accordance with the manufacturer's instructions and specification.
- The remainder of the forecourt, as indicated, 250mm deep reinforced concrete (grade 20) laid to falls as detailed on drawing no. 2898/04).
- A new canopy is to be erected on site in position indicated on drawing. The canopy, with illuminated fascias on three sides, is to be fabricated, supplied and erected by a specialist firm. The canopy shall be constructed with R.H.S. steel stanchions, steel intermediate members with aluminium top sheeting, soffite sheeting and steel fascias.
- The new shop/store building is to be built strictly in accordance with detail drawings nos. 2898/06, and Structural Engineer's drawings.
- Foundations to be constructed as per details on drawing no. 2898/06, concrete grade 20. Footings to be reinforced top and bottom with A252 mesh.
- New external front wall to be 400mm cavity wall with 100mm split fluted WHITE Forticrete Masonry blocks (400 range) outer leaf as per detail drawing, with matching WHITE Forticrete cill block details at plinth, around and over projecting window head band as shown with matching WHITE Forticrete parapet copings; 100mm cavity with 50mm rigid insulation board fixed against inner leaf with 100mm solid concrete block inner leaf to suit Forticrete modular dimensions (400 range). Carry round the split fluted face around

- all window and door opes (to face of frames). Cavity wall ties to be used at no less than 4 no. per sq.m. with ties at openings, ensuring that all mortar droppings are cleaned off the ties and out fo the cavity.
- 32 All internal walls to be 225mm or 100mm solid concrete block as indicated.
- 33 All walls to be plastered internally with 12mm hardwall plaster and skim.
- Roof constructed using two layers of 'Derbiqum S.P.' roofing membrane on a base layer of 30mm thick 'Korktherm' insulation on 'Nilperm' vapour barrier on 'Kingspan' ('Sec-form'), roof decking on 'Multibeam' purlins Ref. no: 65609 on 254 x 146 x 31 kg/m. universal beams, laid to fall.
- 35 All flashings generally to be No. 5 lead flashing.
- Floors to consist of a levelling screed on 150mm thick concrete (grade 20) floor slab on 1000 gauge Visqueen DPM on 50mm sand blinding on 150mm well consolidated hardcore.
- 37 Include for 1000 gauge visqueen DPC's where shown on drawings.
- Lintols generally to be prestressed concrete units, used strictly in accordance with manufacturer's instructions or as per details shown on the drawings.
- Concrete beams at the front and sides of the building to be cast insitu (grade 30) as per detail on drawing no. 2898/06 + 600189 and in accordance with engineer's details and specification.
- Front face of building to consist of aluminium framed shopfronts as shown. Entire shopfronts, including main door to be aluminium coated with white PVC or white syntha pulvin finish. Framing to be 'shopfront type' box section or similar. Glass in windows AND door to be 12.5mm laminated plated glass.
- External doors and frames to be steel Martin Roberts Guardian Standard doorsets. Hinges to be standard recessed BH1 100mm x 75mm x 26mm template drilled butt hinges 3 hinges per door. Door to Store to have a PH73 panic bolt set and door to toilet to have a MKC 241 upright mortice cylinder sash lock.
- Door and frame from shop to lobby to be standard 1 hour fire check door.
- 43 All other internal doors and frames to be standard flush plywood finished doors.
- 44 Include for providing and fitting 100 x 200mm selected wall tiles to a height of 1.65m around all walls in toilet and ventilated lobby. Wall tiles to be carried down to floor level.
- Provide and fit 100 x 23mm skirtingboards around all walls in building except areas which have wall tiles, where the wall tiles are to be carried down to the floor.
- 46 Provide and fit 225 x 225mm air vents where shown.
- Contractor to include for a suspended ceiling 'Armstrong Microlook Image 600 x 600 x 17mm white tiles' in the shop area and 'Armstrong Minuboard 600 x 600 x 17mm white tiles' in ALL other areas. Suspended ceilings to be supplied and installed by a specialist firm.
- Provide and fit PVC soil and vent pipe where shown.
- 49 Rainwater gutters to be an approved 125mm aluminium gutter. R.W.P.'s to be 100mm diameter PVC.
- The Contractor is to locate the existing water supply to the site. Include for bringing a 25mm hydrodare connection into the building to a water storage tank which is to be located in store.
- Provide and fit an 80 gallon fibreglass storage tank (with overflow pipe) on iron angle bearers in Store exact location to be decided on site. Include for insulating tank and encasing tank with removable timber sheetings. Include for ball cock mechanism and overflow pipe.
- 52 Contractor to include for the supply and fitting of 1 no. Vitreous china low level w.c. suite with overflow pipes and 1 no. 300 x 500mm (approx.) Vitreous china wash hand basin including 2 no. taps in the toilets.

- 53 Include for the supply and installation of 1 no. standard stainless steel sink and base unit with presses under.
 - 4 Include for taking 1 no. 12mm spur for drinking water off rising main to the sink unit in the kitchen.
 - Include for the following fullway stop valves 25mm on service entry to the building; 12mm on spur to sink unit, the 2 no. w.c.'s, the 2 no. cold water taps on w.h.b.'s.
 - Include for bringing 12mm supply pipes from the water storage tank to the w.c. the cold water taps on the w.h.b.'s and 2 no. electric undersink water heaters. The nominated Electrician will supply and fit undersink water heaters. As some undersink water heaters require connections from the rising main rather than the tank, Contractor should check with the Electrician before installing the pipework. Provide and fit 12mm pipes from undersink water heaters to hot taps at both w.h.b.'s and sink unit.
 - Dry powder fire extinguishers and 'No Smoking Turn Off Engine' signs are to be provided on the forecourt as required by the Dangerous Substances Act and the Fire Officer's Requirements. The positions in which the petrol tanker will stand while filling the underground storage tanks must also be marked on the concrete apron.
 - All surfaces are to be made good after the completion of all works and all rubbish is to be carted away and the site left in a neat and clean condition.

RYAN O'BRIEN HANDY ASSOCIATES

December 1991