LAW APPLICATION FEES 91A/0927 CERTIFICATE NO.: i altoatras PROPOSAL: Indistricia Estato LCCATION: ked widge APPLICANT: 7 3 4 5 6 2 1

CLASS	DWELLINGS/AREA LENGIH/STRUCTURE	RATE	AMT. OF FEE REQUIRED	AMT. LOCGED	BALANCE	RED. FEE APPL.	AME. CE	
А	Dwelling (Houses/Flats.)	@ £55						
В	Domestic Ext. (Improvement/ Alts.)	@ £30						
C *	Building for office or other comm. nurpose	@ £3.50 ; per M ² cr £70	7472.50	74.8 H=	2450	o cially	ot	
D	Building or other structure for purposes of agriculture	@ £1.00 per M ² in excess of 300 M ² Min. £70						
E	Petrol Filling Station	@ £200					,	····
F	Dev. of prop. not coming within any of the forgoing classes	£70 or £9 per .1 hect. whichever is the greater					_	

Column Certified: Signed:	Grade: DHI	Cate: 18/6/9
Column 1 Endorsed: Signed:	Grade:	_ Date: _//
Columns 2,3,4,5,6 & 7 Certified:	Signed: USO Grade: 8:0	Data / 44/
Columns 2,3,4,5,6 & 7 Endorsed:	Signed: Grade:	Date/

RW/GC

Osbarne Associates, The Mews, kerrymount Avenue, Foxrock, Dublin 18.

18/6/91

Re; Office alterations at Unit No. 21 Parkmore Industrial Estate, Long Mile Road, Dublin 12 for D & P Ledwidge. Reg.Ref. 91A/0927

Dear Sirs,

I refer to the above planning and bye-law application received in this department on 29/5/91. The correct fee in respect of this application cannot be assessed as the area of proposed development has not been outlined on the drawings lodged.

As the statutory 2-month period within which the planning authority must make a decision will not begin to run until the correct fee has been paid, it is important that you immediately submit a drawing outlining in colour the area of proposed development.

Yours faithfully,

for PRINCIPAL OFFICER

914/0927	নিটালটোর হলে ব্যক্ত । ব্যক্ত র জার্ড কি প্রকৃত ।	and the second of the	CE	RTIFICATE A	255	3.4	
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LCCATION GOVERNMENT (FLANNING AND DEVELOPMENT) ACTS, 1953 TO 1982

ASSESSMENT OF FINANCIAL CONTRIBUTION

REG. REF.: 916	2/92
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CONT. REG.:

SERVICES INVOLVED: WATER/FOUL SEMER/SURFACE WATER_

AREA OF SITE:

FLOOR AREA OF FRESENT PROPOSAL: 1446 F

NEASURED EY:

CHECKED BY:

NETHOD OF ASSESSMENT:

TOTAL ASSESSMENT

MANAGER'S CEDENED NO: P/ 1

CALEE

ENTERED IN CONTRIBUTIONS REGISTER:

18/6/91.

1000 0 10

1084

DEVELOPMENT CONTROL ASSISTANT GRADE

JAPILIA POPILIA

Register Reference: 91A/0927

Date : 11th June 1991

®

Development : Office alterations

: Unit No. 21, Parkmore Industrial Estate, Dublin 12.

Applicant : Dorothy & Paul Ledwidge

: PERMISSION/BUILDING BYE-LAW APPROVAL App. Type

Planning Officer : N.O'BYRNE

Date Recd. : 29th May 1991 .

Attached is a copy of the application for the above development . Your report would be appreciated within the next 28 days.

Yours faithfully, DUBLIN CO. COUNCIL PRINCIPAL OFFICER - 5JUL 1991 Date received in Sanitary Services .. 18. JUN 1991. FOUL SEWER

LOCATION

Dowiloth - existing 1915en.

PLANNING DEPT. DEVELOPMENT CONTROL SECT Date 08.07.91

SURFACE WATER

Available - estiling 19 1/24.

dellin 2/1/11.

SENIOR ENGINEER, SANITARY SERVICES DEPARTMENT, 46/49 UPPER O'CONNELL STREET, DUBLIN 1

ENGS.

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PLANNING DEPT.	
CONTROL SEC!	۱
Date 08.04.91	
Date	
2.30	•
MINA	

Register Reference : 91A/0927

Date: 11th June 1991

ENDORSED	DATE	······································
WATER SUPPLY. EXVIEN	Supely-rook	Affant Work
endorsed 25 Cy	DY DATE <u>28/6/94</u>	ure.

14266 91

COMHAIRLE CHONTAE ÂTHA CLIATH

Record of Executive Business and Manager's Orders

Register Reference: 91A/0927

Date Received : 29th July 1991

Correspondence : Osborne Associates,

Name and

: The Mews,

Address

Kerrymount Avenue,

Foxrock.

Development : Office alterations

Location : Unit No. 21, Parkmore Industrial Estate, Dublin 12

Applicant : Dorothy & Paul Ledwidge

App. Type : Permission

Zoning

Floor Area :

Sq.metres

್ಷಣ್ (NOB/BB)

Report of Dublin Planning Officer dated 4th September, 1991.

This is an application for PERMISSION for office alterations to an existing industrial unit at Parkmore Industrial Estate.

The proposal involves altering the office accommodation in the existing premises. The result would be the office space providing 46% of the accommodation in the premises.

The site is in a prominent location at the entrance to this industrial estate and fronting onto the Longmile Road. The proposal involves 3 new window openings at first floor level. The windows proposed are not in keeping with the scale or design of first floor windows on the adjoining premises, particularly

the window indicated for the side elevation. This would have an undesirable impact on the overall design of this industrial complex.

Sanitary Services Report not available.

Supervising Environmental Health Officer report not available.

Additional Information was requested from the applicant on the 25th July, 1991, with regard to the following:-

1. The proposed development includes provision for first floor window openings which are not consistent with the design and scale of first floor window openings on the adjoining premises. The applicant is requested to submit revised proposals which would maintain the overall design character of the complex as a whole.

COMHAIRLE CHONTAE ATHA CLIATH

Reg. Ref. Record 20 Executive Business and Manager's Orders

Page No: 0002

Location: Unit No. 21, Parkmore Industrial Estate, Dublin 12.

- 2. The applicant is requested to clarify the scale and proposed use of this industrial unit by providing a full schedule of existing floor space use and proposed use for the entire premises.
- 3. In view of the fact that the site is located within the jurisdiction of Dublin County Council a revised newspaper advertisement is required seeking permission from Dublin County Council. Applicant is requested to submit a revised notice with the heading "Dublin County Council".

In reply

- 1. The applicants have submitted revised elevations proposing alterations to the first floor windows to provide for new window identical to the existing window types used in the building. This arrangement is more acceptable as it provides for an integrety of design more suited to this permanent location.
- 2. A schedule of floor areas has been submitted. This clarifies the proposed development. An additional 134 sq. metres of office space is proposed and the warehouse area is being reduced by 74 sq. metres. The premises is intended for use as a base for a courfier business. The location in an industrial estate for such a use is acceptable and the use of such a business requires a relatively high proportion office content. A 'counter' is indicated for the display area. No retail use has been indicated or suggested.
- 3. A revised public notice has been received.

Chief Medical Officer report noted.

I recommend that a decision to GRANT PERMISSION be made under the Local Government (Planning and Development) Acts, 1963-1990 subject to the following ((_)) conditions:-

CONDITIONS/REASONS

Ol The development to be carried out in its entirety in accordance with the plans, particulars and specifications lodged with the application, as amended by additional information received on 29 July 1991 save as may be required by the other conditions attached hereto.

COMHAIRLE CHONTAE ÁTHA CLIATH

Reg. Ref Records of Executive Business and Manager's Orders

Page No: 0003

Location: Unit No. 21, Parkmore Industrial Estate, Dublin 12.

REASON: To ensure that the development shall be in accordance with the permission and that effective control be maintained.

- 02 That before development commences, approval under the Building Bye- Laws be obtained and all conditions of that approval be observed in the development. REASON: In order to comply with the Sanitary Services Acts, 1878-1964.
- 03 That the requirements of the Supervising Environmental Health Officer be ascertained and strictly adhered to in the development. REASON: In the interest of health.
- 04 That the requirements of the Chief Fire Officer be ascertained and strictly adhered to in the development. REASON: In the interest of safety and the avoidance of fire hazard.
- 05 That the warehouse display area shall not be used for retail purposes.
- 05 REASON: In the interest of the proper planning and development of the area.
- That a financial contribution in the sum of £1,084 be paid by the proposer to Dublin County Council towards the provision of public services in the area of the proposed development and which will facilitate the proposed development; this contribution to be paid prior to the commencement of development on site.
- REASON: In the interest of the proper planning and development 06 of the area.

ind I for working for hours

COMHAIRLE CHONTAE ÂTHA CLIATH

Reg.Ref.Record2 of Executive Business and Manager's Orders

Page No: 0004

Location: Unit No. 21, Parkmore Industrial Estate, Dublin 12.

Endorsed:	for Dublin Planning Officer
for Principal Officer '	
•	
Order: A decision pursuant to Section 2	
(Planning and Development) Acts, 1963-1	990 to GRANT PERMISSION
for the above proposal subject to the (() conditions set out above

for the above proposal subject to the (() conditions set out above is hereby made.

ASSISTANT CITY AND COUNTY MANAGER to whom the appropriate powers have been delegated by order of the Dublin City and County Manager dated 26 August, 1991.

COMHAIRLE CHONTAE ÂTHA CLIATH

Record of Executive Business and Manager's Orders

Proposed office alterations to unit no. 21, Parkmore Industrial Estate, Longmile Road for Dorothy & Paul Ledwidge.

Osborne Associates, The Mews, Kerrymount Avenue, Foxrock. Reg. Ref.
Appl. Rec'd:
Floor Area:
Site Area:

91A-0927 29.05.1991 200 sq. m. 1,000 sq. m.

Zoning:

Report of the Dublin Planning Officer, dated 23 July 1991

This is an application for PERMISSION for office alterations to an existing industrial unit at Parkmore Industrial Estate.

The proposal involves altering the office accommodation in the existing premises. The result would be the office space providing 46% of the accommodation in the premises.

The site is in a prominent location at the entrance to this industrial estate and fronting onto the Longmile Road. The proposal involves 3 new window openings at first floor level. The windows proposed are not in keeping with the scale or design of first floor windows on the adjoining premises, particularly the window indicated for the side elevation. This would have an undesirable impact on the overall design of this industrial complex.

Sanitary Services Section report No available

Chief Fire Officer report not available

Supervising Environmental Health Officer report available.

- I recommend that ADDITIONAL INFORMATION be requested from the applicant with regard to the following:-
- The proposed development includes provision for first floor window openings which are not consistent with the design and scale of first floor window openings on the adjoining premises. The applicant is requested to submit revised proposals which would maintain the overall design character of the complex as a whole.
- 2. The applicant is requested to clarify the scale and proposed use of this industrial unit by providing a full schedule of existing floor space use and proposed use for the entire premises.

(Continued)

COMHAIRLE CHONTAE ÅTHA CLIATH

Record of Executive Business and Manager's Orders

Proposed office alterations to unit no. 21, Parkmore Industrial Estate, Longmile Road for Dorothy & Paul Ledwidge.

Estate, Longmile Road for Dorothy & Paul Ledwidge.
(Continued)
3 In new of the fact that the site is located within the jurisdiction of lublic Co. Commit a revised newspaper adventigment is required section permission from Dublic Country Council.
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Applicant is lequested to saluch a Revised Notice with
Applicant is lequestone to salmit a kerred notice until the heading Duldin country Council
(NOD (DK)
(NOB/DK)
For Dublin Planning Officer
Endorsed:
for Principal Officer
Order:- I direct that ADDITIONAL INFORMATION be requested from the applicant for planning permission as set out in
the above report and that notice thereof be served on
the applicant.
Dated:) July, 1991.
Assistant City & County Manager.
to whom the appropriate powers have been delegated by Order of the

(29 th May) D NOB.

Register Reference: 91A/0927

Date: 11th June 1991

Development : Office alterations

: Unit No. 21, Parkmore Industrial Estate, Dublin 12. LOCATION

: Dorothy & Paul Ledwidge Applicant

: PERMISSION/BUILDING BYE-LAW APPROVATIBLIN COUNTY C App. Type

Planning Officer: N.O'BYRNE

Date Recd. : 29th May 1991

Attached is a copy of the application for the above development . Your report would be appreciated within the next 28 days.

PLANNING DEPT. DEVELOPMENT CONTROL SECT 25-07-91....

Yours faithfully,

PRINCIPAL OFFICER

* \$ JU 2000

I have no objections to this proposel.

providing that, I TEEK making publices are provided for staff 2 Deinking nates supply points, deceit from rising main, are provided for steff

3 Intervening lossies adjacent to sanitary accommedation are vertilated directly to extend air (minimum 2 air changes) hr.)

I lequirements of following legislation are complied with

a) Office Premises Act 1958 and regulations. b) Sefety in Industries Acts 1955-802

c) Nealth. Sefety & welfale at work Act SUPER. ENVIRON. HEALTH OFFICER, 1989. 33 GARDINER PLACE

33 GARDINER PLACE,

DUBLIN 1. Sta Devine Pully SEHO

Jackie Kelly 240 21/7/71

Dublin County Council Comhairle Chontae Atha Cliath

Planning Department



Bloc 2, Ionad Bheatha na hÉireann, Block 2, Irish Life Centre, Sraid na Mainistreach Iacht, Lower Abbey Street, Baile Atha Cliath 1. Dublin 1.

Telephone. (01)724755 Fax. (01)724896

NOTIFICATION OF DECISION TO GRANT PERMISSION LOCAL GOVERNMENT (PLANNING AND DEVELOPMENT) ACTS 1963-1990.

Decision Order Number: P/ 4266 /91 Date of Decision: 18th September 1991

Register Reference: 91A/0927 Date Received: 29th July 1991

Applicant : Dorothy & Paul Ledwidge

Development : Office alterations

Location : Unit No. 21, Parkmore Industrial Estate, Dublin 12.

Floor Area : Sq.Metres

Time Extension(s) up to and including :

Additional Information Requested/Received: 250791//290791

In pursuance of its functions under the above mentioned Acts, the Dublin County Council, being the Planning Authority for the County Health District of Dublin, did by Order dated as above make a decision to GRANT PERMISSION in respect of the above proposal.

Subject to the Conditions on the attached Numbered Pages.

Signed on behalf of the Dublin County Council.... for Principal Officer

Date: 20/9/

Osborne Associates, The Mews, Kerrymount Avenue, Foxrock.

NOTES

- 1. An appeal against the decision may be made to An Bord Pleanala. The applicant may appeal within one month from the date of receipt by him of this notification. ANY OTHER PERSON may appeal within twenty one days beginning on the date of this decision.
- 2. An appeal shall be in writing and shall state the subject matter and grounds of appeal. It should be addressed to:-

An Bord Pleanala, Blocks 6 and 7 Irish Life Centre, Lower Abbey Street, Dublin 1.

- **3.**An appeal lodged by an applicant or his agent with An Bord Pleanala will be invalid unless accompanied by the prescribed fee.
- (a) An appeal against a decision relating to commercial development by the person by whom the application was made must be accompanied by a fee of £100 (one hundred Pounds).
- "Commercial Development" means development for the purposes of any professional, commercial or industrial undertaking, development in connection with the provision for reward of services to persons or undertakings, or development consisting of the provision of two or more dwellings, but does not include development for the purposes of agriculture.
- (b) An appeal other then an appeal mentioned at (a) above, including third party appeal must be accompanied by a fée of £50 (fifty pounds)
- (c) A party to an appeal making a request to An Bord Pleanala for an Oral Hearing of an appeal must, in addition to the prescribed fee, pay to An Bord Pleanala a fee of £50 (fifty pounds).
- (d) A person who is not a party to an appeal must pay a fee of £15 (fifteen pounds) to An Bord Pleanala when making submissions or observations to An Bord Pleanala in relation to an appeal.
- **4.**If the Council makes a decision to grant permission/approval and there is no appeal to An Bord Pleanala against this decision, PERMISSION/APPROVAL will be granted by the Council as soon as may be after the expiration of the period for the taking of such an appeal. If every appeal made in accordance with the Acts has been withdrawn, the Council will grant the PERMISSION/APPROVAL after the withdrawal.
- **5.** Approval of the Council under the Building Bye-Laws must be obtained and the terms of the approval must be complied with in the carrying out of the work before any development which may be permitted is commenced.

Dublin County Council Comhairle Chontae Atha Cliath

Planning Department

Fax. (01)724896

Reg.Ref. 91A/0927

Decision Order No. P/ 4266 /91

Page No: 0002



Bloc 2, Ionad Bheatha na hEireann, Block 2, Irish Life Centre, Sraid na Mainistreach Iacht, Lower Abbey Street, Baile Atha Cliath 1. Dublin 1. Telephone. (01)724755

CONDITIONS / REASONS

- 01 The development to be carried out in its entirety in accordance with the plans, particulars and specifications lodged with the application, as amended by additional information received on 29 July 1991 save as may be required by the other conditions attached hereto.

 REASON: To ensure that the development shall be in accordance with the permission and that effective control be maintained.
- 02 That before development commences, approval under the Building Bye- Laws be obtained and all conditions of that approval be observed in the development.
 - REASON: In order to comply with the Sanitary Services Acts, 1878-1964.
- 03 That the requirements of the Supervising Environmental Health Officer be ascertained and strictly adhered to in the development.

 REASON: In the interest of health.
- 04 That the requirements of the Chief Fire Officer be ascertained and strictly adhered to in the development.

 REASON: In the interest of safety and the avoidance of fire hazard.
- 05 That the warehouse display area shall not be used for retail purposes.
- 05 REASON: In the interest of the proper planning and development of the area.
- 06 That a financial contribution in the sum of 1084.00 be paid by the proposer to the Dublin County Council towards the provision of public services in the area of the development and which facilitates this development. This contribution to be paid prior to the commencement of development on site.
 - REASON: In the interest of the proper planning and development of the area.
- 07 That the office use be subsidiary to the use of Unit 21 for warehousing purposes.
- 07 REASON: In the interest of the proper planning and development of the area.

NOTES

- 1. An appeal against the decision may be made to An Bord Pleanala. The applicant may appeal within one month from the date of receipt by him of this notification. ANY OTHER PERSON may appeal within twenty one days beginning on the date of this decision.
- 2. An appeal shall be in writing and shall state the subject matter and grounds of appeal. It should be addressed to:-

An Bord Pleanala, Blocks 6 and 7 Irish Life Centre, Lower Abbey Street, Dublin 1.

- **3.**An appeal lodged by an applicant or his agent with An Bord Pleanala will be invalid unless accompanied by the prescribed fee.
- (a) An appeal against a decision relating to commercial development by the person by whom the application was made must be accompanied by a fee of £100 (one hundred Pounds).
- "Commercial Development" means development for the purposes of any professional, commercial or industrial undertaking, development in connection with the provision for reward of services to persons or undertakings, or development consisting of the provision of two or more dwellings, but does not include development for the purposes of agriculture.
- (b) An appeal other then an appeal mentioned at (a) above, including third party appeal must be accompanied by a fee of £50 (fifty pounds)
- (c) A party to an appeal making a request to An Bord Pleanala for an Oral Hearing of an appeal must, in addition to the prescribed fee, pay to An Bord Pleanala a fee of £50 (fifty pounds).
- (d) A person who is not a party to an appeal must pay a fee of £15 (fifteen pounds) to An Bord Pleanala when making submissions or observations to An Bord Pleanala in relation to an appeal.
- **4.**If the Council makes a decision to grant permission/approval and there is no appeal to An Bord Pleanala against this decision, PERMISSION/APPROVAL will be granted by the Council as soon as may be after the expiration of the period for the taking of such an appeal. If every appeal made in accordance with the Acts has been withdrawn, the Council will grant the PERMISSION/APPROVAL after the withdrawal.
- **5.** Approval of the Council under the Building Bye-Laws must be obtained and the terms of the approval must be complied with in the carrying out of the work before any development which may be permitted is commenced.

Dublin County Council Comhairle Chontae Atha Cliath

Planning Department

Building Control Department, Liffey House, Tara Street, Dublin 1. Telephone:773066



Bloc 2, Ionad Bheatha na hEireann, Block 2, Irish Life Centre, Sraid na Mainistreach lacht, Lower Abbey Street, Baile Atha Cliath 1, Dublin 1. Telephone. (01)724755 Fax. (01)724896

Register Reference : 91A/0927

Date: 30th July 1991

LOCAL GOVERNMENT (PLANNING AND DEVELOPMENT) ACTS, 1963 TO 1990

Dear sir/Madam,

DEVELOPMENT : Office alterations

LOCATION : Unit No. 21, Parkmore Industrial Estate, Dublin 12.

APPLICANT : Dorothy & Paul Ledwidge

APP. TYPE : Additional Information >


With reference to the above, I acknowledge receipt of your application received on 29th July 1991.

Yours	faithfully,	
••••	• • • • • • • • • • • • • • • • • • • •	
for Pi	RINCIPAL OFFICER	

Osborne Associates, The Mews, Kerrymount Avenue, Foxrock.

OSBONE ASSOCIATES, THE MEWS. CHERRYFIELD, KERRYMOUNT AVENUE, FOXROCK, DUBLIN 18 TELEPHONE / FAX 2894585.

> Planning Department Dublin Corporation Irish Life Centre Lr Abbey Street Dublin 1.

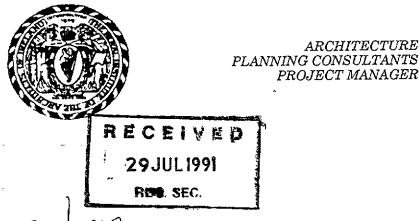

91A 0927 1-4.0. ohr

29.07.1991.

ARCHITECTURE

PROJECT MANAGER

Re: Additional Information Reg.Ref.No. 91A-0927. Proposed Office Alterations to offices at Unit No 21 Parkmore Industrial Estate, Dublin 12 for Dorothy and Paul Ledwidge.

Further to your letter of the 25th July 1991, please find enclosed the following information in quadruplicate as requested.

- 1. Revised Elevations showing alterations to first floor windows . These proposed new windows are identical to the existing window types used in the building.
- 2. A schedule of floor space and proposed alterations.
- 3. A revised newspaper advertisement as requested.

It should be noted that we already supplied additional information in respect of the above. We therefore would be grateful if this application can be dealt with as a matter of urgency as our clients can not move into the building until these matters are dealt with. We can not understand the delays been caused when we offered to readvertise and were told that it was not necessary.

Thanking you for your co-operation in this matter.

øsborne Associates.

DUBLIN COUNTY COUNCIL
Planning permission is
sought for proposed office
caterations to Unit no 21
Parkmore industrial Estate.
Long Mile Road for Dorothy
and Paul Ledwidge

OSBORNE ASSOCIATES Architects, Planning Consultants, Project Managers, Computer Aided Design Consultants.




ARCHITECTURE PLANNING CONSULTANTS PROJECT MANAGER

Schedule of Accommodation.

Ground Floor Existing:	
Entrance Lobby:	100sq.ft.
Lobby Area	70sq.ft.
3 Offices	320sq.ft.
	120sq.ft.
	125sq.ft.
New Warehouse Display	435sg.ft.
Existing Offices Enlarged	365sq.ft.
First Floor	•
First Floor Existing:	
Landing Areas	100sq.ft.
Offices	156sq.ft.
	175sq.ft.
New First Floor Areas	
Landing Area	175sq.ft.
Office and Store	380sq.ft.
Office	280sq.ft.
Warehouse Area	
Existing	2800
Proposed	2000


The total new office space as outlined in our letter fo the 26th June 1991 is approx 134 sq.meters including the fire escape.

Osborne Associates.

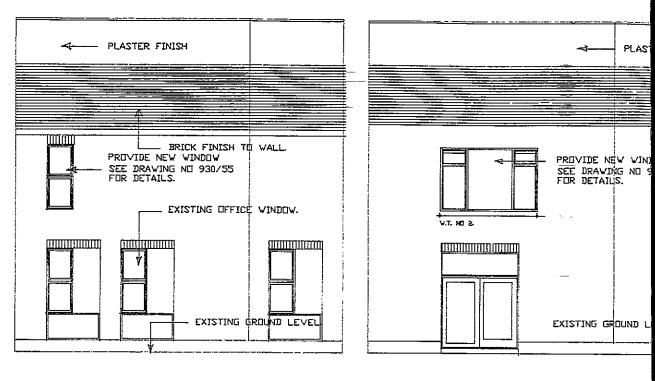


SIDE ELEVATION

ELEVATION TO LON

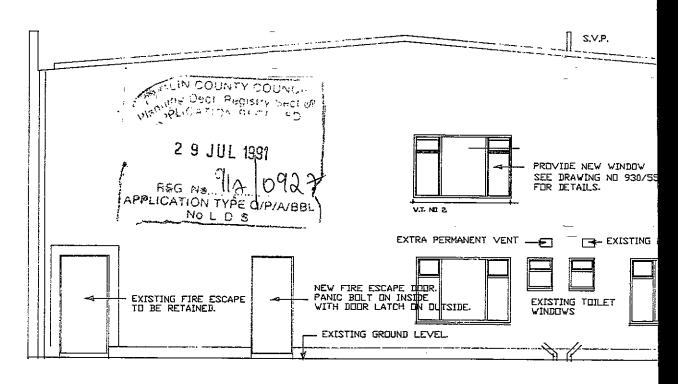



ELEVATION TO INDUSTRIAL ESTATE.

Ž

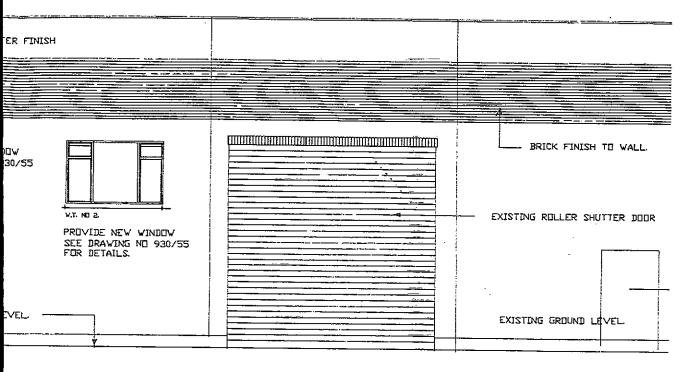

MILE ROAD. SCALE $1/8\overline{=1'=0''}$.

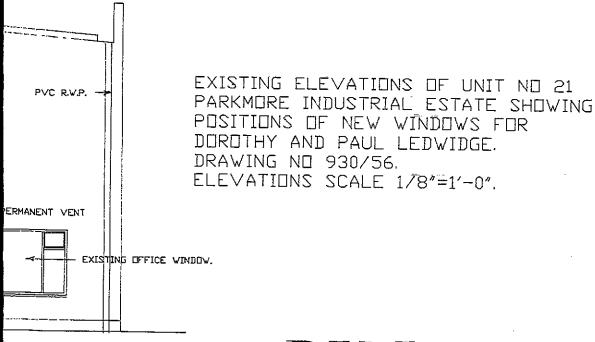

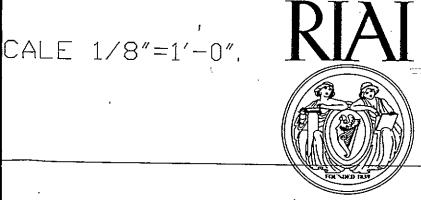

Osborne Architecture Planning Project Management

Kerrymount Avenue Foxrock Dublin 18.

Osborne Associates, The Mews, Kerrymount Avenue, Foxrock. Reg. Ref. 91A-0927

25 July 1991

Re:

Proposed office alterations to unit no. 21, Parkmore Industrial Estate, Longmile Road for Dorothy & Paul Ledwidge.

Dear Sir/Madam,

With reference to your planning application, received here on 29th May, 1991, in connection with the above, I wish to inform you, that before the application can be considered under the Local Government (Planning and Development) Acts, 1963-1983, the following additional information must be submitted in quadruplicate:-

- 1. The proposed development includes provision for first floor window openings which are not consistent with the design and scale of first floor window openings on the adjoining premises. The applicant is requested to submit revised proposals which would maintain the overall design character of the complex as a whole.
- 2. The applicant is requested to clarify the scale and proposed use of this industrial unit by providing a full schedule of existing floor space use and proposed use for the entire premises.

(Continued)

3. In view of the fact that the site is located within the jurisdiction of Dublin County Council a revised newspaper advertisement is required seeking permission from Dublin County Council.

Applicant is requested to submit a revised notice with the heading "Dublin County Council."

Please mark your reply "ADDITIONAL INFORMATION" and quote the Reg. Ref. No. given above.

Yours faithfully,

for Principal Officer.

OSBORNE ASSOCIATES. MEWS, CHERRYFIELD. KERRYMOUNT AVENUE, FOXROCK, **DUBLIN 18** TELEPHONE / FAX 2894585.



ARCHITECTURE PLANNING CONSULTANTS PROJECT MANAGER

1.0.0

26.06.1991.

Planning Department Dublin County Council Irish Life Centre Lr Abbey Street Dublin 1.



Att:Niall Byrne Esq.

Re: Application for alterations to offices at Unit No 21 Parkmore Industrial Estate, Dublin 12 for Dorothy and Paul Ledwidge.

Further to the above and our telephone conversation today, please find enclosed the following documentation for clarifying the full extent of the office area for planning permission.

2 8. JUN Ground Floor Existing: 100sq.ft. Entrance Lobby: Lobby Area 72sq.ft. 321.875 25'-10".12'-5" 3 Offices 9'-4".13'-0" 120.9 15'-5".8'-0" 124.8 New Ground Floor Office 13'-5:.32'-0" 435.2 First Floor Existing: Landing Areas 16'-9".10'-6". Offices 175.875 13'-0".12'-0" 156 New First Floor Areas 16'-9".10'-6" 175.875 Landing Area 13'-3".29'-0" 384.25 Office and Store 283.5 27'-0".10'-6" Office 843.625 161. Fire Escape.

The total new office area is 134.34sq.m

Many thanks for your kind co-operation in this matter.

Osborne Associates. OSBORNE ASSOCIATES

& Osisome

Architects, Planning Consultants, Project Managers, Computer Aided Design Consultants.

OSBORNE ASSOCIATES OF THE MEWS, CHERRYFIELD, KERRYMOUNT AVENUE, FOXROCK, DUBLIN 18
TELEPHONE / FAX 2894585.





ARCHITECTURE PLANNING CONSULTANTS PROJECT MANAGER

Planning Department
Dublin Corporation
Irish Life Centre
Lr Abbey Street
Dublin 1.



14.06.1991.

Att:Richard Whelan Esq.
Re: Application for alterations to offices at Unit No 21
Parkmore Industrial Estate, Dublin 12 for Dorothy and
Paul Ledwidge.

Further to the above, please find enclosed the following documentation for clarifying the full extent of the office area for planning permission. We have outlined the area in red and have measured the areas involved. The total new office area is 134.34sq.m rather than the 205sq.m we first calculated.

Please find enclosed the following documentation :-

Plan. Location No 91/61/01. of Drawing 1 Copies Site Plan. No 91/61/02. 1 Copies of Drawing Ground Floor Plan. No 91/61/03. Drawing 1 Copies of First Floor Plan. of No 91/61/04. Drawing 1 Copies Penthouse. No 91/61/05. 1 Copies \mathbf{of} Drawing Front Elevation. No 91/61/06. of Drawing 1 Copies Rear Elevation. No 91/61/07. of Drawing 1 Copies Cross-section. No 91/61/08. of Drawing 1 Copies No 91/61/09. Entrance details. of Drawing 1 Copies

Many thanks for your kind co-operation in this matter.

910/092

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- 1 ·

Associates.


OSBORNE ASSOCIATES

Architects, Planning Consultants, Project Managers, Computer Aided Design Consultants.

Assembly Works 8 M 45 GE LONG SITE. PARKMORE INDUSTRIAL ESTATE Warehouses Industrial/ Estate Warehouses

LOCATION PLAN.


918/0927 12/0921

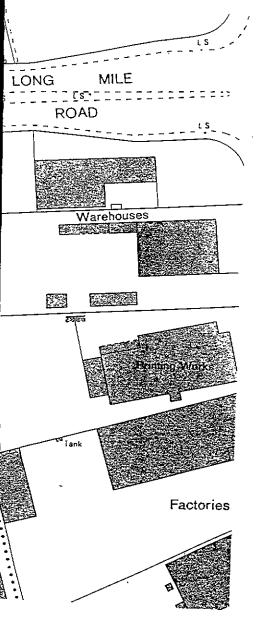



Osborne Architecture Planning Project Management

Kerrymount Avenue Foxrock Dublin 18.

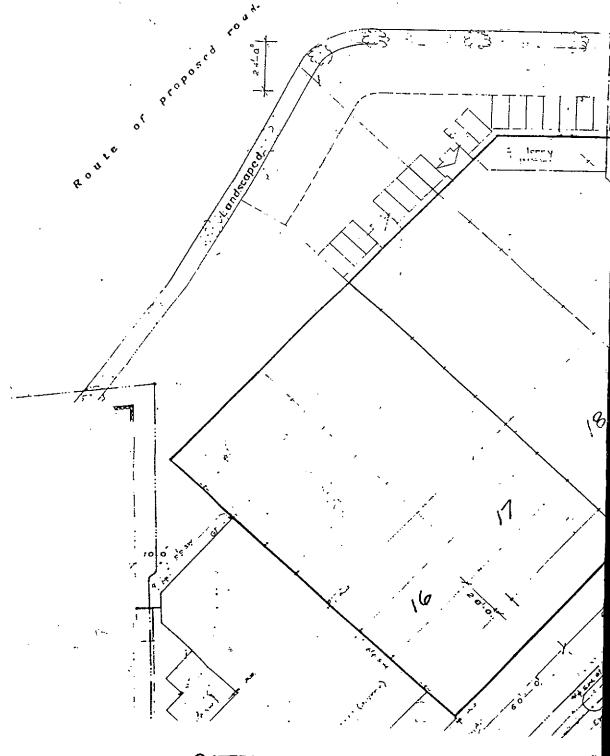

SITE PLAN.

1:500

7/6/9) 9/1/0927 1-10-0


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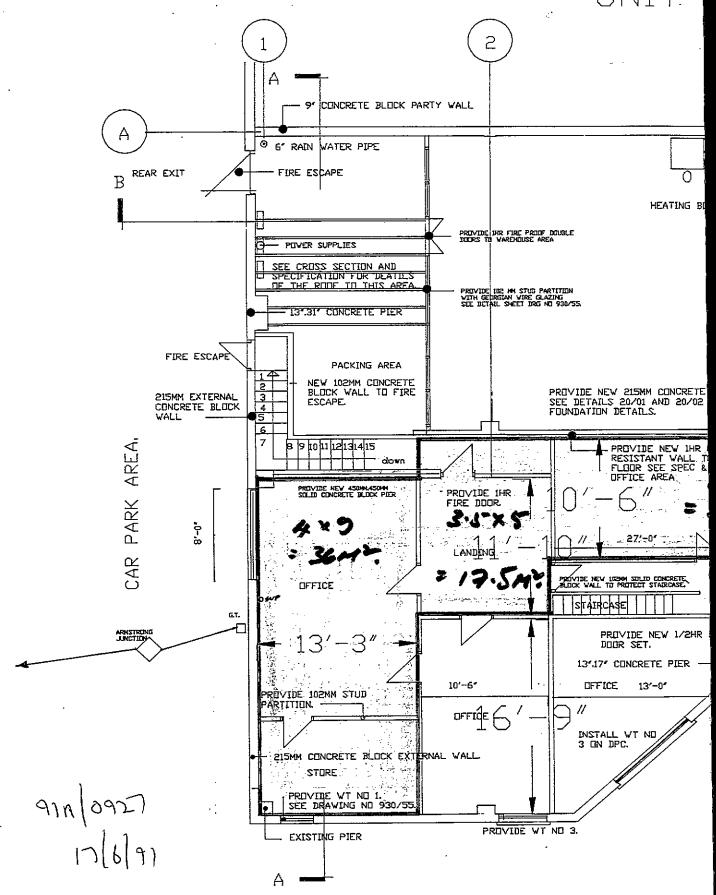



Osborne Architecture Planning Project Management


Kerrymount Avenue Foxrock Dublin 18.

UNIT



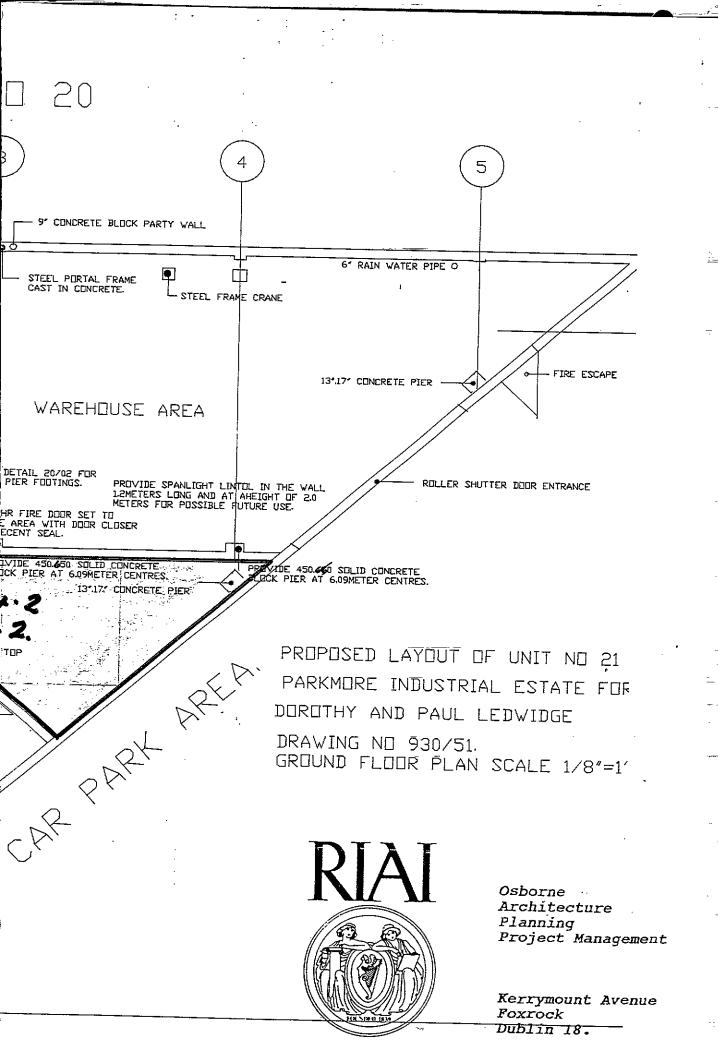


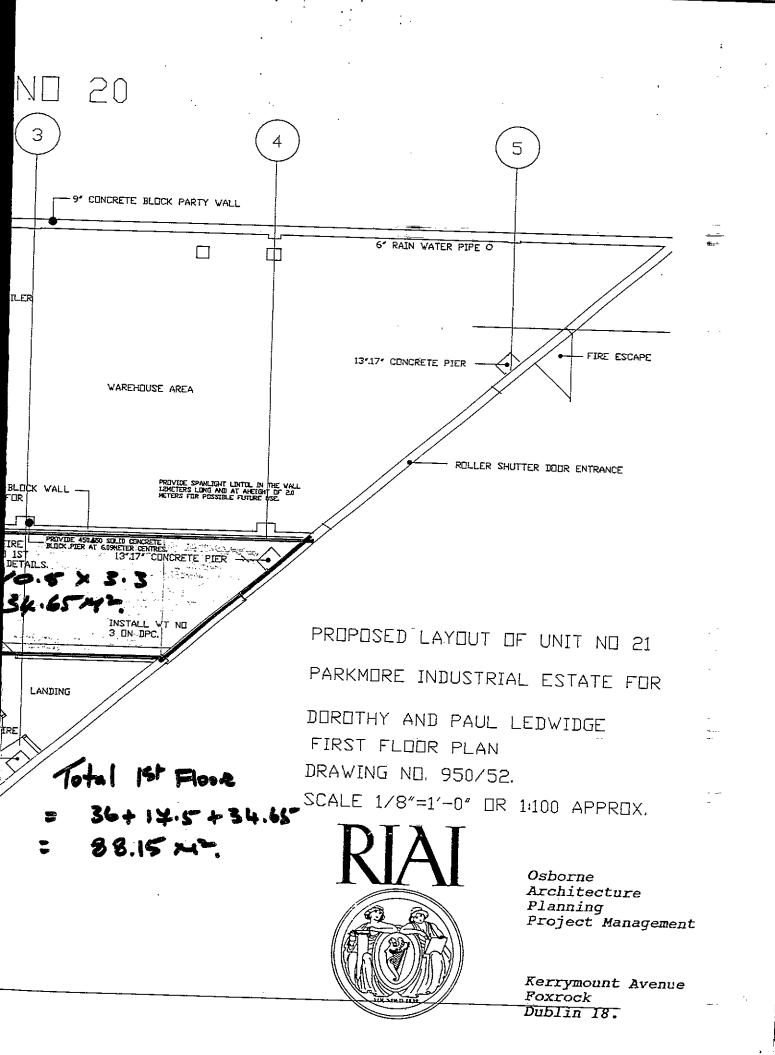

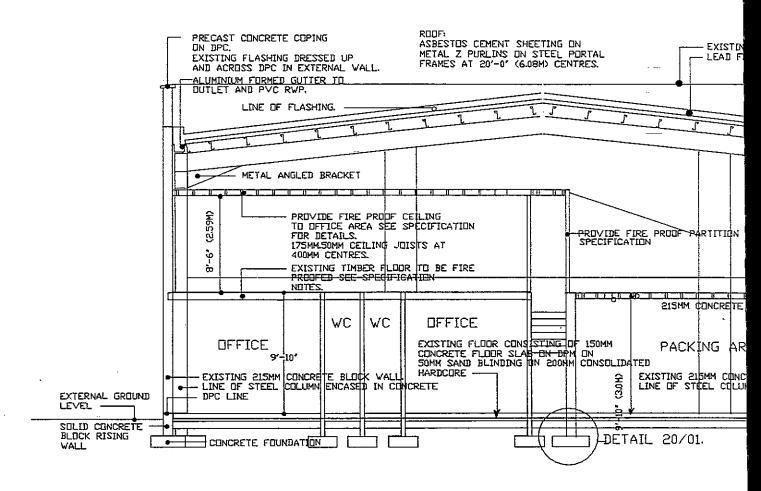

CROSS-SECTION B-B THROUGH UNIT NO 21 PARKMORE INDUS

91x/0927 17/6/91

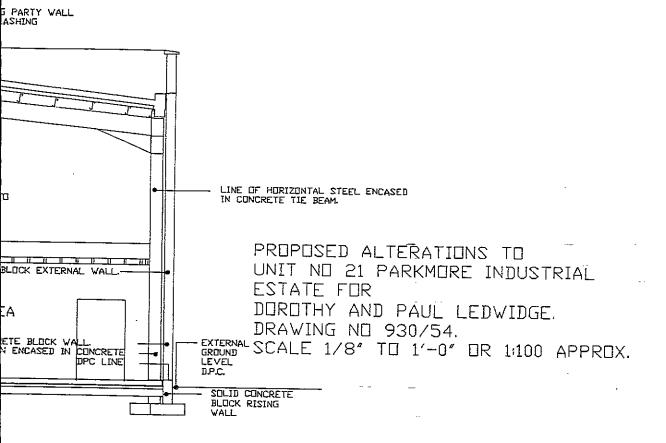


TRIAL ESTATE.




Osborne Architecture Planning Project Management

Kerrymount Avenue Foxrock Dublin 18.

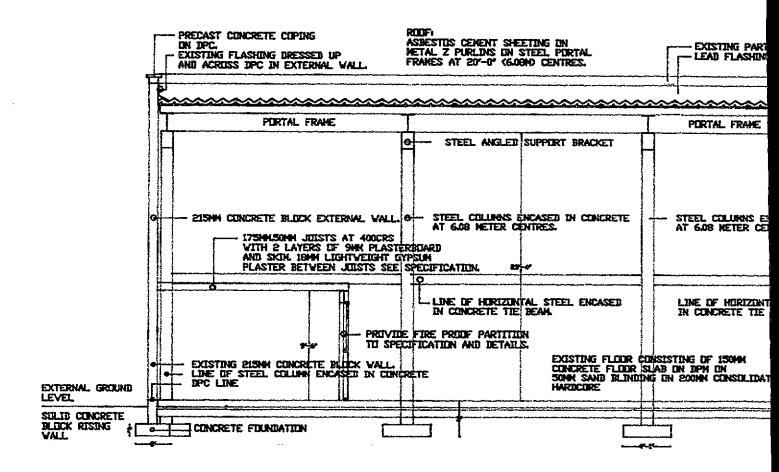

CROSS-SECTION A-A THROUGH UNIT NO 21 PARKN

910/0927 17/6/91 Y WALL

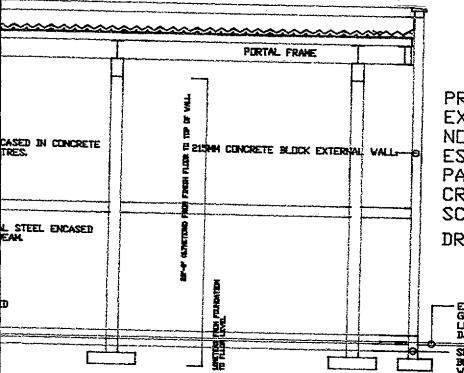

PROPOSED ALTERATI EXISTING OFFICES A NO 21 PARKMORE INI ESTATE FOR DOROTH PAUL LEDWIDGE. CROSS-SECTION A-A SCALE 1/8' TO 1'-0' DRAWING NO. 930/53


- EXTERNAL GROUND LEVEL DP.C.

SOLID CONCRETE BLOCK RISING VALL

ORE INDUSTRIAL ESTATE.




Osborne Architecture Planning Project Management

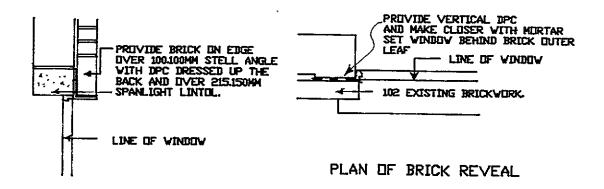

SECTION OVER BRICK HEAD

CILL DETAIL FOR BRICK THE SAME AS CROSS-SECTION EXCEPT ALLOW FOR EXTRA DEPTH BEHIND THE DPC.

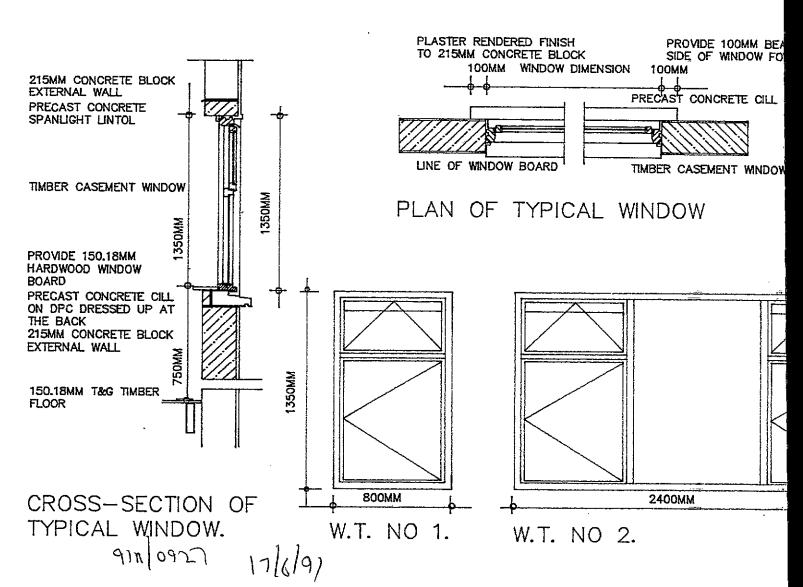


WINDOW DETAILS FOR UNIT NO 21 PARKMO DRAWING NO 930/55.

SPECIFICATION NOTES: -

RING EITHER CILL ON DPC.

N DPC

ALL SPANLIGHT LINTOLS ARE TO HAVE A MINIMUM BEARING OF 100MM EITHER SIDE OF WINDOW OPENING.
A DPC MOVEMENT JOINT IS TO BE INSERTED ABOVE THE SPANLIGHT LINTOL IN ALL CASES. THE WINDOWS ARE TO BE ERECTED ON A PRECAST CONCRETE CILL WITH A DPC UNDER AND DRESSED UP AT THE BACK OF THE CILL. A CONCRETE FILLET TO THE VERTICAL DPC AT THE BACK OF THE CILL. IS TO BE INSERTED.
A WINDOW BOARD IN HARDWOOD IS TO BE INSERTED ON TIMBER GROUNDS.
THE PRECAST CONCRETE CILL IS TO EXTEND 100MM ON EITHER SIDE OF THE OPENING OPENING. 100MM ON EITHER SIDE OF THE OPENING AND THE EXTERNAL FINISH IS TO BE MADE GOOD.

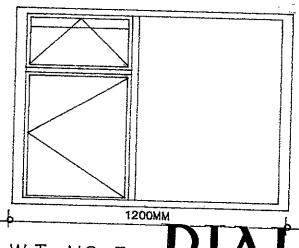



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Osborne Architecture Planning Project Management







SIDE ELEVATION

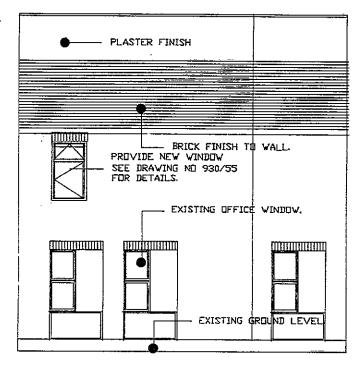ELEVATION TO CONG M

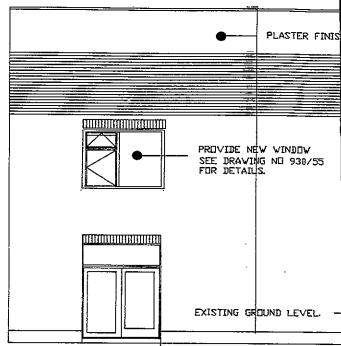
SCAL

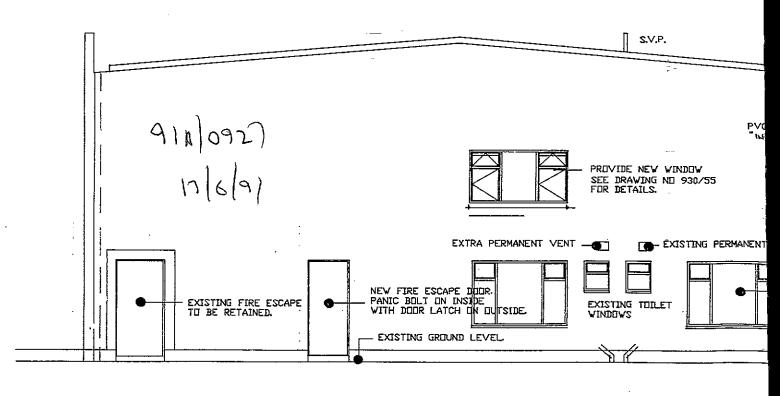

ELEVATION TO INDUSTRIAL ESTATE -

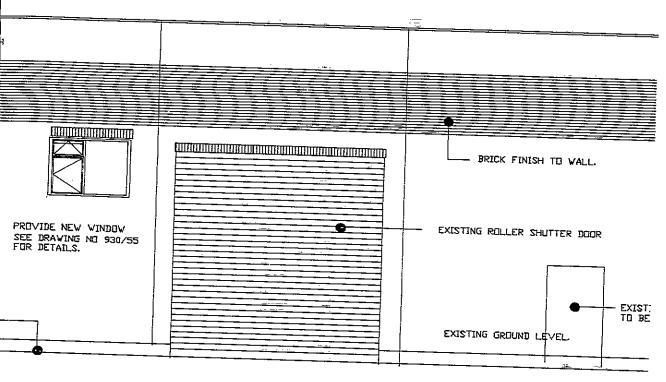

ILE ROAD. SCALE 1/8''=1'=0''.

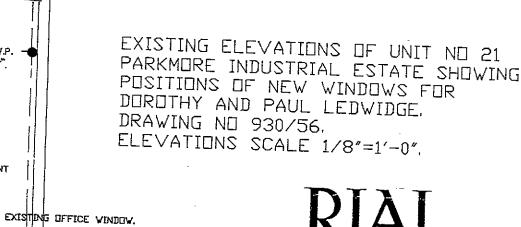




Osborne Architecture Planning Project Management

Kerrymount Avenue Foxrock
Dublin 18.

1/8"=1'-0".

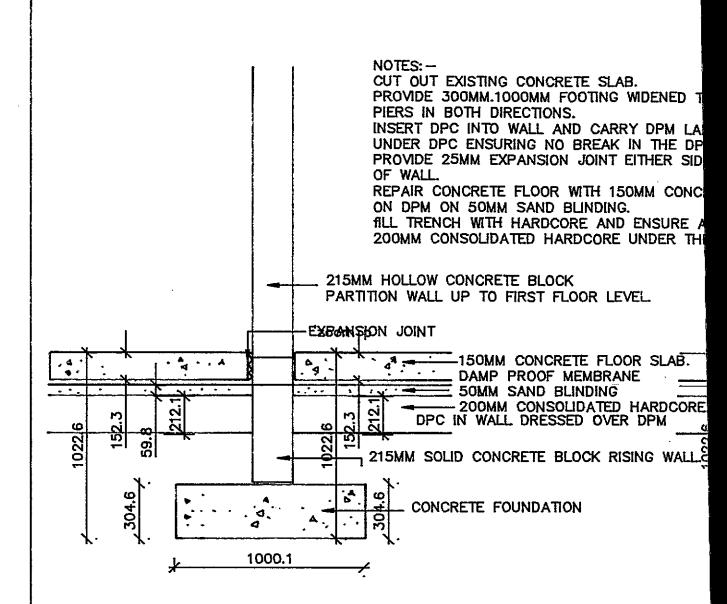


SECTION THROUGH 215MM

911/092 CONCRETE DIV G WALL

17/6/9)


FOOTING DETAILS FOR UNIT NO 21 PDRAWING NUMBER 950/56.

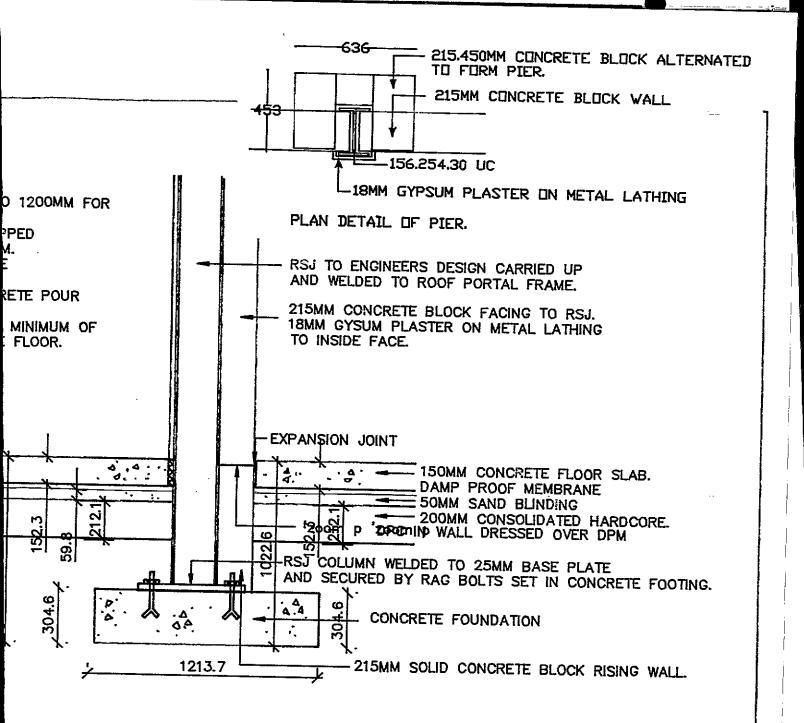

SECTION THROUGH RSJ COLUMN FORMING PIER TO ENGINEERS SPECIFICATION.


Osborne Architecture Planning Project Management

ARKMORE INDUSTRIAL ESTATE

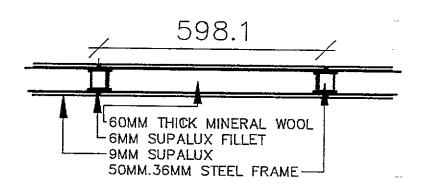

PLAN DETAIL OF FIRE PROOF PARTITION.

17/6/97

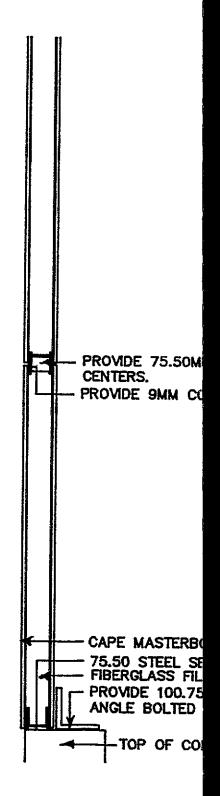

CROSS SECTION O PARTITION AT TOP M STEEL CHANNEL AT 1.2 METERS

VER PIECES TO CHANNEL IN MASTERBOARD. (SUPAWK).

DARD FIRE PROOF LINER (SMM SUPALUX).
CTIONS
LING COMPRESSED FROM 100MM.
GALVANISED STEEL
TO FLOOR.

ICRETE BLOCK WALL

F FIRE PROOF OF 215MM WALL.



Osborne Architecture Planning Project Management

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2 CAPEL STREET, DUBLIN 1, IRELAND Telephone: 722744, 730661 Fax: 722196



Distributors to the Trade of Telecommunication Equipment, Car Stereo & Home/Auto Alarm Systems

With Compliments The Orlinador Grunuation

Dublin County Council Comhairle Chontae Atha Cliath

Planning Department



Building Control Department, Liffey House, Tara Street, Dublin 1. Telephone:773066 Bloc 2, Ionad Bheatha na hÉireann, Block 2, Irish Life Centre, Sraid na Mainistreach Iacht, Lower Abbey Street, Baile Atha Cliath 1. Dublin 1. Telephone. (01)724755 Fax. (01)724896

Register Reference: 91A/0927

Date: 5th June 1991

LOCAL GOVERNMENT (PLANNING AND DEVELOPMENT) ACTS, 1963 TO 1990

Dear Sir/Madam,

DEVELOPMENT : Office alterations

LOCATION : Unit No. 21, Parkmore Industrial Estate, Dublin 12.

APPLICANT : Dorothy & Paul Ledwidge

APP. TYPE : PERMISSION/BUILDING BYE-LAW APPROVAL

With reference to above, I acknowledge receipt of your application received on 29th May 1991.

Yours faithfully,
•••••
PRINCIPAL OFFICER

Osborne Associates, The Mews, Kerrymount Avenue, Foxrock.

DUBLIN CORPORATION



PLANNING APPLICATION FORM

	\	PLEASE READ INS	TRUCTIONS AT BACK BE	FORE COMPLETING FO	BM - ALL OUESTIÖNS MI	LIST DE ANGWEDED
	,	Application for P	Permission Outline Permission Description Outline Permission Description of the Permission of the Perm	ermission	Place / in appropri	ate box
	_	<u> </u>		To the second se	· · · · ·	· · · · · · · · · · · · · · · · · · ·
	_	f none, give descript sufficient to identify	e or BuildingUNITV tion /)VONG	MILE ROAD	DUBLIN 12	ESTATE
V			rincipal not Agent)Dog			***************************************
		4. Name and address of	GH LUCAN RD COBORNE	ACCOUNTED	Tel. No6X	.625.48
		person or firm respon for preparation of dra	sible awings KERRYM	OUNT AVENUE	FOROCKTEL No. 2.8	530585
	į	5. Name and address to notifications should b	which AS 4	ABOVE.	, G. 100.	***************************************
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		7 11	PARKUO	<u> </u>		<u> </u>
	·	(a) Present use of eac	ilding or buildings to be retained the floor	ained on site, please state:	LOUICE BYE LAV	V APPLICATION
						OLL
D			each floorTHE		·	· · · · · · · · · · · · · · · · · · ·
∢ > .		8. Does the proposal inve of an	olve demolition/partial dem ny habitable house or part th	olition nereof ?No.		
	9	9. (a) Area of Site	management of the second	loce	, and the same of	Some
			BLIN 12 Planning permis- on is sought from Dublin proporation for office altera- ons to unit no. 21.	200	± 1 € •	NIC m
		_ a i	ngmile Road for Dorothy Paul Ledwidge	d within site	Total.	5g. <u>m.</u>
		O.State applicant's legar		, freehold, leasehold etc.)	The second second	
	11	I.Are you now applying	also for an approval under t	the Building Bye Laws? Y	es No Place / in	appropriate box
		Please state the extent	to which the Draft Building	Regulations have been tak	en into account in your pr	oposal:
		NEOFAR AG	THEY APPLY TO	WEW DEVELOP	MENT	
	13.	List of documents enck application.	osed with LL COPIE			OURED
			LETTER	# APPLICATION	+ UEWSPAPER	. Notice.
	14.	Gross floor space of pro	oposed development (See Based (if any)	ick)	ent H + C	Sq. m.
		,	5Basis of Calculation,			26= EH360
		If a reduced fee is tend	ered details of previous rele	vant payment should be gi	ven = £1076.2	5
		Signature of Applicant	(or his Agent)	Sloome	Date 29.5.19	91.
		Plan No	PB 1 FOR	OFFICE USE ONLY	2 40 44	· ·
		History	= 91B 10927 PH	10 10 25/5 11 - 0.05 on		2 9. MAY 91
		Amount Received £71	7.5060 0	pia reliva	nons /	Market Property
		Receipt No	2 116/7	18-13	***	

LOCAL GOVERNMENT (PLANNING & DEVELOPMENT) REGULATIONS 1977 TO 1984.

Outline of requirements for applications for permission or Approval under the Local Government (Planning & Development) Acts 1963 to 1983. The Planning Acts and Regulations made thereunder may be purchased from the Government Publications Sales Office, Sun Alliance House, Molesworth Street, Dublin 2.

- 1. Name and Address of applicant.
- 2. Particulars of the interest held in the land or structure, i.e. whether freehold, leasehold, etc.
- 3. The page of a newspaper, circulating in the area in which the land or structure is situate, containing the required statutory notice. Alternatively, a copy of the notice as erected or fixed on the land or structure as required by article 16 of the permission regulations. The newspaper advertisement should state after the heading "DUBLIN" (with postal district no:)
 - (a) The address of the structure or the location of the land.
 - (b) The <u>nature</u> and <u>extent</u> of the <u>development</u> proposed. If retention of development is involved, the notice should be worded accordingly. Any demolition of habitable accommodation should be indicated.
 - (c) The name of the applicant.

Applications must be received within 2 weeks from date of publication of the notice. (Advertisements acceptable in the following newspapers only:- Irish Independent, Irish Press, Irish Times, Evening Herald, Evening Press, Sunday Independent, Sunday Press, Sunday World, Sunday Tribune).

- 4. Four (4) sets of the drawings to a stated scale must be submitted. Each set to include a layout or block pean, location map, and drawings of relevant floor plans, elevations, sections and such other particulars as are necessary to identify the land and to describe the works or structure to which the application relates (new work to be coloured or otherwise distinguished from any retained structures). Buildings, roads, boundaries and other features bounding the structure or other land to which the application relates shall be shown on site plans or layour plans. The location map should be of a scale not less than 1:2500 and should indicate the north point. The site of the person by whom they were prepared. Any adjoining lands in which the applicant has an interest must be outlined in blue.
- 5. In the case of a proposed change of use of any structure or land, requirements in addition to 1, 2 & 3 are:
 - (a) a statement of the existing use and the proposed use, or, where appropriate, the former use and the use proposed.
 - (b) (i) Four (4) sets of the drawings to a stated scale must be submitted. Each set to consist of a plan or location map (marked or coloured in red so as to identify the structure or land to which the application refresh to a scale of not less than 1:2500 and to indicate the North point. Any adjoining lands in which the applicant has an interest must be outlined in blue.
 - (ii) A layout and a survey plan of each floor of any structure to which the application relates.
 - (c) Plans and drawings should indicate the name and address of the person by whom they were prepared.
- Applications should be addressed to: Dublin Corporation, Planning Department, Irish Life Centre, Lr. Abbey St., Dublin 1. Tel. No. 724755.

SUMMARY OF CLASSES OF DEVELOPMENT/ FEES *

CLASS NO.	DESCRIPTION	FEE
1.	Provision of dwelling - House/Flat	£32,00 each
2.	Domestic extensions/other improvements	£16,00 each
3.	Provision of agricultural buildings (See Regs.)	£40.00 minimum
4.	Other buildings (i.e. office, commercial, etc)	£1.75 per sq. metre (Minimum £40.00)
5.	Use of land (Mining, deposit of waste)	£25.00 per 0.1 hectare (Min. £250.00)
6.	Use of land (Camping, parking, storage)	£25,00 per 0.1 hectare (Min. £40,00)
7 . '	Provision of plant/machinery/tank or other	
,	structure for storage purposes.	£25.00 per 0.1 hectare (Min. £100.00)
8.	Petrol filling station	£100.00
9.	Advertising structures	£10.00 per sq. metre (Min. £40.00)
10.	Electricity transmission lines	£25.00 per 1,000 m. (Min. £40.00)
11.	Any other development	£5.00 per 0.1 hectare (Min. £40.00)

^{*} For full details of fees and exemptions see Local Government (Planning and Development) (Fees) Regulations 1984.


Cheques etc. should be made payable to: Dublin Corporation.

Gross Floor space is to be taken as the total floor space on each floor measured from the miside of the external walls.

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29MAY1991

REG. SEC

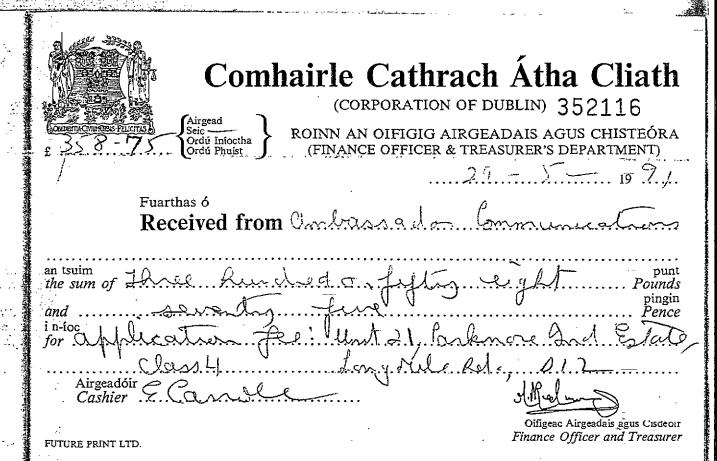


OSBORNE ASSOCIATES, THE MEWS. HERRYFIELD, KERRYMOUNT AVENUE, FOXROCK, DUBLIN 18 TELEPHONE / FAX 2894585.



ARCHITECTURE PLANNING CONSULTANTS PROJECT MANAGER

Planning Department Dublin Corporation Irish Life Centre Lr Abbey Street Dublin 1.

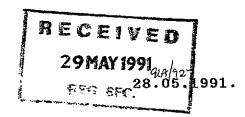

Re: Application for alterations to offices at Unit No 21 Parkmore Industrial Estate, Dublin 12 for Dorothy and Paul Ledwidge.

Further to the above, please find enclosed the following documentation for full planning permission.

- 4 Copies of Drawing No 930/49 Location Plan.
- 4 Copies of Drawing No 930/50 Site Plan.
- 4 Copies of Drawing No 930/51 Ground Floor Plan.
- 4 Copies of Drawing No 930/52 First Floor Plan. 4 Copies of Drawing No 930/53 Section A-A.
- 4 Copies of Drawing No 930/54 Section B-B.
- 4 Copies of Drawing No 930/55 Window Details.
- 4 Copies of Drawing No 930/56 Elevations. 4 Copies of Drawing No 930/57 Footing and Wall Details.
- 4 Copies of Drawing No 930/58 Fire Proof Partition.
- 4 Copies of the Specification.
- 4 Copies of the Structural Calculations.

One Completed Application Form.

Newspaper Notice Dated the 25th May 1991, The Irish Press.

A cheque for £1,076.25.

Our Clients are presently in over crowded rented accommodation belonging to Dublin Corporation and are anixous to move as soon as possible and wish to have particularly the fire proofing of these office done. We therefore would appreciate that if their should be any difficulty with any aspect of this application that we should be consulted immediately.

Osborne Associates.


OSBORNE ASSOCIATES


Architects, Planning Consultants, Project Managers, Computer Aided Design Consultants.

Assembly Works (Motor) BM 45 66 LONG ROAD SITE. PARKMORE INDUSTRIAL ESTATE Warehouses Industrial/ **Estate** Warehouses

LOCATION PLAN.


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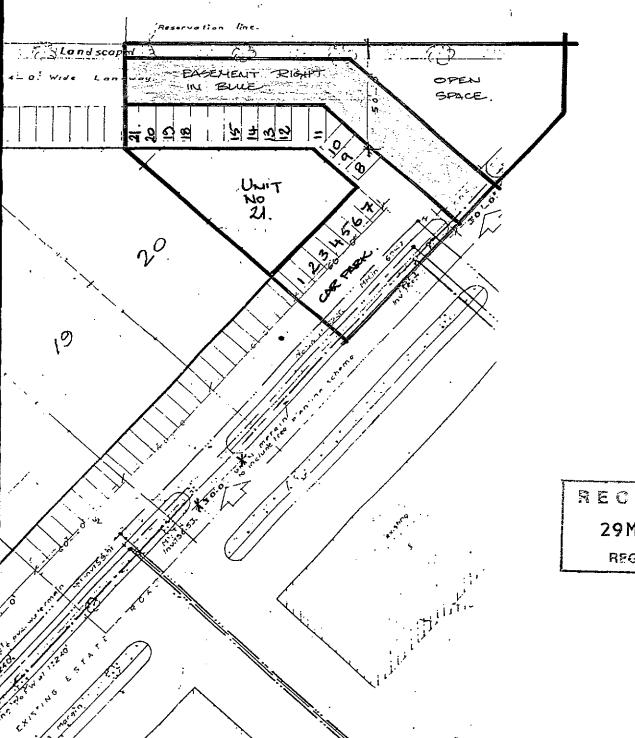


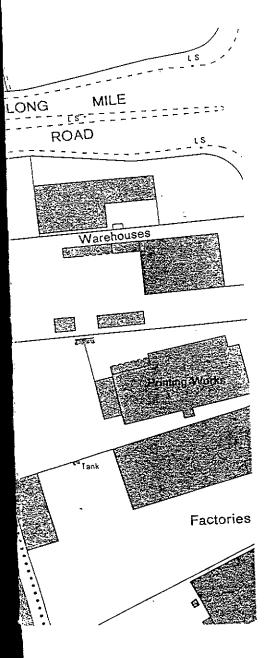Osborne Architecture Planning Project Management

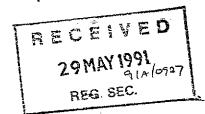

SITE PLAN.

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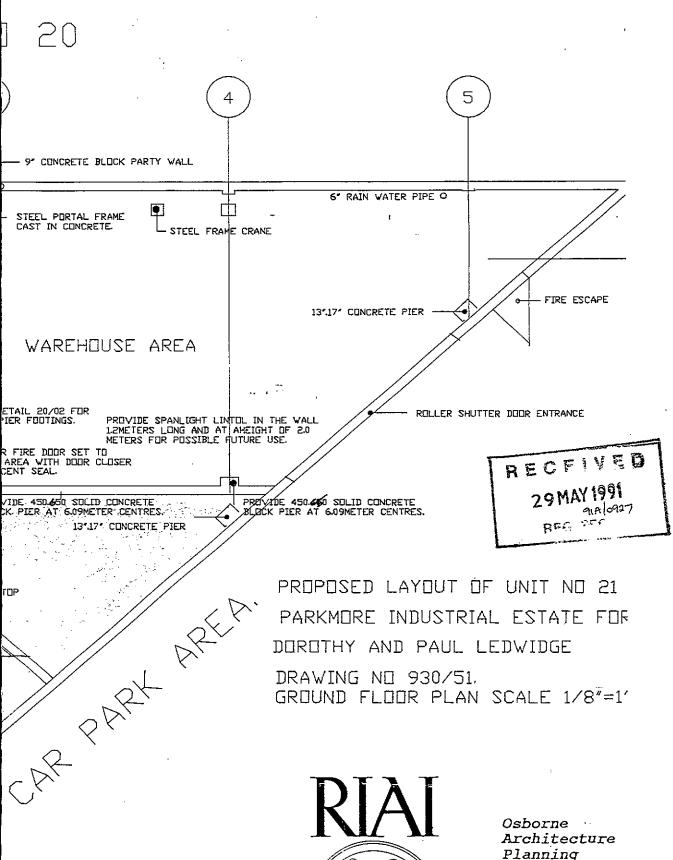
29 MAY 1991

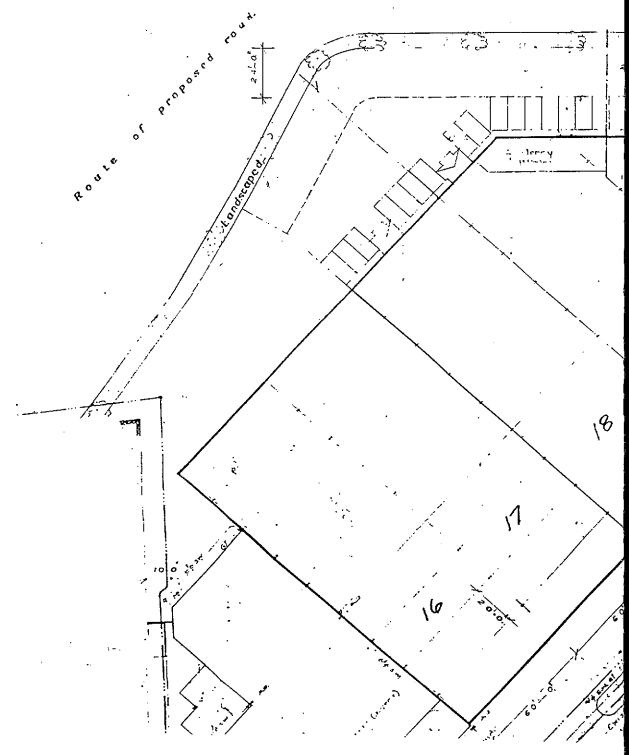REG SEC


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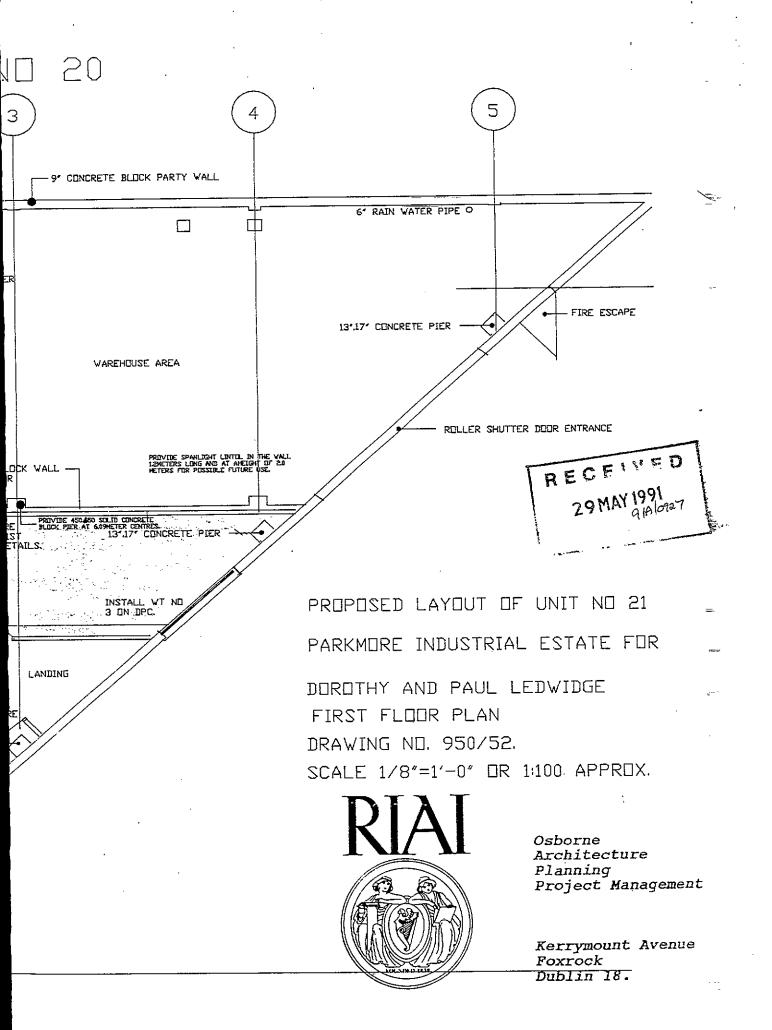



Osborne Architecture Planning Project Management



Planning Project Management



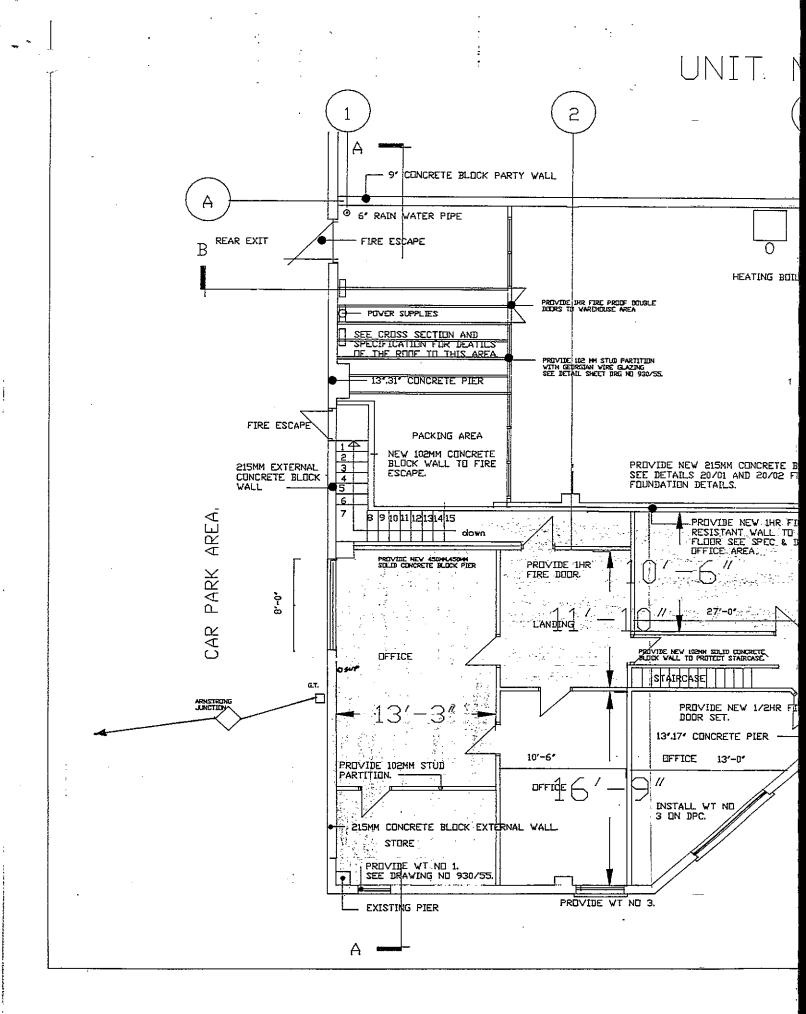

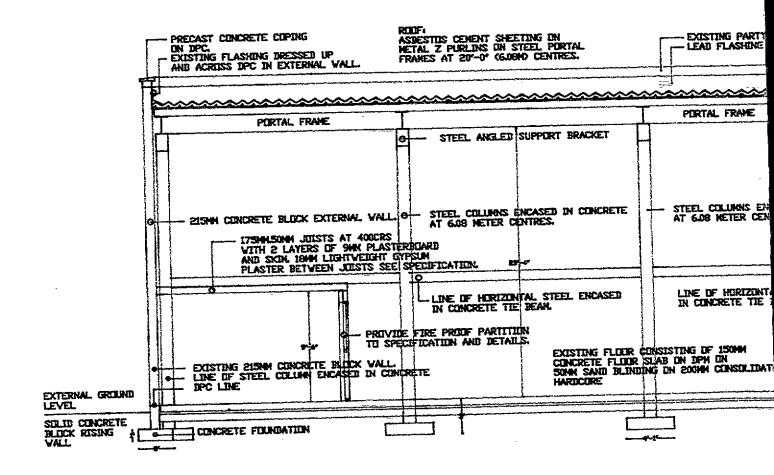


CROSS-SECTION A-A THROUGH UNIT NO 21 PARKI

10RE INDUSTRIAL ESTATE.




Osborne Architecture Planning Project Management

SOLID CONCRETE BLOCK RISING VALL

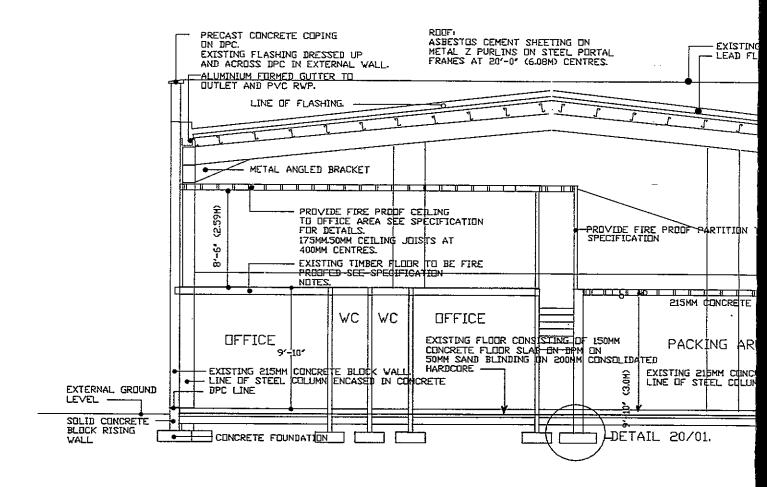


CROSS-SECTION B-B THROUGH UNIT NO 21 PARKMORE INDUS

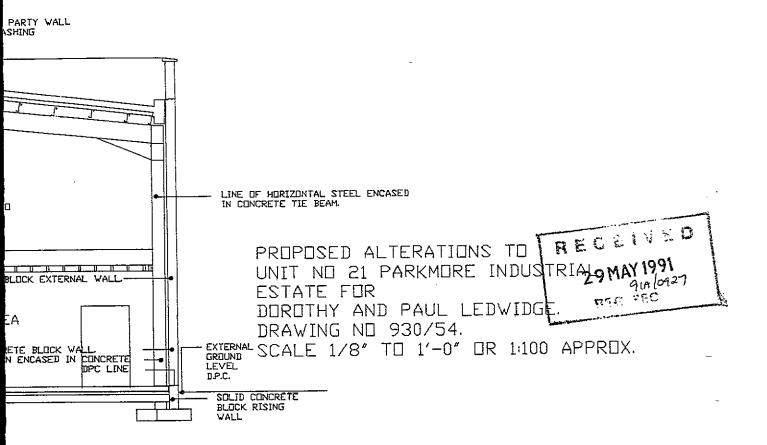


STRIAL ESTATE.



Osborne Architecture Planning Project Management

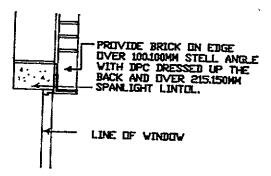


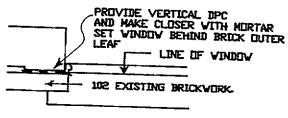

PLAN OF BRICK REVEAL

SECTION OVER BRICK HEAD

CILL DETAIL FOR BRICK THE SAME AS CROSS-SECTION EXCEPT ALLOW FOR EXTRA DEPTH BEHIND THE DPC.

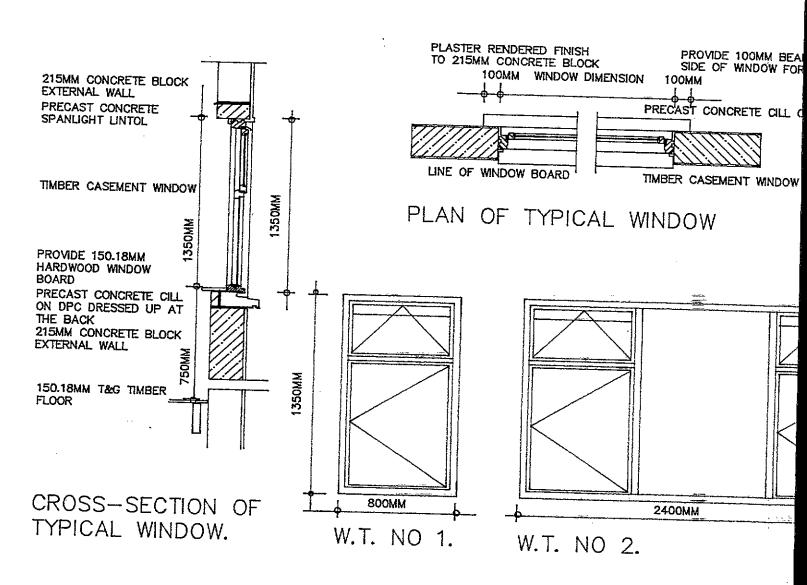

WINDOW DETAILS FOR UNIT NO 21 PARKMONDRAWING NO 930/55.

SPECIFICATION NOTES: -


RING EITHER CILL ON DPC.


N DPC


ALL SPANLIGHT LINTOLS ARE TO HAVE A MINIMUM BEARING OF 100MM EITHER SIDE OF WINDOW OPENING. A DPC MOVEMENT JOINT IS TO BE INSERTED ABOVE THE SPANLIGHT LINTOL IN ALL CASES.
THE WINDOWS ARE TO BE ERECTED ON A PRECAST CONCRETE CILL WITH A DPC UNDER AND DRESSED UP AT THE BACK OF THE CILL. A CONCRETE FILLET TO THE VERTICAL DPC AT THE BACK OF THE CILL IS TO BE INSERTED. A WINDOW BOARD IN HARDWOOD IS TO BE INSERTED ON TIMBER GROUNDS.

THE PRECAST CONCRETE CILL IS TO EXTEND 100MM ON EITHER SIDE OF THE OPENING

AND THE EXTERNAL FINISH IS TO BE MADE GOOD.

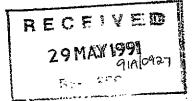

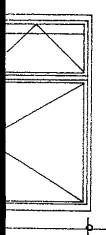

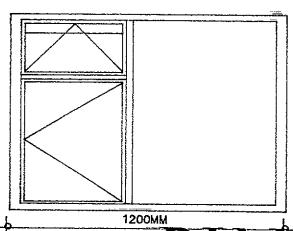



W.T. NO 3.

INDUSTRIAL




Osborne Architecture Planning Project Management

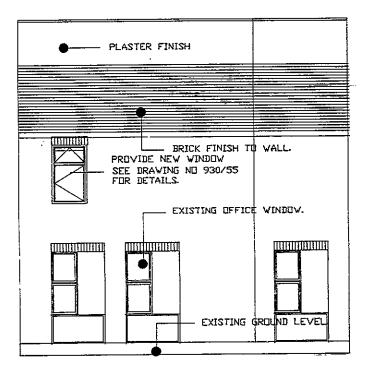

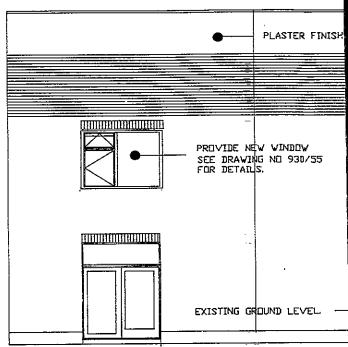


SIDE ELEVATION

ELEVATION TO LONG M

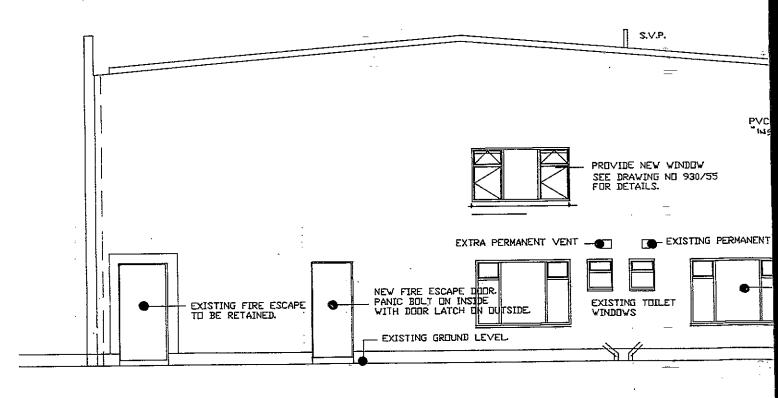

ELEVATION TO INDUSTRIAL ESTATE


SCAL

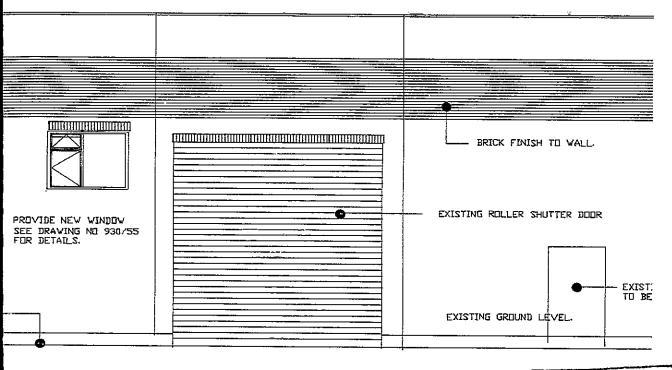

ILE ROAD. SCALE 1/8"=1'=0".

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29 MAY 1991
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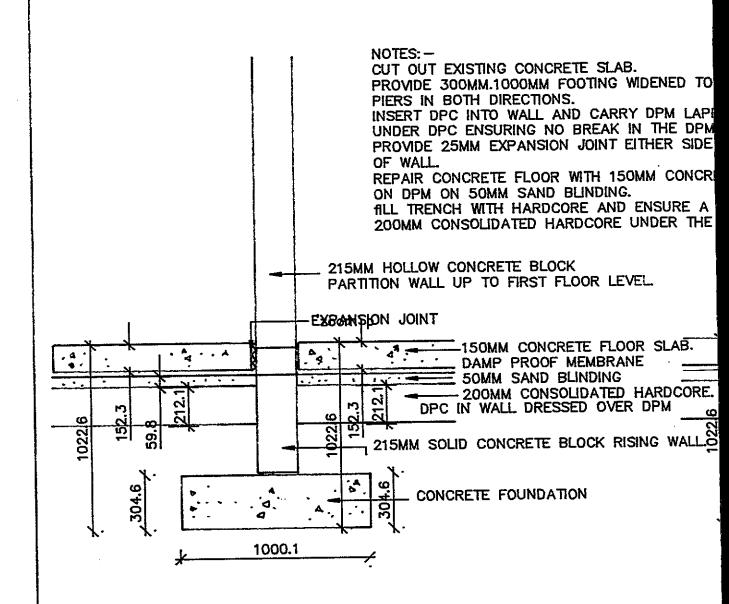
EXISTING ELEVATIONS OF UNIT NO 21 PARKMORE INDUSTRIAL ESTATE SHOWING POSITIONS OF NEW WINDOWS FOR DOROTHY AND PAUL LEDWIDGE. DRAWING NO 930/56. ELEVATIONS SCALE 1/8"=1'-0".

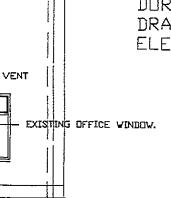

E 1/8"=1'-0".




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SECTION THROUGH 215MM CONCRETE DIV G WALL


FOOTING DETAILS FOR UNIT NO 21 P. DRAWING NUMBER 950/57.




SECTION THROUGH RSJ COLUMN FORMING PIER TO ENGINEERS SPECIFICATION.

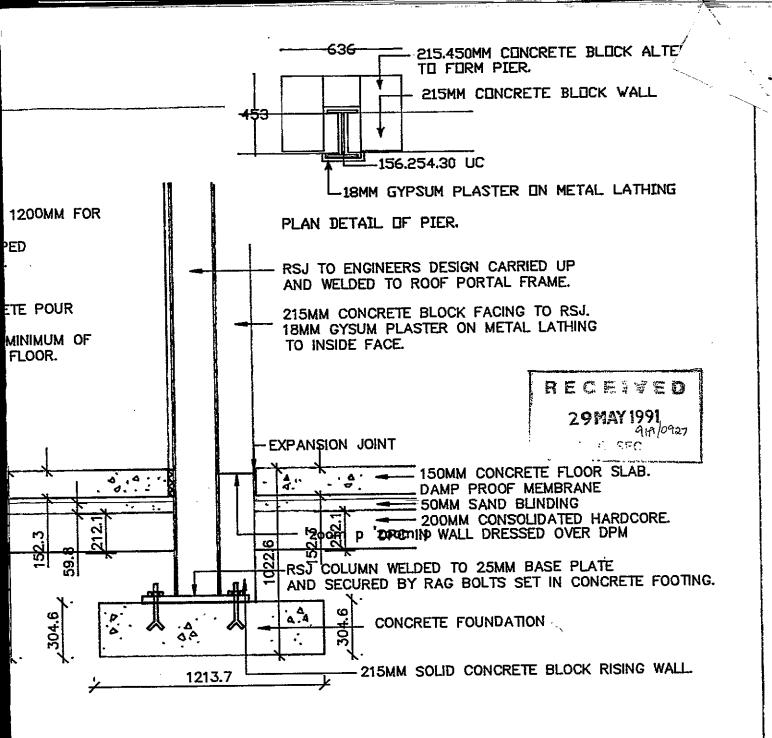Osborne Architecture Planning Project Management

ARKMORE INDUSTRIAL ESTATE

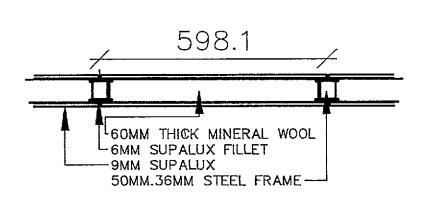

PLAN DETAIL OF FIRE PROOF PARTITION.

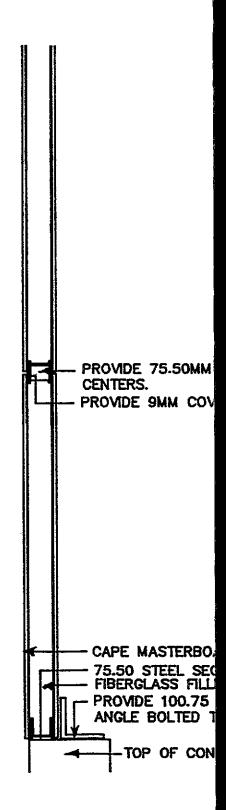

CROSS SECTION OF PARTITION AT TOP

STEEL CHANNEL AT 1.2 METERS

ER PIECES TO CHANNEL IN MASTERBOARD. (SUPAWK).



ARD FIRE PROOF LINER (SMM SUPALUX). TIONS NG COMPRESSED FROM 100MM. GALVANISED STEEL O FLOOR.

CRETE BLOCK WALL

FIRE PROOF OF 215MM WALL.



930/58.

Osborne Architecture Planning Project Management

Kerrymount Avenue Foxrock Dublin 18. David McCready & Associates

Civil and Structural Engineers 29 Pembroke Park Ballsbridge Dublin 4.

Phone 680342.

Mr G. Osborne Osborne Architecture Kerrymount Avenue Foxrock Dublin 18

17/05/1991

RECEIVEB

29 MAY 1991

REG SEET

Dear Sir,

Please find enclosed copies of structural engineering calculations for by-law of drawings #930. All calculations have been prepared in accordance with the appropriate standards and/or codes of practice as individually specified.

D. Me Creage .

D.C. McCready

MOMENTS & SHEAR TO COL FV = 0-64 × ½ (6.09 × 7.3) = 14.23 KN SHEAR FW= 14.	•		Project No.
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٠ ا Alterations to Office Areas
to

Unit No 21

Parkmore Industrial Estate

for

Dorothy and Paul Ledwidge.

Contents: -

RECEIVED

General:

29 MAY 1991

Excavation:

REG.

Concrete:

Blockwork:

Fire Proof Protection:

Timber and Joinery:

Ironmongery:

Electrical Installation:

Painting and Decoration:

Osborne Associates The Mews Kerrymount Avenue Foxrock Dublin 18.

GENERAL

Local and Other Authorities:

The contractor shall comply with all the bye-law and other requirements of the Local Authority.

Conditions of Contract:

This specification is an outline specification and should be carefully read in conjunction with the working drawings and the provisions laid down in the Contract Document.

-- .. -.-

Materials and Workmanship:

The materials and workmanship shall be in accordance with the drawings and the specification.

Quality of Materials:

The term "standard specification" means the latest specification for the respective articles so described and accepted by the Local Authority or otherwise by agreement with the Architect.

Water:

The contractor shall be responsible for the provisions of a proper water supply of clean water for the use of the works.

Notification:

The contractor shall notify the Local Authority at the appropriate stages of the work and arrange for all inspections.

Contractor to examine drawings and visit the site.

The contractor undertaking the work and tendering will be deemed to have examined the Drawings and the Specification, the site and all features thereof with all the drains, mains, adjoining premises or other matter affecting in any way the proposed works. The contractor with have ascertained for himself the nature and extent of the work to be carried out, the conditions under which it is to be executed, levels of the ground and facilities for delivery and storage of materials, plant, etc. and to have generally obtained his own information in all matters and incidentals which could in any way influence his tender. The client accepts no responsibility for any additional works outside any extra works ordered or variations to the main contract.

Satisfaction of the Works.

The work is to be executed under the supervision, control and to the entire satisfaction of the Architect, and the contractor shall give due and proper notice to the Architect and await his inspection before executing foundations or any other work connected with drainage, or otherwise, covering up works or proceeding with works about which there is any difficulty or doubt.

Samples |

Samples of all materials, manufactured articles and workmanship shall be procured in accordance with the specification and submitted to the Architect for provisional approval before adoption, but such approval shall not relieve the contractor in any way from responsibility for defects appearing subsequently. Approved samples will be retained until completion of the contract by the Architect, who shall have power to reject all materials and samples in all respects. Materials and manufactured articles supplied or fixed, or work executed without submission or approval of samples shall be removed and the necessary reinstatements executed at the contractors expense should the Architect so direct. All materials are to be new unless otherwise specified and if required, the contractor is to furnish evidence that the materials are of the origin, description and quality or price specified.

Safety Precautions.

The contractor shall take all the necessary precautions for the safety of the workmen and the public and shall comply with the provisions of the current Building (Safety, Health and Welfare) Regulations.

Protection of the works.

The contractor is to permit nothing to be done calculated to injure the stability of the work or building, and no cutting through walls or floors is to be allowed, other than where required by the drawings or the specification therein without the sanction of the Architect, and the contractor will be held responsible for all damage arising through carelessness or inadvertence in this respect.

Conditions of Contract.

The conditions of contract shall be the R.I.A.I. form of contract without Bills of Quantities.

Scope of the Contract.

The whole of the works are to be carried out in a good and workmanlike manner to the full intent and the meanings of the drawings and standards together with all materials and workmanship etc. are to be of the respective kinds as described in this

specification and in accordance with the conditions of contract and to the satisfaction of the Architect.

Commencement of the Work.

The work shall be commenced when so directed by the Architect and shall be carried out with due diligence and with such expedition as, in the opinion of the Architect, maybe considered necessary to ensure its completion within the contract period. The contractor shall submit a progress schedule for the Architect's approval within 14 days of his receipt of the order to commence, setting out a building programme.

In all contracts, the contractor shall arrange with the Local Authority Bye-Law section to examine the work at the following stages:-

- 1. Trenches for foundations.
- 2. Damp Proof Course Level.
- 3. Fire Protection of Floors.
- 4. Fire Protection of Roof.
- 5. Completed Contract.

Temporary Fencing and Protection.

The contractor shall provide all temporary fencing, hoarding and the like, that he considers necessary for he protecting of the works, adjoining property, and the public, and for the proper execution of the works. It is the contractors responsibility to see that no foreseen accidents occur on the site.

Demolition and Removals.

The contractor shall be deemed to have visited the site and examined the existing building, and site etc in order to ascertain their nature, and the extent of the work involved in their retention where shown and their removal where necessary. Old materials, if considered suitable by the Architect may be subsequently be re-used as dry filling or otherwise, subject to the Architect's approval.

No buildings or other works are to be taken down or otherwise interfered with without the approval of the Architect. Provide for the filling in of all openings and for taking up any old drains, sewers or pipes met during excavation, and for properly sealing up outlets of the same. Cart away all rubble matter off the site.

Contingency Sum and Variations.

Include a contingency sum in the amount of £2500.00 in respect of this contract, these monies only to be expended on the written instructions of the Architects. Any oral instructions, directions and explanations given by the Architect or his agent shall., if involving a variation, shall be confirmed in writing by the contractor to the Architect within five working days. If not dissented from in writing by the Architects within five working days from receipt of the written confirmation the variation shall be deemed to be authorized in writing. All variations ordered shall be measured and valued without delay by the Architect or Quantity Surveyor who shall give to the contractor the opportunity to be present with him on the site and to take what notes and measurements as the contractor may require.

EXCAVATION

Concrete Floor:

Cut out existing floor cleanly with a concrete saw for the full length of the proposed wall. Excavate out for strip foundations and concrete piers. Excavate to allow for the full width and depths of footings down to a solid base. All excavations are to be levelled, rammed inspected and approved by the Architect and by the Local Authority before the concrete is laid. See details of footings and piers on details 20/01 and 20/02 on drawing no 930/56.

Return, Fill in and Ram:

Return and fill selected material around foundation up to the original floor level, or as required in layers not exceeding 225mm thick; carefully ram and consolidate with the addition of water if directed by the Architect.

No filling shall be excavated until the foundation and the footings have been inspected and approved by the Architect and by the Local Authority.

Earth Filling:

Wheel and fill selected excavated particulars in layers not exceeding 225mm thick and consolidate to make up levels under hardcore beds.

Load and cart away surplus excavated, material or spread level as directed on site.

Free from Water:

Keep the whole of the excavation free from water by pumping bailing or drainag if necessary.

Provisional Depths:

Depths of all excavations shown on the drawings are provisional. Further excavation may be necessary to provide a solid bedding for foundations.

Planking and Strutting:

The contractor shall provide any planking and strutting required_for the safe support of all excavations. The contractor is to give to the Architect twenty four hours notice when excavations will be ready for inspections. The bottom of every excavation will be inspected by him, and no concrete is to be laid until the Architect has approved the bottom. The contractor shall step the trench base or excavate in stages as directed by the Architect.

Hardcore Filling:

Blinding:

Blind over hardcore with approved fines to a consolidated thickness of 50mm ready to receive a damp proof membrane or lap and seal with the existing damp proof membrane as required. Suitable material for fines are sand, find gravel or P.F.A. The blinding is to be left for examination by the Architect.

CONCRETE.

Cement:

The cement is to be Portland Cement in accordance with IS. 12 for Portland Cement (normal setting). All cement shall be in the original sealed packages of the manufacturers, each containing the same weight of cement. Each bag shall show the makers name, the type of cement and the consignment number. Each consignment shall be accompanied by a Certificate of Quality. The cement should be stored in a weather proof store and protected from damp.

Water:

Clean fresh water is to be used and free from all impurities and fit for human consumption.

Aggregates:

All fine sand aggregates and coarse aggregates shall be washed and well graded and conform to IS. 5 (1949) for course and fine aggregates from natural sources. Run of pit material will not be permitted for any reinforced or precast concrete work.

Rejected Materials:

All materials that have been damaged, contaminated, have deteriorated, or do not comply with the requirements of this specification, shall be rejected, and shall be removed immediately from the site.

Gauging and Mixing:

Quantities of cement shall be measured by weight, the unit being one bag of 50 kg. and the constitution of each batch shall be such that the cement required per batch is in the units of 50kg. Aggregates for concrete shall be measured by weight in an approved weight batching mixing plant.

All proportioning must be carried out in such a manner that the proportions of the materials may be easily and readily checked. The batches of concrete shall be proportioned to the size of the mixer, to produce the best results. The entire contents of the hopper shall be completely discharged each time a batch is mixed. No concrete shall be mixed for more than half an hour, or shall on any account be placed in permanent work without the approval of the Architect.

The cement and aggregate shall be mixed in an approved mechanical batch mixer. Mixing shall continue until the mix is uniform in texture but in any event for not less than two minutes. Water shall be added only after the drum is fully charged with other materials. The volume of the mixed materials shall not exceed the rated capacity of the mixer drum. The entire contents of the mixer shall be washed out thoroughly whenever work ceases.

Ready mixed Concrete:

Ready mixed concrete from an approved supplier may be used provided it is equal in all respects to the concrete specification for the works and complies with BS 1926.

Concrete Mixes.

Concrete Type.		1.	2.	3.	
Aggregates	Max Size	40mm	20mm	14mm	-
	Cement	1	1	1	
Mix Prop	Fine Aggregate	3	2	3	-
	Coarse Aggregate	6	4	6	

The water-cement ratio shall be kept to the minimum needed to ensure reasonable workability, but should not exceed 35 liters per 50kg. of cement.

Types of Concrete for Various Locations:

Class 1: manholes,	Foundations, Bases for light and fencing standards, stays and columns. Beds for flooring, drains,
	A.J's etc. Footpaths and paving.
Class 2:	External and Internal Walls.
Class 3: walls,	Suspended floors, roofs, cover slabs, retaining
	Beams, Lintols, Columns and Copings. platforms and entrances, kerbs. Benchings, coverings, surrounds to drain pipes. Precast concrete lintols, sills window surrounds

Curing:

During initial setting and curing the concrete will be protected against excessive heat, frost, shock and vibration and no traffic must be allowed on it until properly hardened. No concrete of any kind shall be placed during a falling temperature of 4 degrees or less or until after the rising temperature exceeds 1 degree. When depositing concrete at or near freezing temperatures, approved precautions shall be taken to ensure that the temperature of the concrete is maintained at above 4.5 degrees C until it is thoroughly hardened. All concrete damaged by frost shall be removed and replaced by the Contractor.

Concrete Compacting:

The whole of the concrete shall be thoroughly compacted during the operation of placing and be well compacted around embedded fixtures and into corners of the formwork. All necessary rammers and spatules shall be provided and employed to ensure compact and smooth faced work throughout.

Transport and Placing:

The transport of concrete and the placement of the concrete shall be in accordance with the latest code of practice. Under no circumstances shall concrete be transported more than 15 Meters.

Foundations:

Foundations shall be to sizes as shown on drawings and foundations. Care is to be taken in depositing concrete in foundations to ensure that it is rammed closely against the face of the trenches in order that there be more further subsequent settlement or disturbance of the ground. See drawing no 930/56.

Ground Floor Construction:

All concrete floors and repairs are to be 150mm concrete slab laid on a 500 gauge visqueen tied into existing dpm if appropriate and dressed up to and across all internal and external walls on a dpc. The dpm is to be laid on 50mm sand blinding. The blinding is to be laid on a minimum of 200mm consolidated hardcore.

BLOCKWORK.

Structural Blockwork:

The walls are to be constructed in 215mm hollow concrete block or 102mm solid block as indicated on the drawings. The blockwork shall comply with I.S. 20 (1971). The blockwork shall be properly bonded at the junctions and angles, plumb at quoins and jambs, with prestressed spanlight or metal

lintols where openings are required for doors or windows. See drawing no 930/55 for external windows.

Rising Walls:

The rising walls in blockwork are to be 215mm solid blockwork with a dpc inserted a minimum of 150mm above ground level otherwise they are to be inserted in the walls above the joints of the dpm in the structural walls.

Fixing Plugs:

Provide fixing plugs to take all timber fixture, such as skirtings etc. and for the securing of doors and windows.

Exisiting Walls:

At the junction of new blockwork with existing walls fix to existing wall, expanded metal strips, with heavy duty masonry nails at each course of blockwork, to be inserted by cartridge gun or else pre-drilled. Each 100mm wide strip to be bent at right angles at each course to take new blockwork.

Damp Proof Courses:

The damp proof course shall be bitumen on a Hessian base complying with IS 57. Damp proof course to be laid on a bed of mortar on all walls and lapped 150mm at junctions.

DPC over Lintols:

Provide a dpc movement joint over each prestressed spanlight lintol. The spanlight lintol shall in all respects comply with the loading/span ratio as laid down by the manufacturers.

DPC under Cills:

The DPC under cills to be returned at the back of cills to the full height of the cill and at the cill ends and to project a minimum of 25mm beyond the external finish of the wall.

Damp Proof Membrane:

The damp proof membrane to the concrete floor shall be 500 gauge polythene sheeting, which shall be laid over the blinding. Where joints have to be made, these shall be double welt folds, as per manufactures instructions. In all cases the dpm shall be turned up to floor level on the external walls and extending over all walls with a foundation.

FIRE PROOF PROTECTION.

Fire Proof Partitions:

Provide 1HR fire resistance partition to warehouse from offices. The partition is to comply with BS 476 Part 8:1972. The partition is to be constructed with 50mm.36mm.0.6mm channel studs at a maxima of 610mm centers. Provide 60mm thick mineral wool (23kg/cub M) between studs. Provide 6mm supalux fillets 50mm wide on both faces of channels and 9mm supalux coverstrips 75mm wide, behind horizontal joints, fixed on both sides of the joint with 19mm.no8 self tapping screws. Provide 9mm Supalux fixed to both sides with 25mm. no 8 self tapping screws. All fixings at a maximum of 300mm centres. FIRTO Report TE 4588.

1HR Fire Doors:

Provide 1Hr fire doors to warehouse from all office areas. The doors should comply with BS Part 8:1972. They should be self closing and contain an intumescent strip. The doors should be delivered and installed as a full fire door set and a copy of the fire certificate from the relevant testing station should be available for inspection.

1/2 HR Fire Doors:

Provide 1/2Hr fire doors to all landing doors and staircase exits in the office area in addition to the main public areas as indicated on the plans. The doors should comply with BS Part 8:1972. They should be self closing and contain an intumescent strip. The doors should be delivered and installed as a full fire door set and a copy of the fire certificate from the relevant testing station should be available for inspection.

Existing Ground Floor Ceilings:

The existing ground floor ceilings and first floor area are to be made 1hr fire resisting. Due to the unreliability of the existing nailing of the plasterboard ceiling all ceilings are to be filled with 18mm aggregate gypsum plaster trowelled between joists in conjunction with metal lathing well turned up and fixed to joists for 75mm. Polythene sheeting is to be used for base to prevent staining below. Existing chipboards are to be removed and replaced with either 150mm.18mm t and g sheeting or 18mm plywood.

Fire Extinguishers:

Provide suitable foam fire extinguishers at each end of landings and to the main offices. Suitable locations for four fire extinguishers are to be found in the warehouse area.

Packing Area:

The partition for this area is to be constructed to an 1/2hr fire resistance. All glazing shall be fixed with no opening sections and will consist of 6mm minimum Georgian wire glass. The partition is to comply with BS 476 Part 8:1972. The partition is to be constructed with 48mm.35mm.0.6mm channel studs at a maxima of 610mm centres. Provide 60mm thick mineral wool (23Kg/cub M) between studs. Provide 9mm supalux coverstrips 75mm wide, behind horizontal joints, fixed on both sides of the joint with 19mm.no8 self tapping screws. Provide 9mm Supalux fixed to both sides with 25mm. no 8 self tapping screws. All fixings at a maximum of 300mm centers. FIRTO Report TE 4566.

TIMBER AND JOINERY.

Materials:

The materials must conform at least to the appropriate British or Irish Standards where such standards exist.

The following British Standards should be noted:-

Timber nomenclature	BS 589, 881.
Structural Softwoods	BS 1860.
Softwood Flooring Grading and Sizing	BS 1297.
British Made Plywoods	BS 1455.
	BS 1202 Parts 1-3. BS 1494.
	BS 916, 1210, 1494 BS 1769, BS 2465.
Timber Connections	BS 1579.
	BS 916, 1494, 1769. BS 3139 Part 1. BS 4395 Part 1.
	BS 144, 913, 1282, BS 3051, 3452-3, BS 3842, 4072.

Timber for carcassing shall comply with BS 1860 and with the recommendations contained in BS and Cp 112.

Hardwood shall comply with BS 1186, Parts 1 and 2.

Hardwood shall be mahogany, teak or iroko where specified to match a sample already approved by the Architect.

BS 1203, 1204.

All timber used throughout the work shall be well seasoned and dry, free from sap, shakes, large or loose knots, waney edges or other imperfections. All timbers found defective in these respects shall be removed from the site.

White deal shall be spruce, straight, well seasoned and free from sapwood. Red deal for joinery shall be redwood or other approved timber by the Architect.

Moisture Content:

Adhesives

The moisture content of all timber shall not exceed the permitted maxima set out in IS 96. All timber shall be free from surface moisture at time of treatment with preservative.

Timber Preservatives:

All timber is to be machined to profile prior to treatment. All timbers are to be pre-treated with preservative in strict accordance with the recommendations of the respective preservative manufacturer. The reduction in size of pre-treated timbers on the job shall be kept to a minimum and timbers so cut, together with all cut ends, notches etc., shall be treated liberally brushing on two coats of distinctively coloured preservative. Small pieces of timber used for grounds etc. shall also be treated with Protim or other approved material. Suitable precaution shall be taken by the contractor by way of the provision of PVC gloves, etc. to ensure that any men in contact with timber preservatives in their wet state are protected from ant possible skin irritation which might result from direct contact.

Workmanship:

any timber splitting or opening to the extent of 2mm or more within the contract period shall be replaced. All joiners work is to be properly wrought and framed together and finished in a workmanlike manner. All framing to be morticed and tenoned. Tonguing to be crossgrained.

<u>Skirtings:</u>

Skirtings are not to be laid until after the flooring is laid, unless otherwise specified. Skirtings shall be scribed along their lower edge to the contours of the flooring. All floors to have 150mm.18mm red deal skirting mitred and angled. Where skirtigs are fixed to blockwork, they shall be secured with 50mm.22mm white deal treated grounds plugged to walls.

Windows:

Provide hardwood windows . The windows shall incorporate a permavent in the glazing section._
See drawing no 930/55 for details.
Window boards, 25mm wrough moulded on edges and corners and secured to grounds and shall be fixed to all windows.
All frames to be bedded in mastic on concrete cill upstands.

External Door Frame:

External door frames shall be prepared 75mm.112mm in wrough deal, rebated in the solid, secured to grounds and doweled at foot to heel blocks. Frames shall not be set into paving or set into concrete step.

Internal Door Frame:

Internal door frame shall be 40mm thick wrough deal with 60mm planted stops. They shall be 100% solid and fixed in accordance with the manufacturer's instructions.

External Door:

External doors shall be to IS48. Head and stiles 112mm.50mm.

<u>Internal Doors:</u>

Internal doors to be flush door to IS48, 50mm nominal thickness with hardwood edging with birch or pine plywood finish standard size 750mm.1980mm. Doors to be hing on one pair of 100mm steel butt hinges.

Architraves:

They are to be $16\,\mathrm{mm}.75\,\mathrm{mm}$ wrough deal mitred at joints and securely fixed to grounds.

Saddles:

Saddles shall be hardwood, splayed from 22mm.150mm splays in a bull nosed finished. Saddles to be provided to all doors unless otherwise stated.

IRONMONGERY.

Samples:

Supply and fix ironmongery from specified sources. Fix all architectural ironmongery with matching screws. Ease and adjust and oil on completion. Label all keys and hand over to specifier. Samples of ironmongery for use on the contract to be submitted to the Architect for approval.

External Door:

To be hung on 1 1/2 pairs of 100mm steel hinges and to be provide with a latch set and mortice lock finished in chrome plate handles.

Internal Doors:

Internal doors to be hung on 100mm steel hinges and fitted with suitable mortice type lock complete with furniture and level action handles. The doors are to be fitted with suitable door closers.

Sash Ironmongery:

All opening sashes shall be fitted with strong metal fasteners. Side hung and top hung sashes shall be fitted with strong stay gear.

ELECTRICAL INSTALLATIONS.

Conditions and Workmanship:

The Electrical Installation will be supervised and subject to the approval of the ESB and the Local Authority. The electrical installation shall form part of the general building contract and the responsibility for carrying out the work will be with the contractor to a satisfactory finish who shall let out the work to an experience firm of electrical contractors. Only electrical contractors of good standing and with previous experience of similar work will be permitted to undertake the work. Approval of the electrical sub-contractor or of any arrangement made by the general contractor for carrying out the work must be obtained before the installation is commenced.

- All electrical work must comply with the following publications:1. National Regulations for Electrical Installations issued by the National Wiring Rules Committee (1968).
- 2. Requirements for Earthing in Electrical Installations published by The Electrical Supply Board.
- 3. Reductions for the Electrical Equipment of Buildings of the Institute of Electrical Engineers-14th Edition.
- 4. National rules for Electrical Installations published by the Electro-Technical Council of Ireland (1976).

Workmanship and Supervision:

The electrical contractor shall settle any minor details that may arise in the wiring of the buildings and to carry out alterations or instructions which, from time to time that may be given to him by the Architect or Engineer so far as these instructions are contained in the terms of the specification, schedules and plans which have been deemed to be accepted in their entirety by the contractor, except in the case of a variation which has been agreed.

Inspection of the Work:

All materials used on this contract must be available for __ inspection by the Architect or the Engineer at any time during the course of the contract.

Commencement of Installation:

The contractor is to notify both the ESB and the Local Authority if required of any work that he is required to do in advance. Failure to do this may necessitate the removal of work completed by him, in order to enable a proper examination to take place and in such a cas the cost of the removal or replacement shall be the contractors. The lines, positions, and ways of electrical mains are to be ascertained by the contractor at an early stage, so that, where possible, ways are left to avoid the unnecessary cutting away of finished work.

Testing on Completion:

The Architect or Engineer shall, be notified when the electrical_installation is completed. The Architect or Engineer shall within fourteen days of receipt of such notice, examine and if he deems fit, test the work in question.

No project will be taken over by the client unless the electrical installation has been certified by the Engineer and the ESB. The contractor shall provide the use of an electrician to assist the Engineer in carrying out any test that are deemed necessary in order to certify the works.

order to certify the works.

The contractor shall arrange to test each circuit with bell and battery for the location of wrong loops, etc before handing over the project.

In the event of any deviation from the contract specification or drawings, the Engineer will not certify it unless prior approval in writing was obtained.

The system is to be passed in its entirety by the ESB before the installation is taken over.

Conduits:

A minimum of 20mm diameter round plastic conduit shall be installed for switch and socket outlet drops and shall be finished at least 150mm above or below the level of the joists or floor. The conduit shall be secured to the satisfaction of the Architect or Engineer.

Switches:

Switches are to be white bakelite flush type switches rocker arm pattern to BS 1299 shall be fitted 1.0M over floor level.

Lighting:

Provide twin 1.8m fluorescent lights to all offices. See detailed lighting layout plan.

PAINTING AND DECORATING.

Painting:

None other than skilled workmen, except apprentices, to be employed on the works. All paint is to be prepared and applied strickly in accordance with the manufacturer's instructions. The approval of the Architect must be obtained to any proprietary paint before use. The contractor shall be allowed to use only paint as approved. The paint shall be delivered to the site in sealed tins bearing the manufactures name and clearly labeled as to the quality of the paint. Additions or alterations of these products will not be allowed. The undercoating shall be the same brand as the finishing coat. Paints for internal and external use shall be of first quality hard gloss conforming to IS32.

All surfaces to be thoroughly dry before knotting, stopping or painting.

Primer:

The priming paint for joinery shall be an approved oil resin primer containing aluminium to comply with BS 4756. Priming shall be carried out at an early stage on the site and before the joinery is exposed to weather but not less than ten days after treatment with preservatives as herein before specified. The primer shall be applied to all door and window surrounds prior to fitting.

Internal Woodwork:

All internal woodwork shall be knotted, primed, stopped, filled and painted one coat of undercoating and one finishing coat of white gloss.

External Woodwork:

All external woodwork be knotted, primed, stopped and filled. Bottom edges of all doors shall be primed and painted one coat prior to hanging, all other woodwork to have two coats of undercoating and one finishing coating white unless stated otherwise.

Ceilings:

Ceilings throughout shall be finished in two coats emulsion paint in colour white and applied in accordance with the manufacturer's specifications.

Internal Wall Finishes:

All internal wall finishes should be coated with 2 coats of emulsion to the schedule of colours as defined by the client.

Cleaning the Works:

Remove all rubbish and finished with materials from the site. Remove rubbish and debris from factory. Clean out all areas and leave fit for human habitation.

> Specication May 1991. Osborne Associates