Dublin County Council Comhairle Chontae Atha Cliath

Planning Department



Bloc 2, Ionad Bheatha na Eireann, Block 2, Irish Life Centre, Sraid na Mainistreach Iacht, Lower Abbey Street, Baile Atha Cliath 1. Dublin 1. Telephone. (01)724755 Fax. (01)724896

Register Reference : 91A/0446

Date : 21st October 1991

Dear Sir/Madam,

Development: Revised development of 41 houses on 5.6 acre site of

previously approved developments(O.P.ref.no. 88A/0014, appro.ref no.89A/0367) and relocation of entrance to

existing house on adjoining site

LOCATION : "Springvale" Edmondstown Rd. Ballyboden

Applicant : Dunboden Estates Ltd.

App. Type : Additional Information

I wish to inform you that by Order dated 17.10.91 it was decided to GRANT PERMISSION for the above proposal.

This decision, together with the conditions/reasons attached thereto, is recorded in the Planning Register kept at this office in accordance with Section 8 of the Local Government(Planning and Development)Act 1963. This register may be inspected during office hours [9.00a.m.- 12.30p.m. 2.15p.m. - 4.30p.m.] and interested party may obtain a certified copy of an entry therein on payment of a fee of £5 in respect of each entry.

It should be noted that the proposer may appeal to An Bord Pleanala against the decision or any conditions attached to the Council's decision within one month beginning on the day of receipt by him of the Council's decision. Any other person may appeal to An Bord Pleanala within three weeks beginning on the date of decision. Interested parties are advised to consult the Planning Authority or An Bord Pleanala to ascertain if an appeal has been lodged by the applicant.

Fionnuala Rogerson, Ardtona House, Lower Churchtown Road, Dublin 14.

Dublin County Council Comhairle Chontae Atha Cliath

Planning Department



Bloc 2, Ionad Bheatha na Eireann, Block 2, Irish Life Centre, Sraid na Mainistreach Iacht, Lower Abbey Street, Baile Atha Cliath 1. Dublin 1. Telephone. (01)724755 Fax. (01)724896

Register Reference: 91A/0446

Date: 21st October 1991

All appeals against decisions of the Planning Authority and all correspondence in relation to new and existing appeals should be addressed to The Secretary, An Bord Pleanala, Blocks 6 & 7 Irish Life Centre, Lower Abbey Street, Dublin 1.(Tel.728011). Any appeal made to An Bord Pleanala will be invalid unless the correct fee is received by An Bord Pleanala within the statutory appeal period. The fee in respect of an appeal by an applicant for permission relating to commercial development is £100; any other appeal is £50.

Submissions or observations made to An Bord Pleanala by or on behalf of a person (other than the applicant) as regards an appeal made by another person must be accompanied by a fee of £15.

Yours faithfully,

トゥフィ

for PRINCIPAL OFFICER

Qublin County Council Comhairle Chontae Atha Cliath

Planning Department



Bloc 2, Ionad Bheatha n Eireann Block 2, Irish Life Centre,
Sraid nā Mainistreach lacht,
Lower Abbey Street,
Baile Atha Cliath 1.
Dublin 1.
Telephone. (01)724755
Fax. (01)724896

Register Reference : 91A/0446

Date : 21st October 1991

Dear Sir/Madam,

Development: Revised development of 44 houses on 5.6 acre site of

previously approved developments(O.P.ref.no. 88A/0014, appro.ref no.89A/0367) and relocation of entrance to

existing house on adjoining site

LOCATION : "Springvale" Edmondstown Rd. Ballyboden

Applicant : Dunboden Estates Ltd.

App. Type : Additional Information

I wish to inform you that by Order dated 17.10.91 it was decided to GRANT PERMISSION for the above proposal.

This decision, together with the conditions/reasons attached thereto, -is recorded in the Planning Register kept at this office in accordance with Section 8 of the Local Government(Planning and Development)Act 1963. This register may be inspected during office hours [9.00a.m.- 12.30p.m. 2.15p.m. - 4.30p.m.] and interested party may obtain a certified copy of an entry therein on payment of a fee of £5 in respect of each entry.

It should be noted that the proposer may appeal to An Bord Pleanala against the decision or any conditions attached to the Council's decision within one month beginning on the day of receipt by him of the Council's decision. Any other person may appeal to An Bord Pleanala within three weeks beginning on the date of decision. Interested parties are advised to consult the Planning Authority or An Bord Pleanala to ascertain if an appeal has been lodged by the applicant.

Honorary Secretary, C/O 35 Moyville, Dublin 16.

Gublin County Council Comhairle Chontae Atha Cliath

Planning Department



Bloc 2, Ionad Bheatha na Eireann, Block 2, Irish Life Centre, Sraid na Mainistreach lacht, Lower Abbey Street, Baile Atha Cliath 1. Dublin 1. Telephone. (01)724755 Fax. (01)724896

Date : 21st October 1991

Register Reference : 91A/0446

All appeals against decisions of the Planning Authority and all correspondence in relation to new and existing appeals should be addressed to The Secretary, An Bord Pleanala, Blocks 6 & 7 Irish Life Centre, Lower Abbey Street, Dublin 1.(Tel.728011). Any appeal made to An Bord Pleanala will be invalid unless the correct fee is received by An Bord Pleanala within the statutory appeal period. The fee in respect of an appeal by an applicant for permission relating to commercial development is £100; any other appeal is £50.

Submissions or observations made to An Bord Pleanala by or on behalf of a person (other than the applicant) as regards an appeal made by another person must be accompanied by a fee of £15.

Yours faithfully,	'"· .:!"====
. L.D.	
for PRINCIPAL OFFI	CER

Our Ref.: 91A/0446

Seamus Brennan, Esq., T.D., Minister for Tourism, Transport & Communications, Office of the Minister for Tourism, 22 October 1991 Transport & Communications, Baile Atha Cliath 2.

Revised development of 44 houses on 5.6 acre site of previously approved development (O.P. Ref. No. 88A/0014, appro. ref. no. 89A/0367) and relocation of entrance to existing house on adjoining site at "Springvale", Edmondstown Road, Ballyboden for Dunboden Estates Ltd.

Dear Minister,

I refer to your recent representations on behalf of Moyville Residents Association in connection with the above planning application.

I now wish to inform you that by Order Dated 17th October, 1991: it was decided to GRANT PERMISSION for the above proposal.

Yours faithfully,

for Principal Officer.

THIS AGREEMENT made the 40 day of May one thousand nine hundred and ninety one BETWEEN
BALLYMORE HOMES LIMITED having its registered office at Ballymore Eustace, County Kildare of the First Part, DUNBODEN LIMITED having its registered office at 15, Lr. Mount Street, Dublin 2 of the Second Part, MAPLEWOOD HOMES LIMITED havins its registered office at St. Michael's House, 1-3 High Street, Dublin 2 of the Third Part and CARVILL (IRL) LIMITED having its registered office at 43/49 Mespil Road, Dublin 4 of the Fourth Part.

WHEREAS the developments in the Scholardstown Road/Stocking Lane/Edmondstown Road area proposed by the parties to this Agreement are subject to the upgrading of a section of sewer pipe on Ballyboden Road from Scholarstown Road Junction to Ballyroan Road Junction shown coloured yellow on the attached plan.

AND WHEREAS Dublin County Council have made it a Condition of Permission 90A/543, 89A/367, 90A/637 and 90A/453 respectively that the Developer must pay the sum of IR£125,000.00 to Dublin County Council before commencing development.

NOW THEREFORE the parties hereto AGREE to pay to
Dublin County Council for this sewer (in the manner
set out in the Schedule hereto in accordance with the
following Table:-

37% (of IRE125,000.00) £46,250.00

Page 1. . ___

Dunboden Limited
7% (of [R£125,000.00) £ 8,750.00

Maplewood Homes Limited
42.5% (of [R£125,000.00%) £53,125.00

Carville ([r] Limited
13.5% (of [R£125,000.00) £16,875.00

SCHEDULE

Bank Drafts made payable to Dublin County Council for the amounts herein referred to shall be delivered to such of the parties hereto as calls on the other parties to make such payment, within seven days of being called upon to do so.

The party who receives these payments shall forthwith hand the Drafts to Dublin County Council in satisfaction of the Planning Condition referred to above and shall, within seven days of receiving the said Drafts, furnish Receipts from Dublin County Council to each of the parties hereto to the effect that the said Condition has been complied with.

PRESENT when the Common Seal of BALLYMORE HOMES LIMITED was afflixed hereto:--

Page 2.

Soun Whitager

E Sout Rich

PRESENT when the Common Seal of DUNBODEN LIMITED was affixed hereto:-

PRESENT when the Common Seal of
MAPLEWOOD HOMES LIMITED
was affixed hereto:-

The State of the s

PRESENT when the Common Seal of CARVILL (Irl) LIMITED was affixed hereto:

Melad Com

Page 3...___

Dated the day of 1991

BALLYMORE HOMES LIMITED

First Part

DUNBODEN LIMITED


Second Part


MAPLEWOOD HOMES LIMITED

Third Part

CARVILL (Irl) LIMITED

Fourt Part

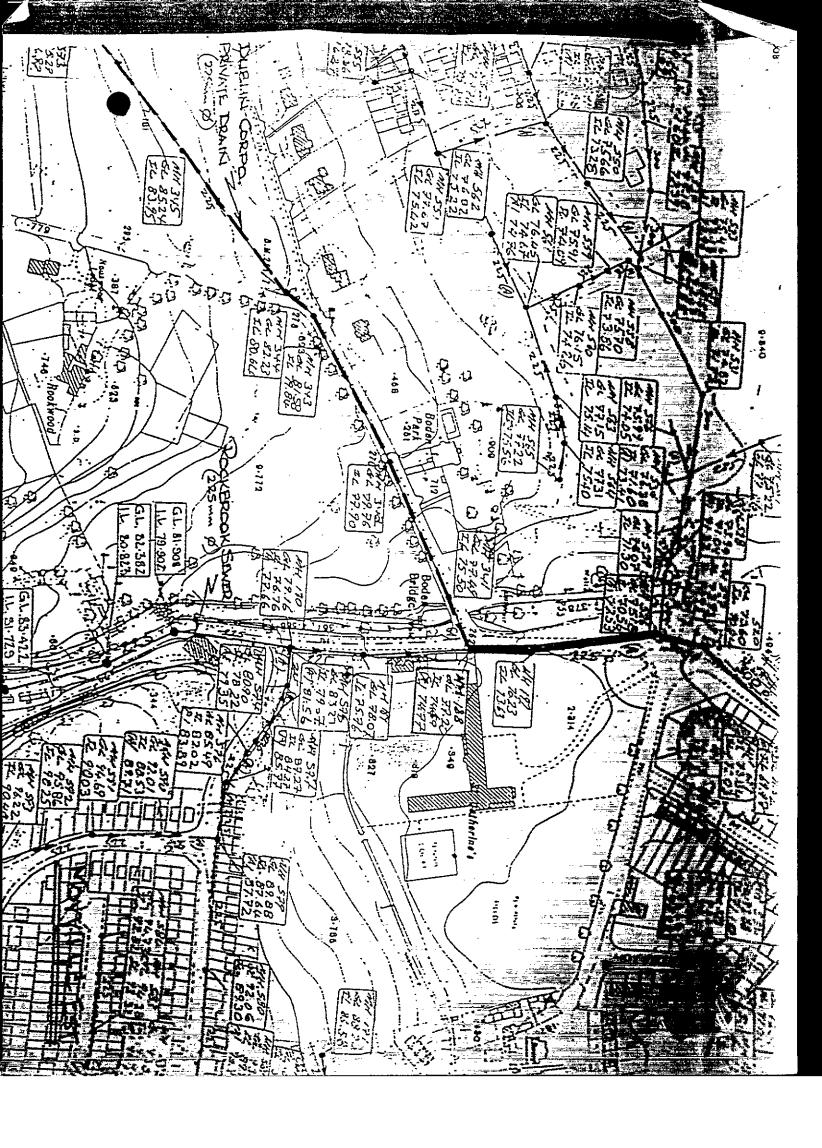

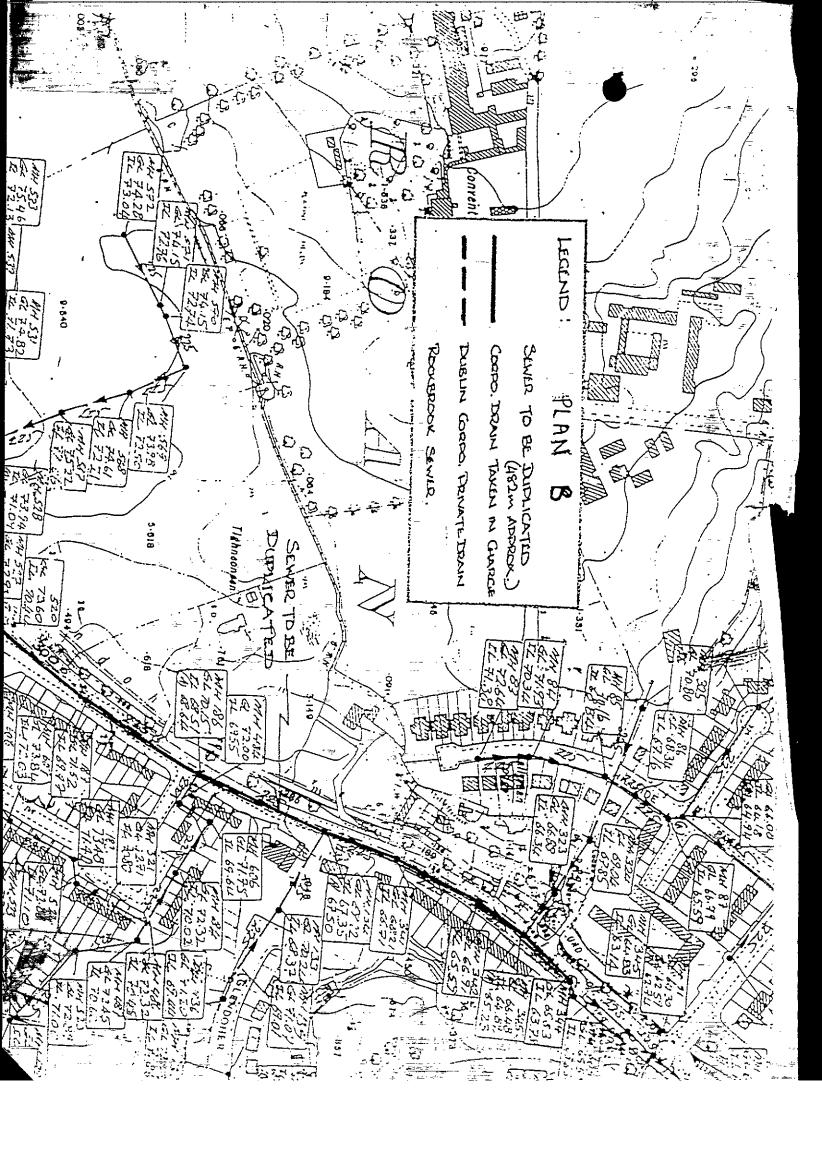

20 June 1991

Seamus Brennan Esq., T.D., Minister for Tourism, Transport & Communications, Office of the Minister for Tourism, Transport, and Communications, Baile Atha Cliath, 2.

Dear Minister,

I wish to refer to your recent letter in which you make representations on behalf of Moyville Residents Association who are objecting to an application for planning permission submitted on behalf of Dunboden Estates Limited for proposed revised development of 41 houses on 5.6 acre site of previously approved developments (O.P. Ref. No. 88A-0014, appro. Ref. No. 89A-0367) and for relocation of entrance to existing house on adjoining site at Springvale, Edmondstown Road, Ballyboden for Dunboden Estates Limited.

I wish to inform you that by letter dated the 22nd May, 1991 the applicant was requested to submit additional information in respect of this proposal. This information has not been received to date.

Your representations have been noted and will be drawn to the attention of the Planning Officer for the area.

Yours sincerely,

for PRINCIPAL OFFICER

DD/MC



OIFIG AN AIRE TURASÓIREACHTA, IOMPAIR AGUS CUMARSÁIDE (Office of The Minister for Tourism, Transport and Communications)

BAILE ÁTHA CLIATH 2 (Dublin 2)

Telephone (01) 789522 Fax (01) 785906

Dept. Office: 767309.

Constituency Office: 9 Braemor Road, Churchtown, Dublin 14. Tel: 957171.

29 May, 1991.

Dermot Drumgoole, Senior Administrative Officer, Planning Dept., Dublin County Council, Block 2, ... Irish Life Centre, Lr. Abbey St., Dublin 1.

Dear Dermot,

I write on behalf of Moyville Resident's Association who I understand have written to your Department on May 17 outlining their objections to application 91A/0446.

I am very concerned about this proposals which seeks to increase the housing density on a site which has already received approval on appeal to An Bord Pleanala.

I would appreciate if you could arrange to have my own objections associated with the papers in the file, and if you could let me know the situation as soon as possible.

With best wishes,

Remus

Seamus Brennan, T.D., Minister for Tourism, Transport & Communications/

COMHAIRLE CHONTAE ATHA CLIATH

Register Reference No.: 91A/446

Planning Department,

Block 2, Irish Life Centre,

Letter No.: 267

Lower Abbey St.,

Dublin 1.

Fionnuala Rogerson, Architects, Ardtona House, Lower Churchtown Road,

Tel.: (01) 724755 Fax.: (01) 724896

Dublin 14.

24 May 1991

Proposed revised development of 41 houses on 5.6 acre site of Re: previously approved developments (O>P> Ref. No. 88A/0014, appro-Ref. No. 89A/0367) and for the relocation of entrance to existing house on adjoining site at Springvale, Edmondstown Road, Ballyboden for Dunboden Estates Ltd.

Dear Sir/Madam,

With reference to your representations/objections, I wish to inform you that additional information was requested on the proposal on 22nd May, 1991, and particulars of such request have been entered in the Planning Register. The Register is available for inspection at the Planning Department, Irish Life Centre, Lower Abbey Street, Dublin 1, during office hours (9 a.m. to 12.30 p.m. and 2.15 p.m. to 4.30 p.m.)
A certified copy of the entry in the register may be purchased on payment of £5.00.

Yours faithfully,

for Principal Officer.

COMHAIRLE CHONTAE ATHA CLIATH

Register Reference No.: 91A/446

Planning Department,

Block 2, Irish Life Centre, Letter No.: 311

Lower Abbey St.,

Dublin 1.

Moyville, Edmondstown Green, Edwards Court & Beechview (M.E.E.B.)

Residents Association,

35 Moyville, Dublin 16.

(01) 724755 (01) 724896

Fax:

24 May 1991

Re: Proposed revised development of 41 houses on 5.6 acre site of previously approved developments (O>P> Ref. No. 88A/0014, appro-Ref. No. 89A/0367) and for the relocation of entrance to existing house on adjoining site at Springvale, Edmondstown Road, Ballyboden for Dunboden Estates Ltd.

Dear Sir/Madam,


With reference to your representations/objections, I wish to inform you that additional information was requested on the proposal on 22nd May, 1991, and particulars of such request have been entered in the Planning Register. The Register is available for inspection at the Planning Department, Irish Life Centre, Lower Abbey Street, Dublin 1, during office hours (9 a.m. to 12.30 p.m. and 2.15 p.m. to 4.30 p.m.) A certified copy of the entry in the register may be purchased on payment of £5.00.

Yours faithfully,

レ・ア

for Principal Officer.

MOYVILLE, Edmondstown Green, Edwards Court & Beechview (M.E.E.B.) RESIDENTS ASSOCIATION

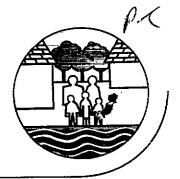

Your Ref: 91A/0446

Our Ref: rf

___ Date: 17/5/91

All correspondence to the Honorary Secretary at: 35 Moyville,

Dublin County Council Planning Department, Irish Life Centre, Lower Abbey St., Dublin 1.

Dublin 16.

RE: Proposed Housing at "Springvale", Edmondstown Road, Ballyboden.

OBJE

Dear Sirs,

This Association hereby objects to the above proposal to contruct over 40 houses; the site already has approval for 30 houses (reg. ref. 89A/367) which was granted by An Bord Pleanala on appeal.

While the proposed development many be of a high standard suited to this high amenity site we are most concerned about the_ additional traffic which will be generated by the extra houses. The Council will be aware that we are presently appealing other major housing permissions, primarily on the same grounds.

We are not anti-development but will resist any further housing in this area while the roads infrastructure remains inadequate even for the existing traffic conditions; every extra house will only worsen what is already an unacceptable situation especially in terms of road safety for pedestrians and cyclists.

We earnestly hope that the Council will agree with this approach_ and refuse this application.

Yours sincerely,

Hon. Secretary.

M.O'Shee

MOYVILLE, Edmondstown Green, Edwards Court & Beechview (M.E.E.B.) RESIDENTS ASSOCIATION



Your Ref. 91A/0446

Our Ref: If

Date: 17/5/91

All correspondence to the Honorary Secretary at: 35 Moyville, Dublin 16.

Dublin County Council
Planning Department,
Irish Life Centre,
Lower Abbey St.,
Dublin 1.

RE: Proposed Housing at "Springvale", Edmondstown Road, Ballyboden.

OBJ.

Dear Sirs,

This Association hereby objects to the above proposal to contruct over 40 houses; the site already has approval for 30 houses (reg. ref. 89A/367) which was granted by An Bord Pleanala on appeal.

While the proposed development many be of a high standard suited to this high amenity site we are most concerned about the additional traffic which will be generated by the extra houses. The Council will be aware that we are presently appealing other major housing permissions, primarily on the same grounds.

We are not anti-development but will resist any further housing in this area while the roads infrastructure remains inadequate even for the existing traffic conditions; every extra house will only worsen what is already an unacceptable situation especially in terms of road safety for pedestrians and cyclists.

We earnestly hope that the Council will agree with this approach and refuse this application.

Yours sincerely,

Hon. Secretary.



FIONNUALA ROGERSON ARCHITECTS



Architects and Planners

Dublin County Council, Planning Department, Irish Life Centre, Lower Abbey Street, Dublin 1.

Ardtona House Lower Churchtown Road Dublin 14 Ireland Telephone (01) 984261 Fax (01) 987262

6th May, 1991.

RE: PLANNING APPLICATION - REG. REF. 91A 0446. 44 HOUSES AT SPRINGVALE, EDMONSTOWN ROAD, DUBLIN 16.

Dear Sirs,

We act on behalf of Carvill Ireland Ltd., owners of a site of c. 8½ acres to the front of Rookwood, Stocking Lane, Ballyboden.

It has come to our attention that a current planning application for 44 houses on 5.6 acres at Springvale, Edmonstown Road Reg. Ref. 91A 0445 has included on its location map a portion of our Clients site. The area in question is to the north east of the Springvale site along the Owendoher river. This area was not included on their layout plan. Thus it can be seen, on comparison of these two documents, that the site area as indicated on the layout differs from that shown on the location map.

We would appreciate if the Planning Authority would take the necessary steps to have this situation rectified.

Yours faithfully,

Tonmala Rogerson

Fionnuala Rogerson.



:MOITA	44 ho "Sprengvale Dun Boden	," <i>Ed</i>	mando town	Road	y Bal	Asodan	
LICANT	: Dunboden	Cotates	<u>Ud</u>	<u>=</u> हम ्म ्र		- 1	- Bayangar Pilan
	1	2	3	4	5	6	7
IASS	DWELLINGS/AREA LENGTH/STRUCTURE	RATE	AMT. OF FEE REQUIRED	AMT. LODGED	BALANCE DUE	RED. FFE APPL.	AME. OF RED. FEE
Ŧ	Dwelling (Houses/Flats)	@ £53	f2420	= 2420			
6	Domestic Ext. (Improvement/ Alts.)	€ £30	- Lance day	-			
С	Building for office or other comm. purpose	8 £3.50 per M ³ ·					
Đ	Building or other structure for purposes of agriculture	e e1.00 per M ² to in excess of 300 M ² Min. ETO	10 mm 2 mm				
E	Petrol Filling Station	€ €200		-			<u>चलच</u>
F	Dev. of prop. not coming within any of the forgoing classes.	£70 or £9 per .1 hect. whichever is the greater	22a 2a				
Colum	n 1 Certified: Signa	eā:		Grade:	· · · · · · · · · · · · · · · · · · ·	Der	T =: <u></u>
Colum	n 1 Endorsed: Signe	ed:		Grade:		Da	TE: = //
	ns 2,3,4,5,6 & 7 Cer ns 2,3,4,5,6 & 7 End			— Gr		- ن	De-e-

910/0446 44 houses <u>i.go</u> Edmondotown Road, Back PROPESAL: --> Springualo" LOCATION : Estates Ud DurBoden ۴ 2 EALANCE DUE BALANCE AMOUNT AMTL OF BATE DHELLINGS/AREA DUE LCCCCCT FEE REG. LENGTH/STRUCT EE16 35Cp par M²∫ - - ---:-in excess er 300M² Min.£40 <u>521.75 per</u> -23 gaties? MF of \$40 2225 par ...? ui hect. neot. of EE25 par .11 .1 haci. nect CP E-D 7 - 200 필요요하 pen +3 y .1 he== hect. cr EETC per k metras^t th or £40 3515 Den 1,010m on 640 x1,000±° | \$25 cet .1 in head. hest. ss Eic .umn n Castified: Signad: -----Signed: -lumn 1 Endorsed: iumns 2,3,4,5,6 & 7 Certified Signed: --...C<u>r</u>ece: lumns 2,3,4,5,6 & 7 Endorsed: Signed:

CERTIFICATE NO:

LOCATION GOVERNMENT (PLANNING AND DEVELOPMENT) ACTS, 1953 TO 1982

ASSESSMENT OF FINANCIAL CONTRIBUTION

REG. REF.:			<i>z.</i>
CONT. REG.:			· · · ——— _
SERVICES INVOLVED: WATER/FOUL SEWER/SURF	POE WATER	· · · · · · · · · · · · · · · · · · ·	
AREA OF SITE:	· · · · · · · · · · · · · · · · · · ·		
FLOOR AREA OF FRESENT PROPOSAL:			<i>-</i> /
NEASURED EY:		het 89A/	1367
CHECKED BY:	See Reg		
VETHOD OF ASSESSMENT:		5.6 aves	
TOTAL ASSESSMENT		-	
MANAGER'S CROERED NO: F/ / 1			
ENTERED IN CONTRIBUTIONS REGISTER:	Stands S.S. Noah	of ally when some	hour applant
	Security	50,000 bo	-1 L.
	2 Lfh	4/10/91	•

SOUTH DUBLIN COUNTY COUNCIL COMHAIRLE CHONTAE ÁTHA CLIATH THEAS

Bosca 4122, Lár an Bhaile, Tamhlacht, Baile Átha Cliath 24.

Telefon: 01-462 0000 Facs: 01-462 0104



PLANNING DEPARTMENT P.O. Box 4122,

Town Centre, Tallaght, Dublin 24.

Telephone: 01-462 0000

Fax: 01-462 0104

Date: 19th October 1995

LOCAL GOVERNMENT (PLANNING AND DEVELOPMENT) ACTS, 1963-1993

Register Reference:

91A/0446/C2

Development:

Revised development of 44 houses on 5.6 acre site of previously approved developments (O.P.ref.no. 88A/0014),

appro.ref no. 89A/0367) and relocation of entrance to existing house on adjoining site.

Location:

"Springvale", Edmondstown Road, Ballyboden.

Applicant:

Dunboden Estates Ltd.,

c/o Gerald Cantan, Dip. Arch.,

Architects and Building Consultants,

Unit 2, Edel House, 51-52 Bolton Street,

Dublin 1.

App. Type:

Compliance with Conditions

Dear Sir/Madam,

With reference to the above, I acknowledge receipt of your submission to comply with conditions received on 16/10/95.

Yours faithfully,

for SENIOR ADMINISTRATIVE OFFICER

Gerald Cantan, Dip. Arch., Architects and Building Consultants, Unit 2, Edel House, 51-52 Bolton House, Dublin 1.





GERALD CANTAN

Dip. Arch.

M.R.I.A.I.

Architects and **Building Consultants**

Planning Department, Dublin County Council, P.O. Box 4122, Town Centre, Tallaght, Dublin 24

Unit 2. Edel House, 51-52 Bolton Street, Dublin 1.

Tel: 8727387

13/10/95

Re. Boundary wall along Edmonstown Road, Springvale, Ballyboden, Dublin 16

Dear Sirs,

I acknowledge the receipt of your letter of 9/10/95 regarding the boundary wall at the above.

My client is of the opinion that they have complied with condition 21 of the planning permission Reg. ref. 91A/0446. Condition 21 required that the front boundary road of the site along Edmonstown Road is to be repared in stone to match the existing wall. In practice Dunboden Estates have reconstructed long sections of the boundary wall, including sections additional to the original submission. The elevation along Edmonstown Road and the capping have been faced with stonework.

The intension of condition 21 was to have a stone wall along the Edmonstown Road. My clients have used a technique for reconstructing the wall which is common in these circumstances and is predominantly used by South Dublin County Council and other local authorities in their developments. The exposed blockwork face will quickly weather and become covered in ivy and natural growth. Dunboden Estates would be willing to plaster the blockwork surfaces.

I would be obliged therefore if Dublin County Council would re consider the wall in the light of the above comments. Dunboden Estates have put a lot of work into the boundary wall and into the open space on the site.

16 OCT 1995 APPLICATION RECEIVED

REG. NO. 91A 146 C2

VAT No. F16777190

C2

Dublin County Council Comhairle Chontae Atha Cliath Planning Department







Bloc 2, Ionad Bheatha na hEireann, Bloc 2, Irish Life Centre, Sraid na Mainistreach lacht, Lower Abbey Street, Baile Atha Cliath 1. Dublin 1. Telephone (01) 724755 Fax (01) 724896

Mr. R. Cremins S.E.D.C. Planning Department, Dublin County Council: Enf 8758 7

7 September 1992

RE:

Residential development at Springvale, Edmondstown Road, Ballyboden

I refer to compliance lodged on 29th January, 1992 in connection with the above development (Reg. Ref. 91A.446 refers).

As there is enforcement action pending in relation to these lands I should be obliged if you would arrange to have this submission dealt with as a matter of urgency.

Reg. file 91A.446 attached.

Staff Officer; Assistant

c.c. Mr. Wm. Murray, Deputy Dublin Planning Officer

Mr. E. O'Hare, Administrative Officer:

Parks Department



Bosca 174 P. O. Box 174 5 Rae Gardingr. 5 Gardiner Row. Baile Atha Cliath 1. Dublin 1. Telephone, (01)727777 Fax. (01)727530

Mr. D. Drumgoole, Senior Administrative Officer, Planning Department. Dublin County Council.

Our Ref.

Your Ref.

Date

08.05.1991_

Application for 44 No. Houses at Springvale, Edmonstown Road, Ballyboden. Reg. Ref. 91A/446. RE:

With regard to this application, the Parks Department's comments are;

This application is for 44 No. houses, which represents an 1) increase of 12 No. houses on the previous grant of permission (89A/367 PL 6/5/79448), however, the applicant shows no additional public open space. In this regard, it is considered essential that the applicant be requested to pay a financial contribution of £1,000 per additional house (f12,000) towards the provision and development of Class I public open space in the area.

The applicant be requested to adhere to the conditions of 2) the An Bord Pleanala decision (PL 6/5/79448). Furthermore, the applicant should submit and agree proposals for street DEVELOPMENT CONTROL SECT

tree planting.

SENIOR PARKS SUPERINTENDENT

Orginally Lodged - 26/3/91

REG. REF:

91A/0446

(P---

DEVELOPMENT:

41, Houses at Springvale, Ballyboden - Planning

Permission.

LOCATION:

Springvale Edmondstown Road.

APPLICANT:

Cagew Associates

Mr. P. Raferty.

11

The following report relates to drawings indicated below.

PLANNING DEPT.

DEVELOPMENT CONTROL SE

Date 16. 12. 51

Time.....

Job No. 91/047 Drawing No. 101A

Drawing No. 105

Drawing No. 106C

Drawing No. 107A

Drawing No. 110

FOUL SEWER - Drawing No. 101A. - Available as indicated subject to the following.

- a) All manholes must be insitu concrete and any prospective sewer must be surrounded in concrete where the depth of cover is less than 1.2m.
- b) All manhole covers and frames must be of the heavy duty type.
- c) The minimum gradient between F1 and F2 (within the bridge) must be 1 in 225.
- d) Whatever the final treatment of the bridge superstructure and/or abutment, agreed with the Planning Authority, where the foul sewer is carried externally, this must be designed to blend with the superstructure. The 'cosmetic' treatment must be agreed before work commences.

SURFACE WATER:

Drawing 101A. - Available as indicated subject to the following:-

Details of the diameter and outfall structure of the proposed culverted stream bounding house No. 1 is to be agreed before work commences.

Drawing No. 107A.

Before roofing of houses numbers 1 to 21 and houses 22 to 29 can take place, a final proposal for the treatment of the escarpment to the rear of these premises must have been submitted to the Building Bye Law Department. The stability of the slopes must have been established, certified by a Chartered Engineer. Where it is considered necessary to provide retaining walls (if any) these must be correctly drained and appropriate designs submitted also certified by a Chartered Engineer.

B. Morris,

A/S.E.E.

Endorsed:

F. G. Coffey

Senior Engineer.

4/12/91.

491-

P

Register Reference : 91A 446 Date : 16/8/91 Development: Revised dev. of HA houses on 5.6 acre site : Springvele, Edwardsburn Road, Rollyboder Applicant: Dunboden Estates Ltd. BUBLIN Co. COUNCIL App. Type Planning Officer : Date Recd. ? 8th Aug 1991 2 0 AUG 1991 SAN SERVICES Attached is a copy of the application for the above development . Your report would be appreciated within the next 28 days. Yours faithfully, DUBLIN CO. COUNCIL SANITARY SERVICES PRINCIPAL OFFICER Data received in Sanitary Services See attached sheet

SENIOR ENGINEER, SANITARY SERVICES DEPARTMENT, 46/49 UPPER O'CONNELL STREET, DUBLIN 1

Répusal rec.

PLANNING DEPT.

DEVELOPMENT CONTROL SECT

Date 25...09. 91

9.00

REG. REF:

y. .

91A/ 446

DATE LODGED:

8/8/91

LOCATION:

Springvale, Edmonstown Road, Ballyboden.

APPLICANT:

Dunboden Estates Limited

PROPOSAL:

Revised Development for 44 houses.

FOUL SEWER:

Not available.

1) Unless a special levy of £125,000 is paid in order to upgrade the Ballyboden Road sewer. The required works are between M.H. 526 and M.H. 344 on the County Council Foul Sewer Record Sheet 22/10.

Note: A number of developments to contribute to this levy. See letter 30/1/91 of Mr. F. Coffey, Senior Engineer, Drainage Design to Mr. Simon Clear of An Bord Pleanala. This letter has been sent to Mr. D. Drumgoole.

- 2) A levy of £2,000/acre for the construction of the Rockbrook sewer to be paid by the developer.
- 3) Details of the protection to the sewer in the vicinity of proposed manholes F1 and F2 and at all areas where the cover is less than 1.0 metres to be submitted. The details of the connection to the main foul sewer to be submitted.
- 4) The internal drainage system to be revised so that not more than 6 houses are draining to any combined drain.

SURFACE WATER:

Refusal Recommended.

- 1) Applicant has not indicated the measures necessary to ensure the stability of the bank at the rear of house Nos. 1 21. Any future proposals to incorporate treatment for subsoil drainage in this area.
- 2) The structural details of the proposed bridge, river training walls and any proposal retaining wall behind house nos. 1 21 to be certified by a chartered engineer.
- 3) The foundation of the proposed river training wall downstream of the proposed bridge to be lowered to be below the invert level of the river. The west wing-wall on the upstream side of the proposed bridge to be splayed at 45° .



- 4) The invert level of the concrete floor of the proposed bridge to be lowered to the foundation level of the bridge.
- 5) The pipe size of the proposed culvert at the southern boundary of the site to be submitted. Details of the exit and entry of this pipeline to be submitted.
- 6) The proposed internal surface water system to be combined to have a single outfall. Details of this outfall to be submitted. Where cover to the internal pipe network is less than 1.0 m, 150 mm concrete surround to be incorporated as protection to pipe.

Endorsed:

Senior Engineer.

Register Reference : 918/446

Date : 16 |8 |91 ...

ENDORSED

Woder available from existing men in Colmonastown hand 24hr storage regd Ansvellen Jullenga,

PLANNING DEPT. DEVELOPMENT CONTROL SECT

@

Register Reference : 91A/0446

Date: 12th April 1991

Development: Revised development of 44 houses on 5.6 acre site of

previously approved developments (O.P.ref.no. 88A/0014, appro.ref no.89A/0367) and relocation of entrance to

existing house on adjoining site

LOCATION : "Springvale" Edmondstown Rd. Ballyboden

Applicant : Dunboden Estates Ltd.

App. Type : PERMISSION/BUILDING BYE-LAW APPROVAL

Planning Officer : M.O'SHEE

Date Recd. : 26th March 1991

Attached is a copy of the application for the above development . Your report would be appreciated within the next 28 days.

DUBLIN CO. COUNCIL

PREMAMARY SECURCES

Date received in Sanitary Services 23APR 1991... 18 JUN1991

SAN SERVICES Returned

FOUL SEWER

See attached sheet

SURFACE WATER

do.

SENIOR ENGINEER, SANITARY SERVICES DEPARTMENT, 46/49 UPPER O'CONNELL STREET, DUBLIN 1

R94 367

PLANNING DEPT.				
DEVELOPMENT CONTROL SECT				
Date 19.05.91				
říme: 4-3a				

EUCD.

T	PLANNING DEPT.
١	DEVELOPMENT CONTROL SECT
	19.06.91
-	Date
	Time

Register Reference : 91A/0446

Date : 12th April 1991

ENDORSED	DATE	<u> </u>	·
WATER SUPPLY			
Water avoula	ble to save this Ar and town hoad. Are and susabling to mor expense.	much connect	m existing
chloristian	and suchting to	be comed on	by bublen (o (
at attends to		Jan V Bleary 13/5/11	

ENDORSED

DATE 15 5 91

	DUBLIN COUNTY COUNCIL
REG. REF:	91A/446.
LOCATION:	"Springvale," Edmondstown Rd, Ballyboden.
APPLICANT:	Dunboden Estates Ltd.
PROPOSAL:	Rev. of 33 houses on 5.6 acre site of previously approved development.
DATE LODGED:	26.3.91.
	while site for 21 houses (A.P.D. grant of parmission Reg. Ref.
89A/367 on 18th Janu	n this site for 31 houses (A.B.P. grant of permission Reg. Ref:
Current application layout is similar to	is for 44 units of a smaller size on this site. The proposed that previously approved.
If permission is bei	ing contemplated it should be subject to:-
of 18th January, area. The contr of January 1990 a Price Index-Building Statistics Office to the developer to Du	f £800 per house as per Condition 13 of An Bord Pleanala decision 190 towards improvements to the distributor road network in the ribution to be the sum of money equivalent to £800 per house as and Index linked and updated in accordance with the Wholesale and Construction (Capital Goods) as published by the Central the value pertaining at the time of payment shall be paid by blin County Council towards the cost of road improvements and roposals in the area serving this site.
 Access details to development (incl junction). 	be agreed with the Roads Department prior to commencement of uding carriageway width on bridge and alignment at proposed
Building Control	ning walls, bridge and paths to be agreed with Sanitary Service and Roads Department prior to commencement of development. This bridge railings and approaches etc.
4. Details of Edmon	ndstown Road boundary treatment pedestrian provision etc. to be Planning Authority prior to commencement of development.

EM/BMcC 15.5.91.

	Tracket parties
į	PLANNING DEPT. DEVELOPMENT CONTROL SECT
	Date 23-05-91
1	Time3 50

SIGNED:	E. Nadden	ENDORSED:	
DATE:	15th May 19,	DATE:	

4861 Order No. P/4668/91

COMHAIRLE CHONTAE ATHA CLIATH

Record of Executive Business and Manager's Orders Open Space: 200 90

Proposed revised development of 41 houses on 5.6 acresite of previously approved developments (O.P. Ref. No. 88A-0014, appro. Ref. No. 89A-0367) and for relocation of entrance to existing house on adjoining site at Springvale, Edmondstown Road, Ballyboden for Dunboden Estates Ltd.

Auveen Byrne & Associates, Lioscarran House, 32, Dale Road, Kilmacud, Stillorgan, Co. Dublin. Reg. Ref. 91A-0446 Appl. Rec'd: 26.03.1991 Floor Area:

Site Area: Zoning:

A. I. Kei

8/2/91

5.6 acres.

Report of the Dublin Planning Officer, dated 3 October 1991

This is an application for PERMISSION. The proposed development consists of revised development of 41 houses on a stated 5.6 acre site of previously approved development (Reg. Ref. 88A-0014 and 89A-0367) and for relocation of entrance to existing house on adjoining site at Springvale, Edmondstown Road, Ballyboden for Dunboden Estates Ltd.

The site is zoned "B" in the 1983 County Development Plan "to protect and provide for development of agriculture".

The planning history of the site is as follows:

Reg. Ref. 88A-0014 - Outline planning permission was granted for 32 houses on 5.6 acre site at Springvale (Decision order P/1795/88 dated 9th June, 1938).

Reg. Ref. 89A-0367 - Planning approval was granted for 32 houses on 5.6 acre site at Springvale and the relocation of access to existing residence on adjoining site (Ref. PL 6/5/79448 dated 18th January, 1990).

The present proposal consists of 41 no. houses resulting in a density of 7.3 houses per acre approx.

The proposal seeks to increase the number of houses on the site by about when compared with the approved layout.

The proposed housing layout is similar to the approved layout. In a covering letter submitted as part of the original application it is stated that the same area of land is to be reserved as public open space.

The proposed house types are smaller than those approved under Reg. Ref. 89A-0367, in response to a change in market demands.

CONTRIBUTION:

Standard: 33,600

Scads: £800 per hours
S. Sers: 125,000 per hours
S. Sers: 125,000 per hours
Other:

SECURITY:

Bond / C.I.F.: 50,000

Cash: 35,000



COMHAIRLE CHONTAE ATHA CLIATH

Record of Executive Business and Manager's Orders

Proposed revised development of 41 houses on 5.6 acre site of previously approved developments (O.P. Ref. No. 88A-0014, appro. Ref. No. 89A-0367) and for relocation of entrance to existing house on adjoining site at Springvale, Edmondstown Road, Ballyboden for Dunboden Estates Ltd.

It is noted that an area of land to the rear of house nos. 1-23 adjoining the orchard and the area of land accommodating a new driveway to the existing house are no longer included as part of the site as was the case in the earlier application lodged under Reg. Ref. 89A-0367. This is not significant in the context of this application.

It is also noted that the proposed house plans submitted as part of the original application were for semi-detached houses, while the housing layout (Drg. No. 42A) showed terraced housing. Furthermore, the house plans indicate a larger house than was shown on the site layout.

I understand that the applicant originally submitted in error the wrong site plan, as part of this application, and the correct site plan would have shown 41 no. houses (40 semi-detached and 1 detached).

A letter has been received on behalf of an adjoining land owners who maintain that the site outlined in the site location map includes part of their site. This area of land was not included in the site layout plan (Drg. No. 42A) originally submitted.

A letter of objection to the proposed development received on behalf of local residents has been noted.

The Sanitary Services report dated 15th May, 1991, states that foul sewer is not available unless financial contributions are made towards the upgrading of the Ballyboden Road sewer, and the cost of the Rockbrook Sewer. Details of the sewer crossing the Owendoher River are required to be submitted. The Sanitary Services Engineer recommended that additional information be requested in relation to a number of items, including structural details (including scaled drawings) of the proposed bridge, river training wall, new boundary wall and any proposed retaining walls behind house nos. 1-21 and the stability of the bank here.

Water is available to serve the proposed development from an existing main in Edmondstown Road. A supplementary report from the Water division of the Sanitary Services Department (letter dated 16th May, 1991) has been noted.

The Roads and Parks report dated_15th May, 1991, and 8th may, 1991, respectively have been noted. The Parks Superintendent recommends that a levy of £1000 be levied for each additional house towards the provision and development of Class I Public Open Space in the area.

COMHAIRLE CHONTAE ATHA CLIATH

Record of Executive Business and Manager's Orders

Proposed revised development of 41 houses on 5.6 acre site of previously approved developments (O.P. Ref. No. 88A-0014, appro. Ref. No. 89A-0367) and for relocation of entrance to existing house on adjoining site at Springvale, Edmondstown Road, Ballyboden for Dunboden Estates Ltd.

ADDITIONAL INFORMATION was requested from the applicant on the 22nd May, 1991, with regard to the following:-

1. The applicant is requested to indicate if he is willing to modify the proposed layout drawing to show the provision of semidetached houses as per lodged house plans instead of terraced housing, and if so to submit a revised site layout showing this change.

It should be noted that there is a discrepancy between the size of the proposed houses as shown on the floor plans and the size of the houses as shown on the site layout. This discrepancy should be rectified and the applicant should demonstrate that Development Plan Standard with regard to space around dwellings can be met.

- 2. The applicant is requested to clarify the site boundaries. It is noted that the site as shown on the site location map differs from that shown on the site plan. In particular the applicant is requested to clarify its interest in that portion of the site (i.e. the north east corner of the site) shown as part of the site on the site location map and excluded from the site on the site plan.
- 3. The applicant is requested to submit a letter from a chartered structural engineer certifying the stability of the bank to the rear of houses nos. 1-23.
- 4. The applicant is requested to submit structural details (including scaled drawings) of the proposed bridge, river training wall, proposed new boundary wall and any proposed retaining walls behind houses nos. 1-23, together with a letter of certification for the structural design of these structures from a Chartered Engineer.
- 5. The applicant is requested to submit a longitudinal section of the existing bed level of the river upstream and downstream of the proposed development.
- 6. The applicant is requested to show the provision of a 5 metre distance between the culverted stream on the south boundary of the site and the nearest house.
- 7. The application is requested to confirm that the finished floor levels of houses nos. 1-23 to be at least 0.3 m above the highest recorded flood levels of the stream. The applicant is also requested to submit a letter of certification from a Chartered Engineer demonstrating the stability of the proposed house closest to the stream.

Record of Executive Business and Manager's Orders

Proposed revised development of 41 houses on 5.6 acre site of previously approved developments (O.P. Ref. No. 88A-0014, appro. Ref. No. 89A-0367) and for relocation of entrance to existing house on adjoining site at Springvale, Edmondstown Road, Ballyboden for Dunboden Estates Ltd.

8. Dublin Corporation have scheduled improvement works to the watermain infrastructure in the area. These works include the laying of a 1,000 mm. diameter watermain from Ballyboden Reservoir to Stillorgan Reservoir and the laying of a 600 mm. diameter scour watermain from Ballyboden Reservoir to the Owendoher River. Both of these mains are scheduled to traverse this site.

The Applicant is requested to submit information indicating how these works can be accommodated within the proposed housing layout. The applicant should note that both mains will require ready access and carry with them a sterilized wayleave of 20 metres total width each. The applicant is advised to consult with the Sanitary Services Department Water Division prior to submitting this information.

9. The applicant is requested to submit an acceptable detail for the sewer crossing of the Owendoher River.

In response to Item 1 the applicant has modified the proposed layout showing the provision of 40 no. semi-detached houses and 1 no. detached house. It is noted that there is still a discrepancy between the size of the proposed houses as indicted on the floor plans and the size of the houses as shown on the site layout Drg. No. 41A dated 27.6.91, (with particular reference to houses nos 30-41 which scale on the site plan at less than the 9.2 metres depth indicated on the house plans).

Development Plan Standards with regard to space about dwellings have not been met in all cases (e.g. not all houses have a 7.5 metres long drive way). These standard requirements should be made a condition of the permission.

The applicant has clarified the site boundaries as requested in item 2.

It is noted that the western boundary of the site to the rear of house nos. 1-21 has been altered slightly, on the site plan submitted (Drawing 41A) when compared to the original site plan (Drawing 42A). This change is not significant.

Items 3-5 inclusive and 9 relate_to sanitary services.

In response to item 6 it is stated that the applicant has the permission of the adjoining landowner to divert the culverted stream which runs along the southern boundary of the site onto the adjoining property to the south. A letter has been submitted from the

Record of Executive Business and Manager's Orders

Proposed revised development of 41 houses on 5.6 acre site of previously approved developments (O.P. Ref. No. 88A-0014, appro. Ref. No. 89A-0367) and for relocation of entrance to existing house on adjoining site at Springvale, Edmondstown Road, Ballyboden for Dunboden Estates Ltd.

adjoining property owner clarifying this. The plan submitted (Drawing No. 101) shows that the minimum distance (i.e. 5 metres) will be maintained between the diverted stream and house No. 1 as requested.

Responding to Item 7 it is stated that the finished floor levels of houses nos. 1-21 have been raised and that the lowest finished floor level of these houses will be of 86.2 metres. The flood plane is stated to be 85.60 metres, giving a clearance of 600 m.m.

In response to item 8, it is stated that discussions are currently underway between Dunboden Estates Ltd. and Dublin Corporation in relation to the routing of the proposed watermains.

REPORTS

Dublin Corporation have reported (report dated 2.10.91) that it has no objection to the proposed housing layout as shown on Drawing No. 41A dated 27.6.91. The proposed 1000 mm. watermain and 600 mm. overflow pipeline are to be constructed in the roadway fronting house nos. 30-41. Dublin Corporation state that the development of house nos. 28-41 should not proceed until these sections of the watermain and overflow pipeline are constructed. It is estimated by Dublin Corporation that this work can be complete within 9 months.

This is considered a reasonable requirement and a condition should be attached to this effect.

The <u>Sanitary Services Report</u> dated 17th September, 1991, states that foul sewer is not available unless a special levy of £125000 is paid in order to upgrade the Ballyboden Road Sewer. It also states that a levy of £2000/acre for the construction of the Rockbrook Sewer should be paid by the developer.

Both contributions are considered reasonable. I note that condition 28(a) of Decision Order P/1995/90 dated 14.5.90 (Reg. Ref. 90A/453) for a development of 62 houses at Rockwood (adjoining site to the north) stated that no works was to commence on the site until the foul sewer as Ballyboden road was duplicated at a cost of approximately £125000.

I also note that in the decision to grant permission for a housing development on the adjoining site to the south. (Reg. Ref. 90A/543) a special contribution of £2000 per acre was levied on the developer in respect of connection to the sewer in Edmondstown Road. SInce the site of the current application is similarly "B" zoned land in the 1983 Development Plan, it is considered reasonable to levy this contribution. Such a contribution should in my opinion have been levied under the earlier application on this site (Reg. No. 89A-367).

Record of Executive Business and Manager's Orders

Proposed revised development of 41 houses on 5.6 acre site previously approved developments (O.P. Ref. No. 88A-0014, appro. Ref. No. 89A-0367) and for relocation of entrance to existing house on adjoining site at Springvale, Edmondstown Road, Ballyboden Dunboden Estates Ltd.

In the case of surface water proposals a number of items are raised which are of concern to the Sanitary Services Department. particular, it is stated that the applicant has not indicated the measures necessary to ensure the stability of the bank at the rear of house nos. 1-21. It is also noted that structural details, certified by a chartered structural engineer must be submitted, in relation to the proposed bridge river, training walls and any proposed retaining walls.

At a meeting held on 2nd October, 1991, with the Sanitary Services Department the Sanitary Services Engineer recommended the conditions that should be attached to any permission.

The proposed development is very similar to that already granted permission under Reg. Ref. 89A.367. The main difference being that the house types proposed are smaller and the number of houses on the site has been increased by 9.10

In view of the fact that the level of public open space being provided is in excess of Development Plan Standards, it is considered unreasonable to require the applicant to pay a contribution of £1000 per each additional house. Instead conditions should be attached requiring the front boundary wall to be repaired in stone and the bridge to have a stone facing. Both are necessary in the interest of visual amenity.

I recommend that a decision to GRANT PERMISSION be made under the Local Government (Planning and Development) Acts, 1963-1990 subject to the following sonditions:-

(Conditions attached)

(MOS/BB)

Dublin Planning Officer

4.10.91

Order:-

A decision pursuant to Section 26(1) of the Local Government (Planning and Development) Acts, 1963-1990, to GRANT PERMISSION for the above proposal subject to the (35) conditions set out above is hereby made.

Dated:

October, 1991.

ASSISTANT CITY & COUNTY MANAGER

to whom the appropriate powers have been delegated by Order of the Dublin City and County Manager, dated 4th September, 1991.

Record of Executive Business and Manager's Orders

Proposed revised development of 41 houses on 5.6 acre site of previously approved developments (O.P. Ref. No. 88A-0014, appro. Ref. No. 89A-0367) and for relocation of entrance to existing house on adjoining site at Springvale, Edmondstown Road, Ballyboden for Dunboden Estates Ltd.

CONDITIONS

- REASONS FOR CONDITIONS
- 1. The development to be carried out in its entirety in accordance with the plans, particulars and specifications lodged with the application, as amended by Additional Information received on 8th August, 1991, (the site layout is to be in accordance with drawing no. 41A dated 27th June, 1991), save as may be required by the other conditions attached hereto.
- 2. That before development commences, approval under the Building Bye-Laws be obtained, and all conditions of that approval be observed in the development.
- 3. That each proposed house be used as a single dwelling unit.
- 4. That a financial contribution in the sum of £33,600 be paid by the proposer to the Dublin County Council towards the cost of provision of public services in the area of the proposed development and which facilitate this development; this contribution to be paid before the commencement of development on the site.
- 5. That no development under any permission granted pursuant to this decision be commenced until security for the provision and satisfactory completion of services, including maintenance, until taken in charge by the Local Authority for Roads, Open Spaces, Car parks, Sewers, Watermains and Drains, has been given by:-

- 1. To ensure that the development shall be in accordance with the permission and that effective control be maintained.
 - 2. In order to comply with the Sanitary Services Acts, 1878-1964.
 - 3. To prevent unauthorised development.
 - 4. The provision of such services in the area by the Council will facilitate the proposed development. It is considered reasonable that the developer should contribute towards the cost of providing the services.
 - 5. To ensure that a ready sanction may be available to the Council to induce the provision of services and prevent disamenity in the development.

Record of Executive Business and Manager's Orders

Proposed revised development of 41 houses on 5.6 acre site of previously approved developments (O.P. Ref. No. 88A-0014, appro. Ref. No. 89A-0367) and for relocation of entrance to existing house on adjoining site at Springvale, Edmondstown Road, Ballyboden for Dunboden Estates Ltd.

CONDITIONS

REASONS FOR CONDITIONS

- a. Lodgement with the Council of an approved Insurance Company Bond in the sum of £ 50,000 which shall be renewed by the developer from time to time as required during the course of the development and kept in force by him until such time as the Roads, Open Spaces, Car Parks, Sewers, Watermains and Drains are taken in charge by the Council.
- b. Lodgement with the Council of a Cash Sum of £35,000 to be applied by the Council at its absolute discretion if such services are not duly provided to its satisfaction on the provision and completion of such services to standard specification.

 OR....
- c. Lodgement with the Planning Authority of a letter of guarantee issued by any body approved by the Planning Authority for the purpose in respect of the proposed development in accordance with the guarantee scheme agreed with the Planning Authority and such lodgement in any case has been acknowledged in writing by the Council.
- 6. That all necessary measures be taken by the contractor to prevent the spillage or deposit of clay, rubble or other debris on adjoining roads during the course of the works.
- 7. That all public services to the proposed development, including electrical, telephone cables and equipment be located underground throughout the entire site.
- 6. To protect the amenities of the area.
- 7. In the interest of amenity.

Record of Executive Business and Manager's Orders

Proposed revised development of 41 houses on 5.6 acre site of previously approved developments (O.P. Ref. No. 88A-0014, appro. Ref. No. 89A-0367) and for relocation of entrance to existing house on adjoining site at Springvale, Edmondstown Road, Ballyboden for Dunboden Estates Ltd.

CONDITIONS

REASONS FOR CONDITIONS

- 8. That public lighting be provided as each street is occupied in accordance with a scheme to be approved by the County Council so as to provide street lighting to the standard required by the County Council.
- 9. That no dwellinghouse be occupied until all the services have been connected thereto and are operational.
- 10. That all watermain tappings, branch connections, swabbing and chlorination be carried out by the County Council, Sanitary Services Department and that the cost thereof be paid to the County Council before any development commences.
- 11. That an acceptable street naming and house numbering scheme be submitted to and approved by the County Council before any constructional work takes place on the proposed houses.
- 12. That the developer shall construct and maintain to the Council's standard for taking in charge all the roads, including footpaths, verges, public lighting, open space, sewers, watermains or drains, forming part of the development, until taken in charge by the Council.

- 8. In the interest of amenity and public safety.
- 9. In the interest of the proper planning and development of the area.
- 10. To comply with public health requirements and to ensure adequate standards of workmanship. As the provision of these services by the County Council will facilitate the proposed development it is considered reasonable that the Council should recoup the cost.
- 11. In the interest of the proper planning and development of the area.
- 12. In the interest of the proper planning and development of the area.

Record of Executive Business and Manager's Orders

Proposed revised development of 41 houses on 5.6 acre site of previously approved developments (O.P. Ref. No. 88A-0014, appro. Ref. No. 89A-0367) and for relocation of entrance to existing house on adjoining site at Springvale, Edmondstown Road, Ballyboden for Dunboden Estates Ltd.

CONDITIONS

REASONS FOR CONDITIONS

- 13. That a financial contribution in the sum of £800 per house be paid by the proposer to the Dublin County Council towards improvements to the distributor road network in the area of the proposed development which will facilitate this development; this contribution to be paid before the commencement of development on the site.
- space shall be landscaped in accordance with Drawing No. E104/205 submitted as part of the planning application. The open space shall be available for use by residents on completion of theredwellings. The open space areas shall not be used for the purpose of site compounds or for storage of plant, materials or spoil during the course of construction, on when I for the purpose of site construction, on when I for the purpose of site construction, on when I for the purpose of construction, on when I for the purpose of construction.
- 13. The provision of such services in the area by the Council will facilitate the proposed development. It is considered reasonable that the developer should contribute towards the cost of providing the services.
- 14. To preserve the amenities of the area.

construction, on when I fee free being checkful by the afflicant frame and calculate the work to come of (ii) In live of open space development to the contribution of £300/house to be faithful as a spread with the provided to the Country Council.

15. Additional tree planting using Ash and Oak shall be carried out alongside the river bank. Details to be submitted to the Planning Authority for written agreement prior to development commencing.

15. In the interest of the proper planning and development of the area.

Record of Executive Business and Manager's Orders

Proposed revised development of 41 houses on 5.6 acre site of previously approved developments (O.P. Ref. No. 88A-0014, appro. Ref. No. 89A-0367) and for relocation of entrance to existing house on adjoining site at Springvale, Edmondstown Road, Ballyboden for Dunboden Estates Ltd.

CONDITIONS

REASONS FOR CONDITIONS

- 16. (A) Prior to the commencement of development trees scheduled for retention shall be protected by means of stout timber fence 1.5 m. high (as indicated on Drawing No. E104/205). This fence shall enclose the area covered by the branch spread of trees and shall be maintained in good condition throughout the period of development. The areas so fenced off shall not be used for storage, dumping or for any purpose which would jeopardise the health of the trees.
 - (B) No underground services, roadways, pathways or carparking areas shall be provided beneath the row of Scots Pine scheduled for retention located to the east of house nos. 22-29. This may require the relocation of the proposed surface water sewer and manholes and S13 and S7. This matter to be subject of prior discussion and written agreement of the Planning Authority.
 - 17. That access details (including carriageway width on bridge and alignment at proposed junction) are to be agreed with the Roads Department prior to the commencement of development.
 - 18. That screen boundary walls 2 metres high with brick capping are to be provided in the following locations:—
 (i) along the side boundaries of sites nos. 41, 21 29, to the rear of the proposed houses (ii) along the rear site boundaries of houses nos. 29 and 28.

16. In the interest of the proper planning and development of the area.

- 17. In the interest of the proper planning and development of the area.
- 18. In the interest of the proper planning and development of the area.

Record of Executive Business and Manager's Orders

Proposed revised development of 41 houses on 5.6 acre site of previously approved developments (O.P. Ref. No. 88A-0014, appro. Ref. No. 89A-0367) and for relocation of entrance to existing house on adjoining site at Springvale, Edmondstown Road, Ballyboden Dunboden Estates Ltd.

CONDITIONS

REASONS FOR CONDITIONS

- 19. That front boundary walls are to be These walls are not to exceed 1.2 metres in height, and are to have a brick finish and be properly capped.
- 19. In the interest of the proper planning development of the area.
- 20. That the following Development Plan requirements are to be adhered to in this development:-
- 20. In the interest of the proper planning and development of the area.
- (i) all gardens to be a minimum of 10.7 metres in length, as measured from_main external wall;
- (ii) that all driveways be a minimum of 7.5 metres long;
- (iii) that a 2.3 metre distance be maintained between flank walls of pairs of semi-detached houses and between site 1 and houses on site 2/3.

 (iv) that a 2 metre distance be maintained between the flank walls of between the flank walls of
- house nos. 21 and 29 and the side site boundaries.

An accurate and detailed site plan (1:500 scale) showing precise house sizes (with measurements) and showing compliance with all the above standards, to be submitted for the agreement of the Planning Authority prior to commencement of development.

applicant should note that complying with the above Development Plan Standards may require a reduction in the size of some of the houses.

Record of Executive Business and Manager's Orders

Proposed revised development of 41 houses on 5.6 acre site of previously approved developments (O.P. Ref. No. 88A-0014, appro. Ref. No. 89A-0367) and for relocation of entrance to existing house on adjoining site at Springvale, Edmondstown Road, Ballyboden for Dunboden Estates Ltd.

CONDITIONS

REASONS FOR CONDITIONS

- 21. That the front boundary wall of the site along Edmondstown Road is to be repaired in stone to match the existing wall. In this regard existing blockwork is to be removed and gaps filled in. The proposed new front boundary wall is to be constructed of stone to match the existing wall. The existing stone wall is to be extended across the existing entrance to the site.
- 22. (a) That the water supply and drainage arrangements, including the disposal of surface water, be in accordance with the requirements of the County Council:

The applicant should note that these arrangements must cater for the proposed Dublin corporation watermain and scour pipe. (b) No work is to commence on site until the foul sewer at Ballyboden Road has been duplicated at a cost of approximately £125000 which work will require to be carried out by the County Council at the expense of developers in the Catchment Area.

23. Applicant to ensure the stability of the bank to the rear of houses nos.

1-21. A retaining wall will be required to be constructed. Prior to the commencement of development, the applicant is to submit detailed proposals designed to ensure the stability of the bank and to include cross sections across the site in the vicinity of dwelling nos. 1-21 for the written agreement of the Planning Authority. The proposals to be certified by a chartered structural engineer.

21. In the interest of the proper planning and development of the area.

22. In order to comply with the Sanitary Services Acts 1878-1964.

23. In the interest of the proper planning and development of the area.

... .

Record of Executive Business and Manager's Orders

Proposed revised development of 41 houses on 5.6 acre site of previously approved developments (O.P. Ref. No. 88A-0014, appro. Ref. No. 89A-0367) and for relocation of entrance to existing house on adjoining site at Springvale, Edmondstown Road, Ballyboden for Dunboden Estates Ltd.

CONDITIONS

REASONS FOR CONDITIONS

- 24. The proposed diversion of the culverted stream adjacent to house no. 1 indicated on drawing no. 101 submitted as Additional Information on 8th August, 1991, shall be carried out prior to the commencement of development on the site. Details of the proposed treatment of the outfall of the diverted stream as well as pipe size, and the exit and entry of this pipeline are to be submitted to the Planning Authority for its written agreement prior to the commencement of development on the site.
- 25. Prior to the commencement of development on the site the applicant is to determine from Dublin Corporation the location of the proposed 600 mm. scour pipe. The applicant is to combine the internal surface water system into a single outfall incorporating the Dublin Corporation scour pipe to discharge to the adjoining river. The outfall to be located at the wing walls associated with the bridge. The wing walls are to have a stone facing to match the bridge. The applicant to submit details showing compliance with this condition to the Planning Authority for written agreement prior the commencement of development on the site.
- 26. Prior to commencement of development on the site the applicant is to submit structural details of the proposed bridge and river traning walls, certified by a chartered structural engineer to the Planning Authority for its written agreement.

24. In the interest of the proper planning and development of the area.

25. In the interest of the proper planning and development of the area.

26. In the interest of the proper planning and development of the area.

Record of Executive Business and Manager's Orders

Proposed revised development of 41 houses on 5.6 acre site of previously approved developments (O.P. Ref. No. 88A-0014, appro. Ref. No. 89A-0367) and for relocation of entrance to existing house on adjoining site at Springvale, Edmondstown Road, Ballyboden for Dunboden Estates Ltd.

CONDITIONS

REASONS FOR CONDITIONS

- 27. That prior the commencement of development the design of the river traning wall downstream of the proposed bridge is to be revised to shown the foundations lowered to below the bed level of the river. The applicant is also to revise the design to show wing walls splayed at an angle of 45 degrees. The applicant is to submit details showing compliance with this condition to the Planning Authority for its written agreement prior to the commencement of development on the site.
- 28. That the foundations of the abutments to the bridge are to be extended to meet under the RIver bed. The applicant is to submit details showing compliance with this condition to the Planning AUthority for its written agreement prior to commencement of development.
- 29. Finished floor levels of houses nos. 30-41 to be submitted and agreed with the Planning Authority, in writing, prior to the commencement of development. Proposed finished floor levels should ensure that overlooking of any proposed development on the adjoining site is minimised. The applicant is to submit details showing compliance with this condition to the Planning Authority, for its written agreement, prior to the commencement of development.

27. In the interest of the proper planning and development of the area.

28. In the interest of the proper planning and development of the area.

29. To minimise any overlooking. A discrepancy of 1-2 metres is noted in the contours shown for this site vis a vis the contours shown for the adjoining "Rookwood" site under Reg. Ref. 91A/0946.

Record of Executive Business and Manager's Orders

Proposed revised development of 41 houses on 5.6 acre site of previously approved developments (O.P. Ref. No. 88A-0014, appro. Ref. No. 89A-0367) and for relocation of entrance to existing house on adjoining site at Springvale, Edmondstown Road, Ballyboden for Dunboden Estates Ltd.

CONDITIONS

REASONS FOR CONDITIONS

- 30. That the proposed bridge and wing walls to the bridge as well as any proposed retaining wall are to have a stone facing.
- 31. The applicant to pay a special contribution of £2000/acre in respect of connection to the Rockbrook Sewer on Edmondstown Road.
- 32. That development of house nos. 28-41 and the access road serving these houses shall not proceed until the sections of the proposed Dublin Corporation 1000 mm. watermain and 600 mm. scour pipe are constructed by Dublin Corporation of unless otherwise agreed with the Planning Authority.
- 33. That the hammerheads at the end of roads 'A' and 'C' measure 12 x 9 metres.
- 34. Heating to be provided by the use of either oil, gas, electricity or by smokeless fuels in fireplaces or appliances suitable only for burning solid smokeless fuels.
- The applicant is advised to consult with the Sanitary Services Department prior to lodging compliance submissions as required by conditions nos. 23-29 inclusive of this decision.

- 30. In the interest of visual amenity.
- 31. It is considered reasonable that the applicant should bear some of the cost of the construction of this sewer which facilitates proposed development.
- 32. In the interest of The proper planning and development of the area.
- 33. In the interest of the proper planning and development of the area.
- 34. In the interest of reducing air pollution.

85: No development to commence on file 35. The of feeling of the fal saver on the a contribution of \$125,000 his been on Bollybodie Het is required lafted with the flowing fathenty towards to the fall some the court of the following the feel sever area indisability the all the of Bolly bodien hoard the four sever area indisability of the affection.

Record of Executive Business and Manager's Orders

Proposed revised development of 41 houses on 5.6 acresite of previously approved developments (0.P. Ref. No. 88A-0014, appro. Ref. No. 89A-0367) and for relocation of entrance to existing house on adjoining site at Springvale, Edmondstown Road, Ballyboden for Dunboden Estates Ltd.

Auveen Byrne & Assocs., Lioscarran House, 32, Dale Road, Kilmacud, Stillorgan, Co. Dublin.

Reg. Ref. 91A-0446
Appl. Rec'd: 26.03.1991
Time Ext. let. rec'd: 14.10.1991
Time Ext. up to: 18.10.1991

Report of the Dublin Planning Officer, dated 14 October 1991

This is an application for PERMISSION revised development of 41 houses on 5.6 acre site of previously approved developments (0.P. Ref. No. 88A-0014, appro. Ref. No. 89A-0367) and for relocation of entrance to existing house on adjoining site at Springvale, Edmondstown Road, Ballyboden.

In accordance with Section 26(4A) of the Local Government (Planning and Development) Act, 1963, as amended by Section 39(F) of the Local Government (Planning and Development) Act, 1976, the applicant has furnished his consent in writing to the extension by the Council of the period for considering this application within the meaning of subsection (4A) of Section 26, up to and including 18th October, 1991.

I recommend that the period to be extended accordingly.

Reason: To facilitate full consideration of the application.

for Principal Officer

Order:

A decision pursuant to Section 26(4A) to extend the period for considering the application as recommended is hereby made.

Dated:

/ October, 1991.

to whom the appropriate powers have been delegated by order of the Dublin City and County Manager dated (L. Coctober, 1991.

NOTE:

I have checked that the necessary entry has been made recording details of the period as extended.

SENIOR STAFF OFFICER

Order No. P/4668/91

COMHAIRLE CHONTAE ATHA CLIATH

Record of Executive Business and Manager's Orders

Proposed revised development of 41 houses on 5.6 acre site of previously approved development (O.P. Ref. No. 88A-0014, appro. Ref. No. 89A-0367) and for relocation of entrance to existing house on adjoining site at Springvale, Edmondstown Road, Ballyboden for Dunboden Estates Ltd.

Auveen Byrne & Associates, Lioscarran House, 32, Dale Road, Kilmacud, Stillorgan, Co. Dublin.

Reg. Ref. 91A-0446 Appl. Rec'd: 26.03.1991 Time Ext. let. rec'd: 07.10.

Time Ext. let. rec'd: 07.10.1991 Time Ext. up to: 14.10.1991

Report of the Dublin Planning Officer, dated 7 October 1991

This is an application for PERMISSION for revised development of 41 houses on 5.6 acre site of previously approved development (0.P. Ref. No. 88A-0014, appro. Ref. No. 89A-0367) and for relocation of entrance to existing house on adjoining site at Springvale, Edmondstown Road, Ballyboden.

In accordance with Section 26(4A) of the Local Government (Planning and Development) Act, 1963, as amended by Section 39(F) of the Local Government (Planning and Development) Act, 1976, the applicant has furnished his consent in writing to the extension by the Council of the period for considering this application within the meaning of subsection (4A) of Section 26, up to and including 14th October, 1991.

I recommend that the period to be extended accordingly.

Reason: To facilitate full consideration of the application.

for Principal Officer

Order: A deci

A decision pursuant to Section 26(4A) to extend the period for considering the application as recommended

is hereby made.

Dated:

74 October, 1991.

Assistant City and County Manager.

to whom the appropriate powers have been delegated by order of the Dublin City and County Manager dated 4th October, 1991.

NOTE:

I have checked that the necessary entry has been made recording details of the period as extended.

SENIOR STAFF OFFICER.

contail vines a Shown on Site Survey do not MATER up with contour unt shower on 91n 0976. F. Fleurs or House 30-41 are between 89.5 - 86.3 prop: F. F. hence ax Hours 52 153 (91A 976) on Raskussod set one stated as. 84.6 m.

3/00 1991 to Byene consumed (PHONE Call 3/10/9/ that the ana of fart to the real of HE . nos 1-21 = see of paceluded part the welcoment applic. x included i the cartiel applic AS your of the 489A 0367 is withe applican oundedup.

REG. REF:

91A/12 446.

DATE LODGED:

8/8/91

LOCATION:

Springvale, Edmonstown Road, Ballyboden.

APPLICANT:

Dunboden Estates Limited

PROPOSAL:

Revised Development for 44 houses.

FOUL SEWER:

Not available.

1) Unless a special levy of fl25,000 is paid in order to upgrade the Ballyboden Road sewer. The required works are between M.H. 526 and M.H. 344 on the County Council Foul Sewer Record Sheet 22/10.

Note: A number of developments to contribute to this levy. See letter 30/1/91 of Mr. F. Coffey, Senior Engineer, Drainage Design to Mr. Simon Clear of An Bord Pleanala. This letter has been sent to Mr. D. Drumgoole.

- 2) A levy of £2,000/acre for the construction of the Rockbrook sewer to be paid by the developer.
- 3) Details of the protection to the sewer in the vicinity of proposed manholes F1 and F2 and at all areas where the cover is less than 1.0 metres to be submitted. The details of the connection to the main foul sewer to be submitted.
- 4) The internal drainage system to be revised so that not more than 6 houses are draining to any combined drain.

SURFACE WATER:

Refusal Recommended.

- 1) Applicant has not indicated the measures necessary to ensure the stability of the bank at the rear of house Nos. 1 21. Any future proposals to incorporate treatment for subsoil drainage in this area.
- 2) The structural details of the proposed bridge, river training walls and any proposal retaining wall behind house nos. 1 21 to be certified by a chartered engineer.
- 3) The foundation of the proposed river training wall downstream of the proposed bridge to be lowered to be below the invert level of the river. The west wing-wall on the upstream side of the proposed bridge to be splayed at 45°.



- 4) The invert level of the concrete floor of the proposed bridge to be lowered to the foundation level of the bridge.
- 5) The pipe size of the proposed culvert at the southern boundary of the site to be submitted. Details of the exit and entry of this pipeline to be submitted.
- 6) The proposed internal surface water system to be combined to have a single outfall. Details of this outfall to be submitted. Where cover to the internal pipe network is less than 1.0 m, 150 mm concrete surround to be incorporated as protection to pipe.

N. Murphy E.E.

Endorsed:

C. Obtrey,

Senior Engineer.

PLANNING DEPT. DEVELOPMENT CONTROL SECT Register Reference : 914 446

Date : 16 8 91

ENDORSED DATE

WATER SUPPLY.

Woher available from existing men melannsbown de noi 24 hr storage regd Hivlelanger

ENDORSED 77677 DATE 17/9/91

PLANNING DEPT.

DEVELOPMENT CONTROL SECT

Time

25-09:91

Dublin CorporationBardas Átha Cliath



ENGINEERING SERVICES

WATERWORKS, 68/70 MARROWBONE LANE, DUBLIN 8

534849

TELEPHONE 543444 FAX 534849

Our Fef: JB.FT10911

2nd October, 1991.

Ms. M. O'Shoe, Planning Department. Dublin County Council, Irish hite Centre, Lower Abbey Street.

RE:- Planning Application for proposed homing at Springvale, Ballyboden - Ref. 91A/446 Drawing No. 41A dated 27/6/91.

real Mr. 5'Sime,

- 1. This Division has no objection to the layout as shown on Drawing No. 41A dated 27/6/91. As agreed with the developer Dublin Corporation's proposed 1000 mm watermain and 600 mm overflow pipeline are to be constructed in roadway fronting house nos. 30 to 41 on layout Drawing No. 41A dated 27/6/91.
- 2. Development of house nos. 28 to 41 should not proceed until these sections of 1000 mm watermain and 600 mm overflow pipeline are constructed by Dublin Corporation. Dublin Corporation estimate that this work can be completed within in the Theorem. The programme for this work to be agreed with the loper.

Chimbfally,

M. Phillips,

A/DIVISIONAL ENGINEER.

Dublin Corporation



ENGINEERING SERVICES

WATERWORKS, 68/70 MARROWBONE LANE, DUBLIN 8

> TELEPHONE 543444 FAX 534849

Our Ref: JB.PT10911

2nd October, 1991.

Ms. M. O'Shee, Planning Department. Dublin County Council, Irish Life Contre, Lower Abbey Street.

RE:- Planning Application for proposed housing at Springvale, Ballyboden - Ref. 91A/446 Drawing No. 41A dated 27/6/91.

Dear Ms. O'Shee,

- 1. This Division has no objection to the layout as shown on Drawing No. 41A dated 27/6/91. As agreed with the developer Dublin Corporation's proposed 1000 mm watermain and 600 mm overflow pipeline are to be constructed in roadway fronting house nos. 30 to 41 on layout Drawing No. 41A dated 27/6/91.
- 2. Development of house nos. 28 to 41 should not proceed until these sections of 1000 mm watermain and 600 mm overflow pipeline are constructed by Dublin Corporation. Dublin Corporation estimate that this work can be completed within 9 months. The programme for this work to be agreed with the

itels factorially,

.. M. Phillips, W ,A/DIVISIONAL ENGINEER.

Record of Executive Business and Manager's Orders

Proposed revised development of 41 houses on 5.6 acresite of previously approved developments (O.P. Ref. No. 88A-0014, appro. Ref. No. 89A-0367) and for relocation of entrance to existing house on adjoining site at Springvale, Edmondstown Road, Ballyboden for Dunboden Estates Ltd.

Auveen Byrne & Associates, Lioscarran House, 32, Dale Road, Kilmacud, Stillorgan, Co. Dublin. Reg. Ref. 91A-0446
Appl. Rec'd: 26.03.1991
Floor Area: 5.6 acres.
Zoning:

Report of the Dublin Planning Officer, dated 17 May 1991

This is an application for PERMISSION. The proposed development consists of revised development of 44 houses of 5.6 acre site of previously approved development (Reg. Ref. 88A-0014 and 89A-0367) and for relocation of entrance to existing house on adjoining site at Springvale, Edmondstown Road, Ballyboden for Dunboden Estates Ltd.

The planning history of the site is as follows:

Reg. Ref. 88A-0014 - Outline planning permission was granted for 32 houses on 5.6 acre site at Springvale (Decision order P/1795/88 dated 9th June, 1988).

Reg. Ref. 89A-0367 - Planning approval was granted for 32 houses on 5.5 acre site at Springvale and the relocation of access to existing residence on adjoining site (Ref. PL 6/5/79448 dated 18th January, 1990).

The present proposal consists of 44 no. houses resulting in a density of 7.8 houses per acreaging.

The proposal seeks to increase the number of houses on the site by 12 when compared with the approved layout.

The proposed housing layout is similar to the approved layout. In a covering letter submitted as part of the application it is stated that the same area of land is to be reserved as public open space.

The proposed house types are smaller than those approved under Reg. Ref. 89A-0367, in response to a change in market demands.

It is noted that an area of land to the rear of house nos. 1-23 adjoining the ONCHARD and the area of land accommodating a new driveway to the existing house are no longer included as part of the site as was the case in the earlier application lodged under Reg. Ref. 89A-0367. In a Not program of the longer of the opposite of the control of the contr

(Continued)

Record of Executive Business and Manager's Orders

Proposed revised development of 41 houses on 5.6 acre site of previously approved developments (O.P. Ref. No. 88A-0014, appro. Ref. No. 89A-0367) and for relocation of entrance to existing house on adjoining site at Springvale, Edmondstown Road, Ballyboden for Dunboden Estates Ltd.

(Continued)

It is also noted that the proposed house plans submitted are for semidetached houses, while the housing layout shows terraced housing. Furthermore, the house plans indicate a larger house than is shown on the site layout.

I understand that the applicant has submitted in error the wrong site plan, as part of this application, and the correct site plan would have shown 41 no. houses (40 semi-detached and 1 detached).

A letter has been received on behalf of an adjoining land owners who maintains that the site outlined in the site location map includes part of their site. This area of land is not included in the site layout plan submitted. The applicant should be asked to clarify this

discrepancy.

A lettil of Copital totte Proposed descipant Pleased on behalf of a notation for the Sanitary Services report dated 15th May, 1991, that foul sewer is not available unless financial contributions are made towards the upgrading of the Ballyboden Road sewer, and the cost of the Rockbrook Sewer. Details of the sewer crossing the Owendoher River are required to be submitted. The Sanitary Services Engineer recommends that additional information be requested in relation to a number of items, including structural details (including scaled drawings) of the proposed bridge, river teaking wall, new boundary wall and any proposed retaining walls behind house nos. 1-21 and the stability of the back back there. A letter of clarification for the structural design of the structures from a Chartered Engineer would also be required.

Water is available to serve the proposed development from an existing main in Edmondstown Road. A supplementary report from the Waterway division of the Sanitary Services Department (letter dated 16th May, 1991) has been noted. The applicant Should be related the proposed waterways on the Stell. The Roads and Parks Departments reports have been noted. Before a decision is made on this application,

I recommend that ADDITIONAL INFORMATION be requested from the applicant with regard to the following:-

(Continued)

Record of Executive Business and Manager's Orders

Proposed revised development of 41 houses on 5.6 acre site of previously approved developments (O.P. Ref. No. 88A-0014, appro. Ref. No. 89A-0367) and for relocation of entrance to existing house on adjoining site at Springvale, Edmondstown Road, Ballyboden for Dunboden Estates Ltd.

(Continued)

1. The applicant is requested to indicate if he is willing to modify the proposed layout to show the provision of semi-detached houses, instead of terraced housing, and if so to submit a revised site layout showing this change.

It should be noted that there is a discrepancy noted between the size of the proposed houses as shown on the floor plans and the size of the houses as shown on the site layout. This discrepancy should be rectified and the applicant should demonstrate that Development Plan Standardswith regard to space around dwellings can be met.

- 2. The applicant is requested to clarify the site boundaries. It is noted that the site as shown on the site location map differs from that shown on the site plan. In particular the applicant is requested to clarify its interest in that portion of the site (i.e. the north east corner of the site) shown as part of the site on the site location map and excluded from the site on the site plan.
- 3. The applicant is requested to submit a letter from a chartered structural engineer certifying the stability of the bank to the rear of houses nos. 1-23.
- 4. The applicant is requested to submit structural details (including scaled drawings) of the proposed bridge, river training wall, proposed new boundary wall and any proposed retaining walls behind houses nos. 1-23, together with a letter of certification for the structural design of these structures from a Chartered Engineer.
- 5. The applicant is requested to submit a longitudinal section of the existing bed level of the river upstream and downstream of the proposed development.
- 6. The applicant is requested to show the provision of a 5 metre distance between the culverted stream on the south boundary of the site and the nearest house.
- 7. The application is requested to confirm that the finished floor levels of houses nos. 1-23 to be at least 0.3 m above the highest recorded flood levels of the stream. The applicant is also requested to submit a letter of certification from a Chartered Engineer demonstrating the stability of the house closest to the stream.

1

(Continued)

Record of Executive Business and Manager's Orders

Proposed revised development of 41 houses on 5.6 acre site of previously approved developments (O.P. Ref. No. 88A-0014, appro. Ref. No. 89A-0367) and for relocation of entrance to existing house on adjoining site at Springvale, Edmondstown Road, Ballyboden for Dunboden Estates Ltd.

(Continued)

Dublin Corporation have scheduled improvement works to the 8. watermain infrastructure in the area. These works include the laying of a 1,000 mm. diameter watermain from Ballyboden Reservoir to Stillorgan Reservoir and the laying of a 600 mm. diameter scour watermain from Ballyboden Reservoir to the Owendoher River. both of these mains are scheduled to traverse this site.*

The Applicant is requested to submit information indicating how these works can be accommodated within the proposed housing layout. The applicant should note that both mains will require ready access and carry with them a sterilized wayleave of 20 metres total width each. The applicant is advised to consult with the Sanitary Services Department Water Division prior to submitting this information.

9. The applicant is requested to subtrict are acceptable (MOS/DK) detail per the Seuce accessing of the overdoher line ichard Cramins For Dublin Planning Officer 20.5.91 Endorsed for Principal Officer

I direct that ADDITIONAL INFORMATION be requested from Order:the applicant for planning permission as set out in the above report and that notice thereof be served on

the applicant. ₩ay, 1991. Dated:

Assistant City and County Manager to whom the appropriate powers have been delegated by Order of the Dublin City and County Manager, dated 26th April, 1991.

DUBLIN COUNTY COUNCIL

PLANNING AND BUILDING CONTROL DEPARTMAENT

Senior Engineer, Sanitary Services Dept.

Register Reference : 91B/0446

Date : 24th April 1991

Development : Two storey extension at rear

LOCATION : 50 Sycamore Road, Mount Merrion

Applicant : H. O'Brien

App. Type : PERMISSION/BUILDING BYE-LAW APPROVAL

Planning Officer:

Date Recd. : 23rd April 1991

WATER SUPPLY.....

AND TO SOUTH TO CONTINUE TO THE TOTAL TOTAL CONTINUES. ADGULATIONS AND REQUIREMENTS.

ENDORSED MER My Kenna DATE 12-6-91

PLANNING DEPT. DEVELOPMENT CONTROL SECT Date 27.06.91


RECEIVED


2 4MAY 1991

RECEIVED WATERWORKS D""918N

0 3 JUN 1991

STILLORGAN WATERWORKS

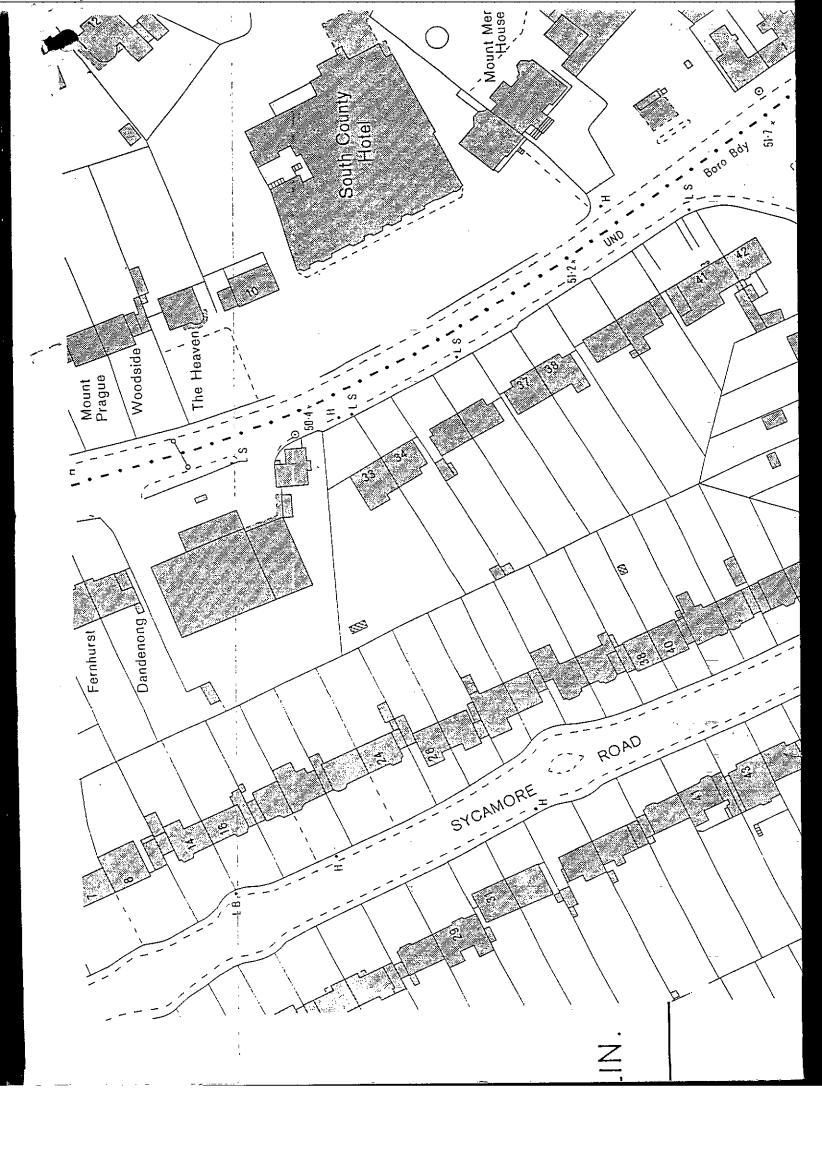

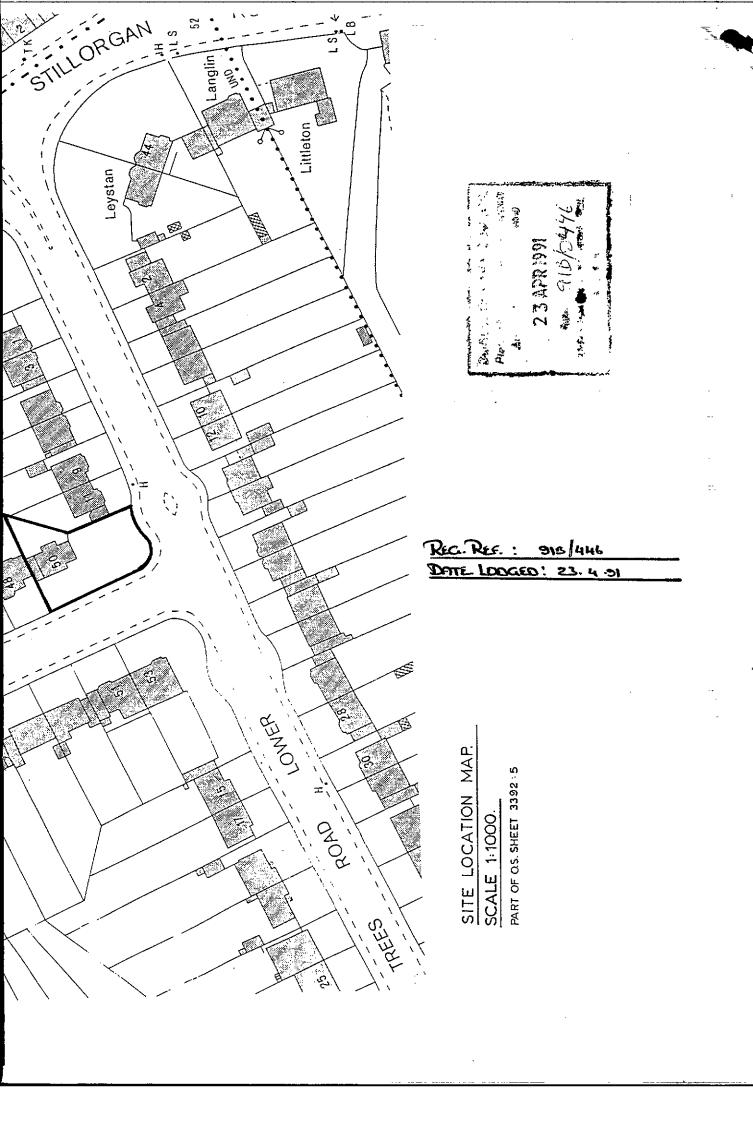

15-MAY-1991 14:27	F.US EPT.
1.0,15)	DUBLIN COUNTY COUNCIL DEVELOPMENT CONTROL SECTION OF THE PROPERTY CONTROL SECTION OF THE PROP
	DUBLIN COUNTY COUNCIL 91A/446. DEVELOPMENT CONTROL
REG. REF:	91A/446. DEV. 14
LOCATION:	"Springvale," Edmondstown Rd, Ballyboden Date
	Time
APPLICANT:	Dumboden Estates Ltd.
Proposal:	Rev. of 33 houses on 5.6 acre site of previously approved development.
DATE LODGED:	26.3.91.
89A/367 on 18th Jan Current application layout is similar t	is for 44 units of a smaller size on this site. The proposed o that previously approved.
	ing contemplated it should be subject to:-
of 18th January area. The cont of January 1990 Price Index-Building Statistics Office to the developer to Du	of £800 per house as per Condition 13 of An Bord Pleanala decision 190 towards improvements to the distributor road network in the cribution to be the sum of money equivalent to £800 per house as and Index linked and updated in accordance with the Wholesale and Construction (Capital Goods) as published by the Central to the value pertaining at the time of payment shall be paid by ablin County Council towards the cost of road improvements and proposals in the area serving this site.
Access details to development (incomputation).	to be agreed with the Roads Department prior to commencement of luding carriageway width on bridge and alignment at proposed
Building Control	ining walls, bridge and paths to be agreed with Sanitary Services land Roads Department prior to commencement of development. This le bridge railings and approaches etc.
4. Details of Edmo	ondstown Road boundary treatment pedestrian provision etc. to be Planning Authority prior to commencement of development.
• • •	
EM/BMcC 15.5.91.	

ENDORSED:

DATE:

SIGNED:

DATE:

TOTAL P.06

Parks Department





Bosca 174 P. O. Box 174 5 Rae Gardiner, 5 Gardiner Row, Baile Atha Cliath 1, Dublin 1. Telephone. (01)727777 Fax. (01)727530

Mr. D. Drumgoole, Senior Administrative Officer, Planning Department, Dublin County Council.

Our Ref.

Your Ref.

Date

08.05.1991_

Application for 44 No. Houses at Springvale, Edmonstown Road, Ballyboden. Reg. Ref. 91A/446. RE:

With regard to this application, the Parks Department's comments are;

1) This application is for 44 No. houses, which represents an increase of 12 No. houses on the previous grant of permission (89A/367 PL 6/5/79448), however; the applicant shows no additional public open space. In this regard, it is considered essential that the applicant be requested to pay a financial contribution of £1,000 per additional house (f12,000) towards the provision and development of Class I public open space in the area.

The applicant be requested to adhere to the conditions of 2) the An Bord Pleanala decision (PL 6/5/79448). Furthermore, the applicant should submit and agree proposals for street DEVELOPMENT CONTROL SEC. 14.4.91..... tree planting.

SENIOR PARKS SUPERINTENDENT

Water Division

MO'S

Mr. R. Cremins, E.E.D.C., Planning Department. JC/RMCG

16th May, 1991.

I refer to our discussions re: the Springvale application and consider that the following paragraph should be included in your request for additional information.

Dublin Comporation have scheduled improvement works to the watermain infrastructure in the area. These works include the laying of a 1,000 mm diameter watermain from Ballyboden Reservoir to Stillorgan Reservoir and the laying of a 600 mm diameter scour watermain from Ballyboden Reservoir to the Owendoher River. Both of these mains are scheduled to traverse this site. Applicant should forward information to indicate how these works will be accommodated within his housing layout. It should be borne in mind that both mains will require ready access and carry with them a sterilized wayleave of 20 metres total width each."

James V. Cleary, S.E.E.

PLANNING DEPT.

DEVELOPMENT CONTROL SECT

Date

Time

DAG

P. 102

this would rque 10 M. Wayreaux

lin County Council Comhairle Chontae Atha Cliath

Engineering Department Sanitary Services Section



Bosca 174 P. O. Box 174 46 / 49 Sraid O'Connaill Uacht, 46 / 49 Upper O'Connell Street, Baile Atha Cliath Dublin 1,

Telephone: (01)727777 Fax. (01)727434

FAX TRANSMISSION

DATE:	16/5/91 TIME:
FROM:	Geff Guntly.
101	Marjorie 0'Shae.
HUMBER OF	PAGES TO FOLLOW:
COMMENT:	
	and the state of

Register Reference : 91A/0446

Date : 12th April 1991

ENDORSED	DATE			5
WATER SUPPLY			, <u></u>	******
WATER SUPPLY Water available in closed Llowation a A officate pri	e to same this	Aronch com	actions	tioffings
Monton a	I sabbug	to be corried	and by	Jullen Co Co
s officets pri	or expense.	ga 1800	5 ~ 7	
		1 13/5/1	,	

ANDORSED THE BEST OF THE PROPERTY OF THE PROPE

DATE LODGED:

REG. REF:

91A/0466

LOCATION:

Springvale, Edmondstown Road, Ballyboden.

APFLICANT:

Duntoden Estates Limited.

PROPOSAL:

Revised Development for 44 hosues.

FOUL SEWER: - Not Available.

1. Unless a special levy of £125,000 is paid in order to upgrade the Ballyboden Road sewer. The required works are between MH.526 and MH.344 on the County Council Foul Sewer Record Sheet 22/10. Make 3 Annales of Meridian to County Council Foul Sewer Record Sheet 22/10. Make 3 Annales of Meridian County Council Foul Sewer Record Sheet 22/10. Make 3 Annales of Meridian County Council Foul Sewer Record Sheet 22/10. Make 3 Annales of Meridi

Rockbrook sewer which serves this development.

- 3. An acceptable detail for the sewer crossing of the Owendoher River to be submitted. Details for the protection of this sewer at proposed manholes F1 and F2 and at all areas where cover is less than 1.0 metres to be submitted.
- 4. All main internal sewers to be 225mm diameter. The detail of the connection to the existing sewer on Rockbrook Road to be submitted.

SURFACE WATER: - Additional Information is required.

- 1. A longitudinal section of the existing bed level of the river upstream and downstream of this proposed development to be submitted. The invert level of the proposed floor of the culvert to be agreed with Sanıtary Services.
- 2. The foundations of the proposed bridge abutments and river traning wall, to be lowered so that the top of foundation is 1.0m below the existing bed level of the river or as required by (1) above.
- 7. The stability of the bank to the rear of house No's 1 21 should be specifically certified by a qualified engineer.
- 4. The formation level of the proposed boundary wall north of the proposed bridge entry to be lowered by 1.0m or as required by (1) above, a letter from a chartered structural/civil engineer certifying the integrity of this proposal to be submitted.

<u>, Î</u>

. *****

- 5. The structural details (including detailed scaled drawings) of the proposed bridge, river training wall, new boundary wall and any proposed retaining walls behind house No's 1 21 to be submitted to the satisfaction of Building Control Section together with a letter of certification for the structural design of these structures from a chartered engineer.
- 6. The floor levels of house No's 1 21 to be at least 0.3m above the highest recorded flood level.
- 7. Rock armour, where shown to be a minimum of 500mm cube and the upstream entry wing-walls to the bridge to be splayed to prevent scour.
- 8. Surface water outfall details to be submitted.
- 9. The ditch along the southern boundary to be piped to cater for 170 1/s.

N. Morphy Engineer.

Trois paeda

Jenior Engineer

11/4/91

J. Rong avecus Byene. Hoday
11/4/a1. Se great to writedrew unsortedred
A. I. Substitut P await Request for
Uniformentus under Saction 22. I tot
un transed for that time acterisian
Would be Boquered

11/4/21

OS APR 1991

PX



AUVEEN BYRNE & ASSOCIATES,

Consultant Town Planners,

Lioscarren House, 32 Dale Road, Kilmacud, Stillorgan, Co.Dublin, Telephone: (01) 831611, Facsimile: (01) 889747.

The Principal Officer, Planning Department, Dublin County Council, Block II, Irish Life Centre, Lower Abbey Street, Dublin 1

16/14.

11 April 1991

Re: Dublin County Council Ref. No. 91A/0446
Application for permission for revised housing development
on 5.6 acre site of previously approved development (O.P.
Ref. No. 88A/0014, Appro. Ref. No. 89A/0367) and relocation
of entrance to existing house on adjoining site at
Springvale, Edmondstown Road, Ballyboden.

Dear Sir,

I refer to correspondence of 05.04.91 lodged by this office with your Department and enclosing corrected drawings in relation to the above.

Following discussions with your good selves, I now wish to withdraw the said submission. I await your communication.

Yours faithfully,

AUVEEN BYRNE

1 2. APR 91

91A-0446

Mr. Gerald Cantan, Architect, 84, Lower Dodder Road, Dublin 14.

14 December 1992

Re:

Proposed 41 houses and relocation of entrance at Springvale, Edmondstown Road, Ballinteer for Dunboden Estates Ltd.

Dear Sir,

I refer to your submission received on 29th January, 1992, to comply with Conditions No. 11, 18, 20 and 29, of decision to grant permission by Order No. P/4861/91, dated 17th October, 1991, in connection with the above.

In this regard, I wish to inform you that the submissions made to comply with condition nos. 11, 18 and 29 are acceptable.

The submission lodged in relation to condition no. 20 is acceptable subject to the following:

1. Houses nos. 1 and 22-30 (inclusive) are to have driveways which are 7.5 metres (minimum) in length and gardens which are 10.7 metres (minimum) as measured from the main external wall of the house.

NOTE: Complying with (1) above may require a slight reduction in the size of the proposed houses on these sites and this is acceptable to the Planning Authority.

Your attention is drawn to the fact that compliance submissions are still outstanding with regard to conditions nos. 15, 16(b), 23, 24, 25, 26, 27 and 28 of decision order P/4861/91 dated 17th October, 1991.

Yours faithfully,

for Principal Officer.

COMHAIRLE CHONTAE ÁTHA CLIATH

Record of Executive Business and Manager's Orders

SOUTH COUNTY DUBLIN

41 houses and relocation of entrance at Springvale, Edmondstown Road, Ballinteer for Dunboden Estates Ltd.

Gerald Cantan, Architect, 84 Lower Dodder Road, Dublin 14. Reg. Ref. 91A/446 COMP. REC'D: 29.01.92

Report of the Dublin Planning Officer, dated 3 November 1992.

This is a submission for COMPLIANCE with Conditions No. 11, 18, 20 and 29 of decision to Grant Permission by Order No. P/4861/91, dated, 17th October, 1991, in connection with the above.

Condition No. 11 states:-

"That an acceptable street naming and house numbering scheme be submitted to and approved by the County Council before any constructional work takes place on the proposed houses".

It is stated that the development will be named "Springvale" and that the houses will be numbered 1-41 as indicated on drawing 579/41C (the enclosed drawing is in fact numbered 579 41E).

COndition No. 18 states:-

"That screen boundary walls 2 metres high with brick capping are to be provided in the following locations: a (i) along the side boundaries of sites nos. 41, 21, 29 to the rear of the proposed houses (ii) along the rear site boundaries of houses nos. 29 and 28".

The applicant indicated the position of these screen walls on drawing no. 579/41 C lodged on 29th January, 1992. These walls will be 2 metres in height with a dashed external finish on the public side. It is proposed to use a concrete capping on the wall.

Condition No. 20 states:-

"That the following Development Plan requirements are to be adhered to in this development:-

- (i) all gardens to be a minimum of 10.7 metres in length, as measured from main external wall;
- (ii) that all driveways be a minimum of 7.5 metres long;
- (iii) that a 2.3 metre distance be maintained between flank walls of pairs of semi-detached houses and between site 1 and houses on site 2/3.
- (iv) that a 2 metre distance be maintained between the flank walls of house nos. 21 and 29 and the side site boundaries.

COMHAIRLE CHONTAE ATHA CLIATH

Record of Executive Business and Manager's Orders

SOUTH COUNTY

41 houses and relocation of entrance at Springvale, Edmondstown Road, Ballinteer for Dunboden Estates Ltd.

The agent for the applicant stats that a 2 metre distance is to be maintained between the flank walls of houses nos. 21 and 29 and their respective site boundaries. It is stated that drawing no. 579 41C has been amended to show the precise house and site dimensions.

or owq. w . 579 Lie that I note that the driveways of some of the houses appear to be approximately 7 metres in length and not the required 7.5 metres (I specifically refer to houses nos. 1 and 22-30 inclusive).

The rear gardens of a couple of the houses appear to be very marginally less than the require 10.7 metres length when scaled off the drawing (nos. 18-20 and 41). This is considered acceptable.

I note that permission was granted for revised house types on sites nos. 2-21 under Reg. Ref. 92A/1008. The approved houses on these sites under Reg. Ref. 92A/1008 had gardens which were less than 10.7 metres long. A condition of that permission stated that no extensions may be constructed to these dwellings without a prior grant of planning permission.

The drawings submitted show the provision of a 2.3 metre distance being maintained between the flank wall of houses.

Condition No. 29 stated:-

"FInished floor levels of houses nos. 30-41 to be submitted and agreed with the Planning Authority, in writing, prior to the commencement of development. Proposed finished floor levels should ensure that overlooking of any proposed development on the adjoining site is minimised. The applicant is to submit details showing compliance with this condition to the Planning Authority, for its written agreement, prior to the commencement of development".

Drawing no. 579/41 E shows the proposed finished floor levels of houses nos. 30-41 as requested.

The submissions made to comply with condition nos. 11, 18 and 29 are acceptable.

The submission lodged in relation to condition no. 20 is acceptable subject to the following:-

1. Houses nos. I and are to have driveways which are 7.5 metres (minimum) in length and gardens which are 10.7 metres (minimum) as measured from the main external wall of the house.

NOTE: The applicant is to note that complying with (1) above may require a slight reduction in the size of the proposed houses on these sites and that this is acceptable to the Planning Authority.

COMHAIRLE CHONTAE ATHA CLIATH

Record of Executive Business and Manager's Orders

SOUTH COUNTY

41 houses and relocation of entrance at Springvale, Edmondstown Road, Ballinteer for Dunboden Estates Ltd.

The applicant should be advised accordingly.

The applicants attention should be drawn to the fact that compliance submissions are still outstanding with regard to conditions nos. 15, 16(b), 23, 24, 25, 26, 27, and 28 of Decision Order P/4861/91 dated 17th October, 1991.

(MOS/BB)

Endorsed

for Principal Officer

Order:-

Applicant to be informed as set out in the above report.

Dated:

November, 1992. · // 45

South South Area Manager to whom the appropriate powers have been delegated by Order of the Dublin City and County Manager, dated 25/9/3

COMHAIRLE CHONTAE ATHA CLIATH

DUBLIN COUNTY COUNCIL

Control Department,

Planning Department, Irish Life Centre, Lower Abbey Street,

Dublin 1.

Telephone: 724755 231/234 Extension:

773066 Telephone:

יובדסטטיי.

30th January, 1992

LOCAL GOVERNMENT (PLANNING AND DEVELOPMENT) ACTS, 1963 TO 1982

Springvale, Edmonstown Road, Ballinteer LOCATION:

41 houses & relocation of entrance PROPOSED DEVELOPMENT:

Dunboden Estates Ltd.

APPLICANT:

91A/446

PLANNING REG.REF .:

29th January, 1992

DATE OF RECEIPT OF SUBMISSION:

A Chara,

With reference to above, I acknowledge receipt of application for:

Compliance with Conditions

Mise, le meas

A. Smith

PRINCIPAL OFFICER

84 Lower Dode	der Road.	- *	*	ئىرى ــ مۇسەست	= -		
04 E01101 Doc.			·	·	e et eet ma ⁿ ii – L	·	
Dublin 14				چر .ور	tage stage		-
	3 .		····	•			
			1				
			F	- ·	M.	-7	



Planning Department, Dublin County Council, Irish Life Centre, Lower Abbey Street, Dublin 1 1.4.0 Lorf

GERALD CANTAN

Dip. Arch.

Architects and Building Consultants

84 Lr. Dodder Rd., Dublin 14, Ireland.

÷ .

Tel: 01-901678

2 9. JAN 92

9/1/92

Re: 41 Houses on 5.6 Acre site previously approved development (o.p. ref. 88A-0014 appro ref. 89A-0367 and for relocation of entrance to existing house at SPRINGVALE, EDMONSTOWN ROAD, BALLYBODEN.

Dear Sirs,

With reference to the notification of decsion to grant planning permission for the above development I wish on behalf of my client Dunboden Estates Ltd. to hereby submit four copies of a revised drawing in compliance with the following conditions of that notice:

Condition 11.

It is my clients intention that the development will simply be called Springvale after the original house on the site and that the houses will be number 1-41 as indicated on the enclosed drawing 579/41C.

Condition 18.

Concrete blockwork screen walls 2 metres high above the ground will be constructed as required to screen the boundaries to dwellings 41,21,29 and 28 as indicated on drawing 579/41C. The walls will be constructed on concrete foundations and reinforced with concrete blockwork piers. The walls will be constructed in 215mm solid concrete blockwork. The walls will be stepped with the contours. The walls will be pointed fairface to the garden side and soudded, rendered, floated and dashed externally with sand cement plaster. A precast concrete capping will be fitted to the wall and a plane plaster plinth formed.

Condition 20.

Part 4. 2 metres have been set down between the flank walls of houses 21 and 29 and their boundaries.

Drawing 579/41C has been amended to show the precise house and site dimensions.

VAT No. F16777190

Condition 29.

A survey has been carried out on site to establish the relative levels of the Springvale site and the Rookwood site. The contours of the river valley are constant between both sites. It must be assumed that the differences in levels indicated on drawings submitted with each application must be attributable to the use of different datum levels. I have added an indication of the outline of houses in the approved Rookwood development (from information on the file of planning application 914/0946) and have added information on the assumed level of their house 53 relative to the existing ground levels and information on the planning file. The difference of datum levels taken appears to be in the order of 2 metres.

We trust that the information provided on the enclosed drawing is satisfactory.

Yours faithfully

Gerald Cantan

724755 (ext. 262/264)

IMPORTANT: Turn overleaf for further information

PLANNING DEPARTMENT, BLOCK 2, IRISH LIFE CENTRE, LR. ABBEY STREET, DUBLIN 1.

Notification of Decision to Grant Permission/Approved

Local Government (Planning and Development) Acts, 1963-1983

Auveen Byrne & Assocs.,	Decision OrdeP / 4861 / 91 - 17.10.1991 Number and Date
70	Number and Date
Lioscarran House,	Register_Reference No.
32, Dale Rd., Kilmacud, Stillorgan, Co. Dublin.	
JZ, Date Rus, Ramandar,	Planning Control No
Stillorgan, Co. Dublin.	Application Received on
Applicant	Larena y magamamangana, e mana anana bibang saginta e y olo ini i i i i i i i i i i i i i i i i i
the County Health District of Dublin, did by Order dated as a	
revised development of 41 houses on 5.6 developments (O:P. Ref. No. 88A-9014; aprelocation of entrance to existing house	on adjoining site at Springvale,
SUBJECT TO THE FOLLOWING CONDITIONS	. ·
	PERSONAL FOR CONTINUES
CONDITIONS	REASONS FOR CONDITIONS
. The development to be carried out its entirety in accordance with the plarticulars and specifications lodged he application, as amended by Addition information received on 8th August, 19 the site layout is to be in accordance with drawing no. 41A dated 27th June, 1991), save as may be required by the other conditions attached hereto.	ans, development shall be in accordance with the permission and that effective control be maintained.
. That before development commences, pproval under the Building Bye-Laws betained, and all conditions of that pproval be observed in the development	1878-1964.
That each proposed house be used as ingle dwelling unit.	a 3. To prevent unauthorised development.
(Continued)	
en de la composition de la composition La composition de la	্তি প্ৰতিষ্ঠা কৰে। মুক্তি প্ৰতিষ্ঠান্ত্ৰ বিহ
garan kan di kanan di kanan kan kanan kan di kanan di ka Kanan di kanan di ka Kanan di kanan di ka	
the state of the s	and the same of th
	We will be the second of the s
Signed on behalf of the Dublin County Council	
en e	For Principal Officer
and the second of the second o	17.10.1991
	 A. A. M. Marchaelle, and the control of the control o

- 4. That a financial contribution in the sum of £33,600 be paid by the proposer to the Dublin County Council towards the cost of provision of public services in the area of the proposed development and which facilitate this development; this contribution to be paid before the commencement of development on the site.
- 5. That no development under any permission granted pursuant to this decision be commenced until security for the provision and satisfactory completion of services, including maintenance, until taken in charge by the Local Authority for Roads, Open Spaces, Car parks, Sewers, Watermains and Drains, has been given by:-
- Watermains and Drains, has been given by:a. Lodgement with the Council of an
 approved Insurance Company Bond in the
 sum of £50,000 which shall be renewed
 by the developer from time to time as
 required during the course of the
 development and kept in force by him
 until such time as the Roads, Open
 Spaces, Car Parks, Sewers, Watermains
 and Drains are taken in charge by the
 Council.
- OR.....
 b. Lodgement with the Council of a Cash Sum of £35,000 to be applied by the Council at its absolute discretion if such services are not duly provided to its satisfaction on the provision and completion of such services to standard specification.
 OR.....
- c. Lodgement with the Planning Authority of a letter of guarantee issued by any body approved by the Planning Authority for the purpose in respect of the proposed development in accordance with the guarantee scheme agreed with the Planning Authority and such lodgement in any case has been acknowledged in writing by the Council.

- 4. The provision of such services in the area by the Council will facilitate the proposed development. It is considered reasonable that the developer should contribute towards the cost of providing the services.
- 5. To ensure that a ready sanction may be available to the Council to induce the provision of services and prevent disamenity in the development.

NOTE: (Continued)

If there is no appeal to An Bord Pleanala against this decision PERMISSION/APPROVAL will be granted by the Council as soon as may be after the expiration of the period for the taking of such appeal. If every appeal made in accordance with the Acts has been withdrawn, the Council will grant the PERMISSION/APPROVAL after the withdrawal.

An appeal against the decision may be made to An Bord Pleanala. The applicant may appeal within one month from the date of receipt by him of this notification. ANY OTHER PERSON may appeal within twenty-one days beginning on the date of the decision.

An appeal shall be in writing and shall state the subject matter and grounds of the appeal. It should be addressed to:

An Bord Pleanala, Blocks 6 and 7, Irish Life Centre, Lower Abbey Street, Dublin 1.

(1) An appeal lodged by an applicant or his agent with An Bord Pleanala will be invalid unless accompanied by a fee of £36 (Thirty-six Pounds). (2) A party to an appeal making a request to An Bord Pleanala for an Oral Hearing of an appeal must, in addition to (1) above, pay to An Bord Pleanala a fee of £36 (Thirty-six Pounds). (3) A person who is not a party to an appeal must pay a fee of £10 (Ten Pounds) to An Bord Pleanala when making submissions or observations to An Bord Pleanala in relation to an appeal.

Approval of the Council under Building Bye-Laws must be obtained and the terms of the approval must be complied with in the carrying out of the work before any development which may be permitted is commenced.

FUTURE PRINT LTD.

el. 724755 (ext. 262/264)

PLANNING DEPARTMENT, BLOCK 2, IRISH LIFE CENTRE, LR. ABBEY STREET, DUBLIN 1.

Notification of Decision to Grant Permission/Approxim

Local Government (Planning and Development) Acts, 1963-1983

Auveen Byrne & Assocs.,	Decision Ordep/4861/91 - 17.10.1991
Lioscarran House,	
32, Dale Rd., Kilmacud, Stillorgan, Co. Dublin.	Planning Control No.
Applicant Dunboden Estates Ltd.	
In pursuance of its functions under the above-mentioned Acts the County Health District of Dublin, did by Order dated as above	ve make a decision to grant Permission/
revised development of 41 houses on 5.6 according to the contract of the relocation of entrance to existing house of the relocation of entrance to existing house of the relocation of entrance to exist a relocat	O. Ref. No. 89A-U30/) - and TOI
SUBJECT TO THE FOLLOWING CONDITIONS	
CONDITIONS	REASONS FOR CONDITIONS
(Continued)	
5. That all necessary measures be taken the contractor to prevent the spillage of deposit of clay, rubble or other debris adjoining roads during the course of the works.	or of the area.
7. That all public services to the proposed development, including electrical, telephone cables and equipment to the located underground throughout the entire site.	7. In the interest of amenity.
8. That public lighting be provided as each street is occupied in accordance was a scheme to be approved by the County Council so as to provide street lighting to the standard required by the County Council.	ith amenity and public safety.
9. That no dwellinghouse be occupied un all the services have been connected thereto and are operational.	til 9. In the interest of the
(Continued)	
Signed on behalf of the Dublin County Council	For frincipal Officer 17.10.1991 Date

- 10. That all watermain tappings, branch connections, swabbing and chlorination be carried out by the County Council, Sanitary Services Department and that the cost thereof be paid to the County Council before any development commences.
- 11. That an acceptable street naming and house numbering scheme be submitted to and approved by the County Council before any constructional work takes place on the proposed houses.
- 12. That the developer shall construct and maintain to the Council's standard for taking in charge all the roads, including footpaths, verges, public lighting, open space, sewers, watermains or drains, forming part of the development, until taken in charge by the Council.
- 13. That a financial contribution in the sum of £800 per house be paid by the proposer to the Dublin County Council towards improvements to the distributor road network in the area of the proposed development which will facilitate this development; this contribution to be paid before the commencement of development on the site.

(Continued)

- 10. To comply with public health requirements and to ensure adequate standards of workmanship. As the provision of these services by the County Council will facilitate the proposed development it is considered reasonable that the Council should recoup the cost.
- 11. In the interest of the proper planning and development of the area.
- 12. In the interest of the proper planning and development of the area.
- 13. The provision of such services in the area by the Council will facilitate the proposed development. It is considered reasonable that the developer should contribute towards the cost of providing the services.

NOTE:

If there is no appeal to An Bord Pleanala against this decision PERMISSION/APPROVAL will be granted by the Council as soon as may be after the expiration of the period for the taking of such appeal. If every appeal made in accordance with the Acts has been withdrawn, the Council will grant the PERMISSION/APPROVAL after the withdrawal.

An appeal against the decision may be made to An Bord Pleanala. The applicant may appeal within one month from the date of receipt by him of this notification. ANY OTHER PERSON may appeal within twenty-one days beginning on the date of the decision.

An appeal shall be in writing and shall state the subject matter and grounds of the appeal. It should be addressed to:

An Bord Pleanala, Blocks 6 and 7, Irish Life Centre, Lower Abbey Street, Dublin 1.

(1) An appeal lodged by an applicant or his agent with An Bord Pleanala will be invalid unless accompanied by a fee of £36 (Thirty-six Pounds). (2) A party to an appeal making a request to An Bord Pleanala for an Oral Hearing of an appeal must, in addition to (1) above, pay to An Bord Pleanala a fee of £36 (Thirty-six Pounds). (3) A person who is not a party to an appeal must pay a fee of £10 (Ten Pounds) to An Bord Pleanala when making submissions or observations to An Bord Pleanala in relation to an appeal.

Approval of the Council under Building Bye-Laws must be obtained and the terms of the approval must be complied with in the carrying out of the work before any development which may be permitted is commenced.

FUTURE PRINT LTD.

si. 724755 (ext. 262/264)

IMPORTANT: Turn overleaf for further information

PLANNING DEPARTMENT, BLOCK 2, IRISH LIFE CENTRE, LR. ABBEY STREET, DUBLIN 1.

Notification of Decision to Grant Permission/

Local Government (Planning and Development) Acts, 1963-1983

Auveen Byrne & Assocs.,	Decision OrdeP/4861/91 - 17.10.1991 Number and Date
Lioscarran House,	Decision OrdeP/4861/91 - 17.10.1991 Number and Date 91A-0446 Register Reference No.
32, Dale Rd., Kilmacud,	Planning Control No.
Stillorgan, Co. Dublin.	26.03.1991 Application Received on
Applicant Dunboden Estates Ltd.	
In pursuance of its functions under the above-mentioned the County Health District of Dublin, did by Order dated as	Acts, the Dublin County Council, being the Planning Authority for above make a decision to grant Permission
revised development of 41 houses on 5.6 developments (0.P: Ref. No. 88A-0014, a relocation of entrance to existing house to exist the second stown Road	ppro. Ref. No. 89A-0367) and fore on adjoining site at Springvale,
SUBJECT TO THE FOLLOWING CONDITIONS	
CONDITIONS	REASONS FOR CONDITIONS
(Continued)	
cost to be paid on a phased basis as agreed with the Planning Authority.	amenities of the area. t of pace ts on pen age he open ts a use o This
15. Additional tree planting using A and Oak shall be carried out alongsid river bank. Details to be submitted the Planning Authority for written agreement prior to development commen (Continued)	sh e the proper planning and development of the area.
Signed on behalf of the Dublin County Council	For Principal Officer 17.10.1991

development of the area.

- 16. In the interest of the proper planning and
- 16. (A) Prior to the commencement of development trees scheduled for retention shall be protected by means of stout timber fence 1.5 m. high (as indicated on Drawing No. E104/205). This fence shall enclose the area covered by the branch spread of trees and shall be maintained in good condition throughout the period of development. The areas so fenced off shall not be used for storage, dumping or for any purpose which would jeopardise the health of the trees.
- No underground services, roadways, pathways or carparking areas shall be provided beneath the row of Scots Pine. scheduled for retention located to the east of house nos. 22-29. This may require the relocation of the proposed surface water sewer and manholes and S13 and S7. This matter to be subject of prior discussion and written agreement of the Planning Authority.
- 17. That access details (including carriageway width on bridge and alignment at proposed junction) are to be agreed with the Roads Department prior to the commencement of development.
- 18. That screen boundary walls 2 metres high with brick capping are to be provided in the following locations: - (i) along the side boundaries of sites nos. 41, 21 29, to the rear of the proposed houses (ii) along the rear site boundaries of houses nos. 29 and 28.
- 19. That front boundary walls are to be provided. These walls are not to exceed 1.2 metres in height, and are to have a brick finish and be properly capped.

(Continued)

17. In the interest of the proper planning and

development of the area.

- 18. In the interest of the proper planning and development of the area.
- 19. In the interest of the proper planning and development of the area.

NOTE:

If there is no appeal to An Bord Pleanala against this decision PERMISSION/APPROVAL will be granted by the Council as soon as may be after the expiration of the period for the taking of such appeal. If every appeal made in accordance with the Acts has been withdrawn, the Council will grant the PERMISSION/APPROVAL after the withdrawal.

An appeal against the decision may be made to An Bord Pleanala. The applicant may appeal within one month from the date of receipt by him of this notification. ANY OTHER PERSON may appeal within twenty-one days beginning on the date of the decision.

An appeal shall be in writing and shall state the subject matter and grounds of the appeal. It should be addressed to:-An Bord Pleanala, Blocks 6 and 7, Irish Life Centre, Lower Abbey Street, Dublin 1.

(1) An appeal lodged by an applicant or his agent with An Bord Pleanala will be invalid unless accompanied by a fee of £36 (Thirty-six Pounds). (2) A party to an appeal making a request to An Bord Pleanala for an Oral Hearing of an appeal must, in addition to (1) above, pay to An Bord Pleanala a fee of £36 (Thirty-six Pounds). (3) A person who is not a party to an appeal must pay a fee of £10 (Ten Pounds) to An Bord Pleanala when making submissions or observations to An Bord Pleanala in relation to an appeal.

Approval of the Council under Building Bye-Laws must be obtained and the terms of the approval must be complied with in the carrying out of the work before any development which may be permitted is commenced.

FUTURE PRINT LTD


rel. 724755 (ext. 262/264)

IMPORTANT: Turn overleaf for further information

PLANNING DEPARTMENT, BLOCK 2, IRISH LIFE CENTRE, LR, ABBEY STREET, DUBLIN 1.

Notification of Decision to Grant Permission Apparation Local Government (Planning and Development) Acts, 1963-1983

Auveen Byrne & Assocs.,	Decision OrdeP/4861/91 - 17.10.1991
Lioscarran House,	91A-0446 Register Reference No.
32, Dale Rd., Kilmacud,	— Planning Control No
Stillorgan, Co. Dublin.	— Planning Control No
Applicant Dunboden Estates Ltd.	The same of the sa
	ned Acts, the Dublin County Council, being the Planning Authority fo as above make a decision to grant Permission/department for:-
developments (O.P. Ref. No. 88A-8014 relocation of entrance to existing h	5.6 acre site of previously approved , appro. Ref. No. 89A-0367; and for ouse on adjoining site at Springvale, oad, Ballyboden.
SUBJECT TO THE FOLLOWING CONDITIONS	
CONDITIONS	REASONS FOR CONDITIONS
Continued)	
20. That the following Development requirements are to be adhered to indevelopment: i) all gardens to be a minimum of metres in length, as measured from external wall; ii) that all driveways be a minimum of metres long; iii) that a 2.3 metre distance be maintained between flank walls of processing processing the process of the semi-detached houses and between simple and houses on site 2/3. (iv) that a 2 metre distance be maintained between the flank walls mouse nos. 21 and 29 and the side secondaries.	proper planning and development of the area. 10.7 main m of
(Continued)	in the second se
and the second of the second o	Control of the Contro
Commence of the second of the	and the second
Signed on behalf of the Dublin County Council	For Pincipal Officer

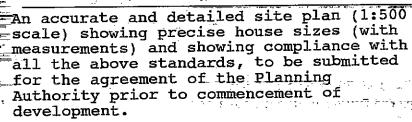

The applicant should note that complying with the above Development Plan Standards may require a reduction in the size of some of the houses.

- 21. That the front boundary wall of the site along Edmondstown Road is to be repaired in stone to match the existing wall. In this regard existing blockwork is to be removed and gaps filled in. The proposed new front boundary wall is to be constructed of stone to match the existing wall. The existing stone wall is to be extended across the existing entrance to the site.
- 22. (a) That the water supply and drainage arrangements, including the disposal of surface water, be in accordance with the requirements of the County Council.

The applicant should note that these arrangements must cater for the proposed Dublin corporation watermain and scour pipe.

(Continued)

21. In the interest of the proper planning and development of the area.

22. In order to comply with the Sanitary Services Acts 1878-1964.

NOTE:

If there is no appeal to An Bord Pleanala against this decision PERMISSION/APPROVAL will be granted by the Council as soon as may be after the expiration of the period for the taking of such appeal. If every appeal made in accordance with the Acts has been withdrawn, the Council will grant the PERMISSION/APPROVAL after the withdrawal.

An appeal against the decision may be made to An Bord Pleanala. The applicant may appeal within one month from the date of receipt by him of this notification. ANY OTHER PERSON may appeal within twenty-one days beginning on the date of the decision.

An appeal shall be in writing and shall state the subject matter and grounds of the appeal. It should be addressed to:

An Bord Pleanala, Blocks 6 and 7, Irish Life Centre, Lower Abbey Street, Dublin 1.

(1) An appeal lodged by an applicant or his agent with An Bord Pleanala will be invalid unless accompanied by a fee of £36 (Thirty-six Pounds). (2) A party to an appeal making a request to An Bord Pleanala for an Oral Hearing of an appeal must, in addition to (1) above, pay to An Bord Pleanala a fee of £36 (Thirty-six Pounds). (3) A person who is not a party to an appeal must pay a fee of £10 (Ten Pounds) to An Bord Pleanala when making submissions or observations to An Bord Pleanala in relation to an appeal.

Approval of the Council under Building Bye-Laws must be obtained and the terms of the approval must be complied with in the carrying out of the work before any development which may be permitted is commenced.

FUTURE PRINT LTD.

el. 724755 (ext. 262/264)

IMPORTANT: Turn overleaf for further information

PLANNING DEPARTMENT,
-BLOCK 2,
IRISH LIFE CENTRE,
LR. ABBEY STREET,
DUBLIN 1.

Notification of Decision to Grant Permission

Local Government (Planning and Development) Acts, 1963-1983

	÷	1.		* :
Auveen Byrne & Assocs.,	Decision C	OrdeP/4861/91	- 17.10.	1991
Lioscarran House,			91A-	0446
	Register R	leference No	e e egrepe e egrepe e e	erra gazaza
32, Dale Rd., Kilmacud, Stillorgan, Co. Dublin.	Planning (Control No		
Stillorgan, Co. Dublin.	Application	n Received on	26.03.	1991
Applicant Dunboden Estates Ltd.	enterde actación menamentamente réceira de la composición del composición de la comp		A throte described their a vector is managed.	
In pursuance of its functions under the above-mentione the County Health District of Dublin, did by Order dated a revised development of 41 houses on 5 developments (0:P: Ref: No: 88A-0014; relocation of entrance to existing house	s above make a .6 acre site ·appro. Ref. use on adjoi	decision to grant F of previously No. 89A-0367 ning site at 8	Permission/	••••••••••••••••••••••••••••••••••••••
Edmondstown Ro	ad, Ballybod	len	a da a rana membera s	
SUBJECT TO THE FOLLOWING CONDITIONS			4599	
CONDITIONS		REASONS	FOR CONDITI	ONS
(Continued)				
the bank to the rear of houses nos21. A retaining wall may require constructed. Prior to the commencemberelopment, the applicant is to substailed proposals designed to ensurate the sections across the site in the vicion of dwelling nos. 1-21 for the written agreement of the Planning Authority. Proposals to be certified by a chartestructural engineer.	ent of bmit c the cross nity The	proper pla developmen	t of the	area.
(Continued)				
Angle Angl	to anyther the second	1		
អ្នកស្រុកស្រុកសម្ព័ក្ស (ស្គ្រាស់ក្រោយ) នៅ នៅក្រុម ប្រុស្ធាន (ស្គ្រាស់ក្រោយ) នៅ នៅ ប្រុស្ធាន (ស្គ្រាស់ក្រុម (ស ស្គ្រាស់ក្រុម (ស. 1985) ស្គ្រាស់ក្រុម (ស. 1985) ស្គ្រាស់ក្រុម (ស. 1985) ស្គ្រាស់ក្រុម (ស. 1985) ស្គ្រាស់ក្រុម	SE STATE OF THE			
And the state of t	- 19.5		''	
Signed on behalf of the Dublin County Council		Love	For Principal O	fficer

24. The proposed diversion of the culverted stream adjacent to house no. 1 indicated on drawing no. 101 submitted as Additional Information on 8th August, 1991, shall be carried out prior to the commencement of development on the site. Details of the proposed treatment of the outfall of the diverted stream as well as pipe size, and the exit and entry of this pipeline are to be submitted to the Planning Authority for its written agreement prior to the commencement of development on the site.

25. Prior to the commencement of development on the site the applicant is to determine from Dublin Corporation the location of the proposed 600 mm. scour pipe. The applicant is to combine the internal surface water system into a single outfall incorporating the Dublin Corporation scour pipe to discharge to the adjoining river. The outfall to be located at the wing walls associated with The wing walls are to have a the bridge. stone facing to match the bridge. applicant to submit details showing compliance with this condition to the Planning Authority for written agreement prior the commencement of development on the site.

26. Prior to commencement of development on the site the applicant is to submit structural details of the proposed bridge and river traning walls, certified by a chartered structural engineer to the Planning Authority for its written agreement.

(Continued)

24. In the interest of proper planning and development of the area.

25. In the interest of the proper planning and development of the area.

26. In the interest of the proper planning and development of the area.

NOTE:

If there is no appeal to An Bord Pleanala against this decision PERMISSION/APPROVAL will be granted by the Council as soon as may be after the expiration of the period for the taking of such appeal. If every appeal made in accordance with the Acts has been withdrawn, the Council will grant the PERMISSION/APPROVAL after the withdrawal.

An appeal against the decision may be made to An Bord Pleanala. The applicant may appeal within one month from the date of receipt by him of this notification. ANY OTHER PERSON may appeal within twenty-one days beginning on the date of the decision.

An appeal shall be in writing and shall state the subject matter and grounds of the appeal. It should be addressed to:-An Bord Pleanala, Blocks 6 and 7, Irish Life Centre, Lower Abbey Street, Dublin 1.

(1) An appeal lodged by an applicant or his agent with An Bord Pleanala will be invalid unless accompanied by a fee of £36 (Thirty-six Pounds), (2) A party to an appeal making a request to An Bord Pleanala for an Oral Hearing of an appeal must, in addition to (1) above, pay to An Bord Pleanala a fee of £36 (Thirty-six Pounds). (3) A person who is not a party to an appeal must pay a fee of £10 (Ten Pounds) to An Bord Pleanala when making submissions or observations to An Bord Pleanala in relation to an appeal.

Approval of the Council under Building Bye-Laws must be obtained and the terms of the approval must be complied with in the carrying out of the work before any development which may be permitted is commenced.

FUTURE PRINT LTD.

724755 (ext. 262/264)

PLANNING DEPARTMENT, BLOCK 2, IRISH LIFE CENTRE, LR. ABBEY STREET, DUBLIN 1.

Notification of Decision to Grant Permission

Local Government (Planning and Development) Acts, 1963-1983

Auveen Byrne & Assocs.,	Decision O	OrdeP/4861/91 - 17.10.199	1
Lioscarran House,	Donister De	91A-044	6
	register ne	ererence No	erwije en en e e e Vij
32, Dale Rd., Kilmacud, Stillorgan, Co. Dublin.	ം _{ത്യ} Planning C	Control No.	
Stillorgan, Co. Dublin.	Application	Received on	ا بيلي.
Applicant Dunboden Estates Ltd.			<i>.</i>
Applicant	en erzerze, aplenie bei erzentungze ze ze	Court along the state and a manager of the state of the s	i a manistra de la casa de la cas La casa de la casa de
In pursuance of its functions under the above-mentioned of the County Health District of Dublin, did by Order dated as	above maké a (decision to grant Permission	thority for
revised development of 41 houses on 5.6 developments (0.P. Ref. No. 88A-0014; a relocation of entrance to existing hous	ppro Rei. e on adjoir	ning site at Springvale,	
	· • · · · · · · · · · · · · · · · · · ·		
SUBJECT TO THE FOLLOWING CONDITIONS			
CONDITIONS	· · · · · · · · · · · · · · · · · · ·	REASONS FOR CONDITIONS	
(Continued)			
applicant is to submit details showing compliance with this condition to the clanning Authority for its written agreement prior to the commencement development on the site. 28. That the foundations of the abutm	level to he g of	27. In the interest of proper planning and development of the are	ea
to the bridge are to be extended to mender the RIver bed. The applicant is submit details showing compliance with this condition to the Planning AUthor for its written agreement prior to commencement of development.	s to h ity	development of the are	∃a. ,
(Continued)			
The second of th	e energy of part		
Signed on behalf of the Dublin County Council	The second secon	ya Paterini in	
IMPORTANT: Turn overleaf for further information			

- 29. Finished floor levels of houses nos. 30-41 to be submitted and agreed with the Planning Authority, in writing, prior to the commencement of development. Proposed finished floor levels should ensure that overlooking of any proposed development on the adjoining site is minimised. The applicant is to submit details showing compliance with this condition to the Planning Authority, for its written agreement, prior to the commencement of development.
- 30. That the proposed bridge and wing walls to the bridge as well as any proposed retaining wall are to have a stone facing.
- 31. The applicant to pay a special contribution of £2000/acre in respect of connection to the Rockbrook Sewer on Edmondstown Road.
- 32. That development of house nos. 28-41 and the access road serving these houses shall not proceed until the sections of the proposed Dublin Corporation 1000 mm. watermain and 600 mm. scour pipe are constructed by Dublin Corporation, unless otherwise agreed in writing with the Planning Authority.
- 33. That the hammerheads at the end of roads 'A' and 'C' measure 12 x 9 metres.

(Continued)

- 29. To minimise any overlooking. A discrepancy of 1-2 metres is noted in the contours shown for this site vis a vis the contours shown for the adjoining "Rookwood" site under Reg. Ref. 91A/0946.
- 30. In the interest of visual amenity.
- 31. It is considered reasonable that the applicant should bear some of the cost of the construction of this sewer which facilitates the proposed development.
- 32. In the interest of the proper planning and development of the area.
- 33. In the interest of the proper planning and development of the area.

NOTE:

If there is no appeal to An Bord Pleanala against this decision PERMISSION/APPROVAL will be granted by the Council as soon as may be after the expiration of the period for the taking of such appeal. If every appeal made in accordance with the Acts has been withdrawn, the Council will grant the PERMISSION/APPROVAL after the withdrawal.

An appeal against the decision may be made to An Bord Pleanala. The applicant may appeal within one month from the date of receipt by him of this notification. ANY OTHER PERSON may appeal within twenty-one days beginning on the date of the decision.

An appeal shall be in writing and shall state the subject matter and grounds of the appeal. It should be addressed to:—An Bord Pleanala, Blocks 6 and 7, Irish Life Centre, Lower Abbey Street, Dublin 1.

(1) An appeal lodged by an applicant or his agent with An Bord Pleanala will be invalid unless accompanied by a fee of £36 (Thirty-six Pounds). (2) A party to an appeal making a request to An Bord Pleanala for an Oral Hearing of an appeal must, in addition to (1) above, pay to An Bord Pleanala a fee of £36 (Thirty-six Pounds). (3) A person who is not a party to an appeal must pay a fee of £10 (Ten Pounds) to An Bord Pleanala when making submissions or observations to An Bord Pleanala in relation to an appeal.

Approval of the Council under Building Bye-Laws must be obtained and the terms of the approval must be complied with in the carrying out of the work before any development which may be permitted is commenced.

FUTURE PRINT LTD.

rei. 724755 (ext. 262/264)

IMPORTANT: Turn overleaf for further information

PLANNING DEPARTMENT, BLOCK 2, IRISH LIFE CENTRE, LR. ABBEY STREET, DUBLIN 1.

Notification of Decision to Grant Permission/Approval

Local Government (Planning and Development) Acts. 1963-1983

:	Desiries Ond \$ /4961/01 - 17 10 1991
Auveen Byrne & Assocs.,	Decision Ordæ/4861/91 - 17.10.1991 —Number and Date
	Register Reference No
32, Dale Rd., Kilmacud, Stillorgan, Co. Dublin.	Planning Control No. 26.03.1991
Applicant Dunboden Estates Ltd.	Application Received on
In pursuance of its functions under the above-mentioned At the County Health District of Dublin, did by Order dated as all revised development of 41 houses on 5.6 developments (O.P. Ref. No. 88x-8014, apprelocation of entrance to existing house Edmondstown Road,	acre site of previously approved pro. Ref. No. 89A-0367, and for
SUBJECT TO THE FOLLOWING CONDITIONS	
CONDITIONS .	REASONS FOR CONDITIONS
mokeless fuels in lifeplaces of ppliances suitable only for burning somokeless fuels. OTE: The applicant is advised to	olid
onsult with the Sanitary Services epartment prior to lodging compliance ubmissions as required by conditions 3-29 inclusive of this decision. 5. No development to commence on site ntil a contribution of £125,000 has be odged with the Planning Authority tow he cost of upgrading the foul sewer a callyboden Road.	35. The upgrading of the foul sewer on Ballyboden Road is required to cater for development in the area
	4.34
and the second of the second o	
en e	7 ta 11.10
Signed on behalf of the Dublin County Council	`
en de la composition de la composition La composition de la	Date 17/00/9/

REASONS FOR CONDITIONS

NOTE:

If there is no appeal to An Bord Pleanala against this decision PERMISSION/APPROVAL will be granted by the Council as soon as may be after the expiration of the period for the taking of such appeal. If every appeal made in accordance with the Acts has been withdrawn, the Council will grant the PERMISSION/APPROVAL after the withdrawal.

CONDITIONS

An appeal against the decision may be made to An Bord Pleanala. The applicant may appeal within one month from the date of receipt by him of this notification. ANY OTHER PERSON may appeal within twenty-one days beginning on the date of the decision.

An appeal shall be in writing and shall state the subject matter and grounds of the appeal. It should be addressed to:

An Bord Pleanala, Blocks 6 and 7, Irish Life Centre, Lower Abbey Street, Dublin 1.

(1) An appeal lodged by an applicant or his agent with An Bord Pleanala will be invalid unless accompanied by a fee of £36 (Thirty-six Pounds). (2) A party to an appeal making a request to An Bord Pleanala for an Oral Hearing of an appeal must, in addition to (1) above, pay to An Bord Pleanala a fee of £36 (Thirty-six Pounds). (3) A person who is not a party to an appeal must pay a fee of £10 (Ten Pounds) to An Bord Pleanala when making submissions or observations to An Bord Pleanala in relation to an appeal.

Approval of the Council under Building Bye-Laws must be obtained and the terms of the approval must be complied with in the carrying out of the work before any development which may be permitted is commenced.

PUTURÉ PRINT LTD.

Auveen Byrne & Associates, Lioscarran House, 32, Dale Road, Kilmacud, Stillorgan, Co. Dublin. Reg. Ref. 91A-0446

15 October 1991

Re: Proposed revised development of 41 houses on 5.6 acre site of previously approved developments (0.P. Ref. No. 88A-0014, appro. Ref. No. 89A-0367) and for relocation of entrance to existing house on adjoining site at Springvale, Edmondstown Road, Ballyboden for Dunboden Estates Ltd.

Dear Sir/Madam,

With reference to your planning application received here on 26th March, 1991, (letter for extension period received 14th October, 1991), in connection with the above, I wish to inform you that:-

In accordance with Section 26(4A) of the Local Government (Planning and Development) Act, 1963, as amended by Section 39(F) of the Local Government (Planning and Development) Act, 1976, the period for considering this application within the meaning of subsection (4A) of Section 26 has been extended up to and including 18th October, 1991.

Yours faithfully,

for Principal Officer



AUVEEN BYRNE & ASSOCIATES,

Consultant Town Planners,

Lioscarran House, 32 Dale Road, Kilmacud, Stillorgan, Co.Dublin,

> Telephone: (01) 831611, Facsimile: (01) 889747,

Dublin County Council, Block II Irish Life Centre, Lower Abbey Street, Dublin 1.

14th October 1991

RE: Permission for housing development at Springvale for Dunboden Estate Limited.

Reference number 91A/446.

For the attention of Mr Pat Kenny

Dear Sir,

In accordance with the provisions of Section 26. 4(a) of the Local Government (Planning and Development) Act 1963, as modified by the Act of 1976, I am authorised by my clients, Dunboden Estates Limited to request an extension of time for consideration of this application for a limited period of time, i.e. up to and including Friday, 18th October 1991.

Yours sincerely,

P.P. <u>dis</u>Scanton

AUVEEN BYRNE

1 5. OCT 91



AUVEEN BYRNE & ASSOCIATES.

Consultent Town Planners,

Lioscarran House, 32 Dale Road, Klimacud, Stillorgan, Co.Dublin. Telephone: (D1) 831611, Facsimile: (D1) 889747,

Dublin County Council, Block II Irish Life Centre, Lower Abbey Street, Dublin 1.

14th October 1991

RE: Permission for housing development at Springvale for Dunboden Estate Limited. Reference number 91A/446.

For the attention of Mr Pat Kenny

Dear Sir,

In accordance with the provisions of Section 26. 4(a) of the Local Government (Planning and Development) Act 1963, as modified by the Act of 1976, I am authorised by my clients, Dunboden Estates Limited to request an extension of time for consideration of this application for a limited period of time, i.e. up to and including Friday, 18th October 1991.

Yours sincerely,

AUVEEN BYRNE





AUVEEN BYRNE & ASSOCIATES,

Consultant Town Planners,

Liosoarran House, 32 Dale Road, Kilmacud, Stillorgan, Co.Dublin. Telephone: (01) 831611,

Faosimile: (01) 889747.

Dublin County Council, Block II Irish Life Centre, Lower Abbey Street, Dublin 1.

4th October 1991

Permission for housing development at Springvale for RE: Dunboden Estate Limited. Reference number 91A/446.

For the attention of Mr Pat Kenny

Dear Sir,

In accordance with the provisions of Section 26. 4(a) of the Local Government (Planning and Development) Act 1963, as modified by the Act of 1976, I am authorised by my clients, Dunboden Estates Limited to request an extension of time for consideration of this application for one week, i.e. up to and including Monday, 14th October 1991.

Yours sincerely,

AUVEEN BYRNE

DUBLIN COUNTY COUNCIL

Auveen Byrne, B.A., Dip.T.P., M.I.P.I.

V.A.T. No. 3108374 T.

FLANNING DEPT.





Dublin County Council, Block II, Jeish Life Centre, Louer Abbey St, Dublin 1. Auveen Byrne & Assocs., Lioscarran House, 32, Dale Road, Kilmacud, Stillorgan, Co. Dublin. Reg. Ref.: 91A-0446

8 October 1991

Re: Proposed revised development of 41 houses on 5.6 acre site of previously approved development (O.P. Ref. No. 88A-0014, appro. Ref. No. 89A-0367) and for relocation of entrance to existing house on adjoining site at Springvale, Edmondstown Road, Ballyboden for Dunboden Estates Ltd.

Dear Sir,

With reference to your planning application received here on 26th March, 1991, (letter for extension period received 7th October, 1991), in connection with the above, I wish to inform you that:-

In accordance with Section 26(4A) of the Local Government (Planning and Development) Act, 1963, as amended by Section 39(F) of the Local Government (Planning and Development) Act, 1976, the period for considering this application within the meaning of subsection (4A) of Section 26 has been extended up to and including 14th October, 1991.

Yours faithfully,

for Principal Officer

:17



AUVEEN BYRNE & ASSOCIATES.

Consultant Town Planners,

Lioscarran House, 32 Dale Road, Kilmacud, Stillorgen, Co.Dublin, Telephone (01) 531811, Facsimile: (01) 689747.

Dublin County Council, Block II Trish Life Centre, Luwer Abbey Street, Dublin 1.

Ath October 1991

RE: Permission for housing development at Springvale for Dunboden Estate Limited.
Reference number 91A/445.

For the attention of Mr Pat Kenny

Thomas Sign

In accordance with the provisions of Section 26. 4(a) of the Local Government (Flanning and Development) Act 1963, as modified by the Act of 1976, I am authorised by my clients, Dunboden Estates Limited to request an extension of time for consideration of this application for one week, i.e. up to and including Monday, 14th October 1991.

Yours sincerely,

t t the scanto

MITTERN BYRNE

GHayden informed 4.35pm

4



Attn. Mr. A. Doran
Building Control Section,
Dublin County Council

Trish Life Centre,
Lower Abbey Street,
Dublin 1

91A/0446 1.12.0 18.55 01 A.I. for BBL

4/9/91

Re. Proposed housing at Springvale, Ballyboden TIME EXTENSION/ADDITIONAL INFORMATION FOR B.B.L. Reg. Ref. No. 91A/446

Dear Sir,

Referring to your letter of 15/7/91 to Auveen Byrne ans Associates re additional information required on the above project I understand that you have had a meeting with Michael Carew of Carew Associates and that he has submitted further information to you on the above project. There are some items which require further architectural details namely:

- (1) details of the bay windows
- (2) details of the closure of the cavity at the return of the brick facing to the gable walls.

To satisfy your requirements for further information on these details I am submitting the following:

(1) Revised copies of drawings 579/42A and 43A which illustrate the house type to be constructed with further information on the bay windows.

VAT No. F16777190

GERALD CANTAN

Dip. Arch.

Architects and Building Consultants

87 Terenure Road North Dublin 6, Ireland.


Tel: 01-920106 Fax: 01-920107 (2) 2 Copies on construction details numbered 579/44 which illustrate the details of the bay window at roof level, at first floor level, of the reveal of the bay window and of the closure of the cavity at the return of the brickwork to the gable wall.

We have consulted with Carew Associates on these details and they have recommended the use of a 203x203x57 U.C. over the openings to the bay window at both levels. This has been marked on our drawings.

I trust that this supplimentary information is satisfactory.

Yours sincerely

Gerald Cantan

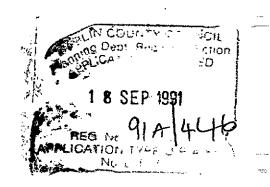

MIRIUDIU DESERDO DIO DE LA SIPIRIO MATERIA D

DETAILS TO BAY WINDO


[]

WS


(

B.COODEUM.

١.

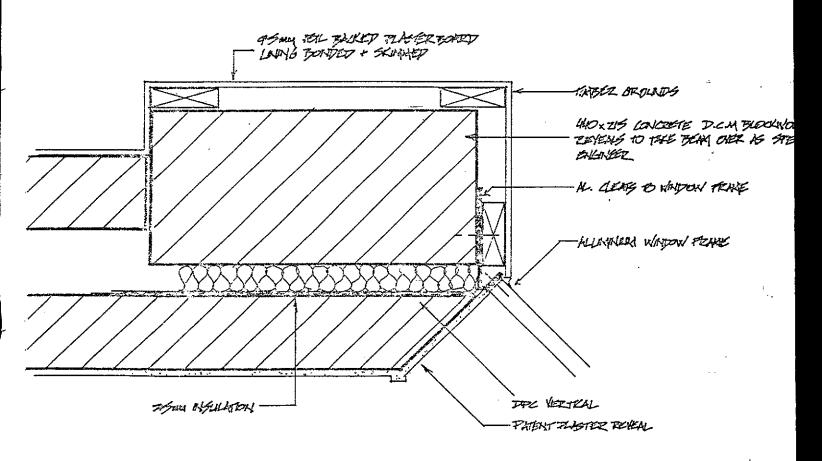

DETAIL OF PIER AT SIDES OF BAY WINDOW

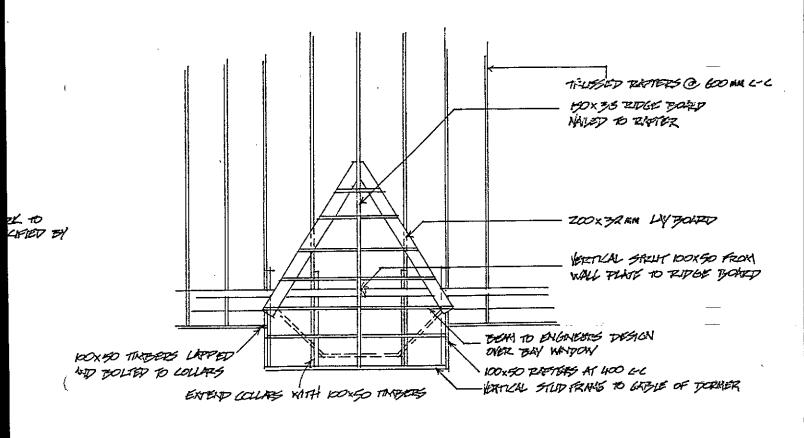



PLAN OF ROOF TIMBERS TO DORMERS

Scale 1:5 Date 3-9-91


HOUSING AT SPRINGVALE BALLYBODEN


DRG. NO. 579/44/1

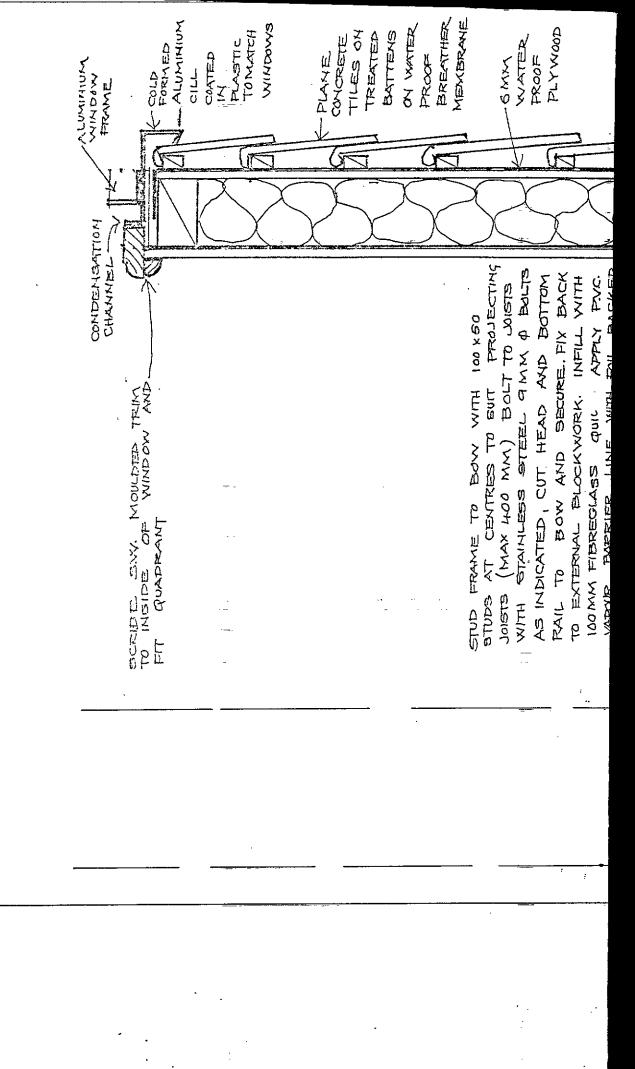

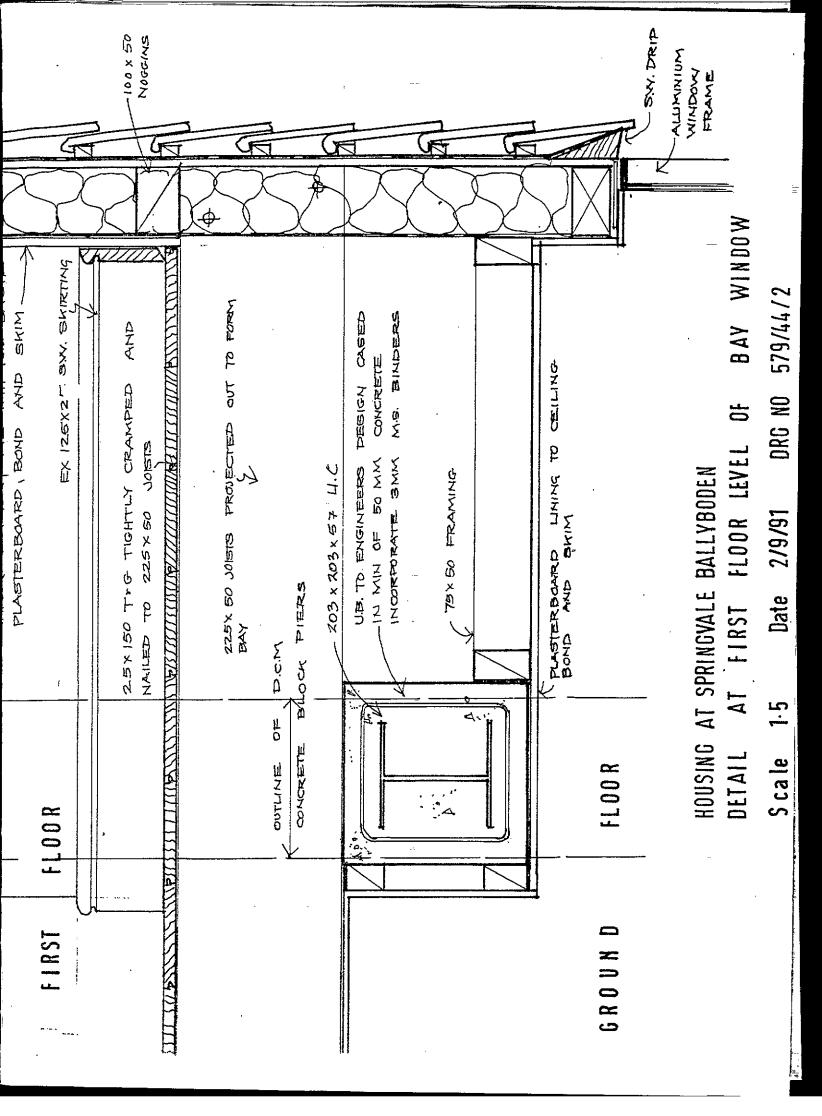

をある数ををある **经过多时间的** -100 X50 GROUND 以 225× OF THE WANTER FRAME TENDER NO FLOAT KILL YOU CINDY 20 KK RESIDEND PAINT. OFF SE NAME PLOST PLYLAD. COLOURED NOTIFIED POINTING ON BLAN BOLT TO HORIZONTAL TIMBERS DORMER WITH 100X 50 STUDS OMERIED OUT FROM CEILING AT 600 MM CENTRES, 100 X 50 SLOPING HEAD AND SOLE BOARD AND BITHER STUD FRAME TO GABLE OR INCHES DOX 50 RAFTERS NAILED CARRIED OUT AS HAR ON. 100 X50 RAFTERS BOLLTED TO MAIN 100X 50~ BOAR D PLATE. IIMBER FROM WALLPLATE TO FUT DOFF ROX C SISION > 1 BOARD RAFTER AND BOARD DOXUM RIDGE TO ARCIE GIRUIS BOAKE TASST. OC XOC Ø ₹ RIDの町 れてたの PROFILED CONCRETE.) j. 2

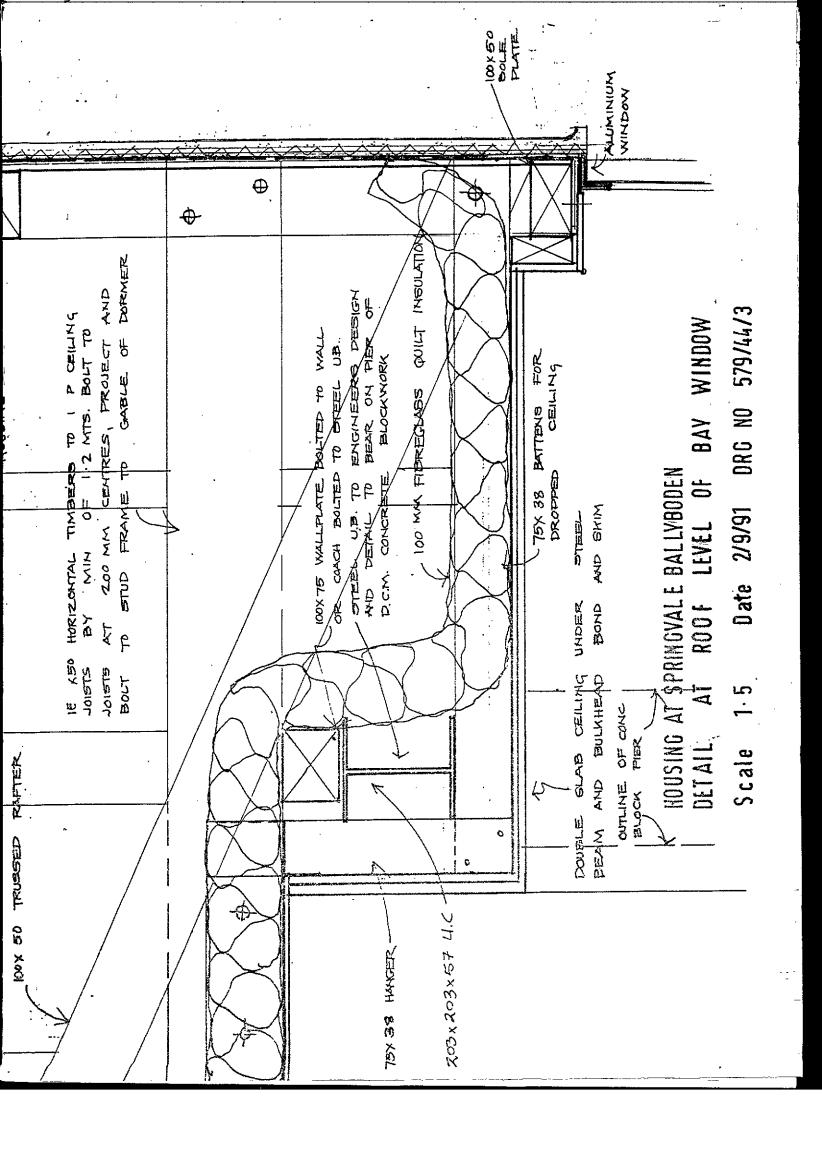

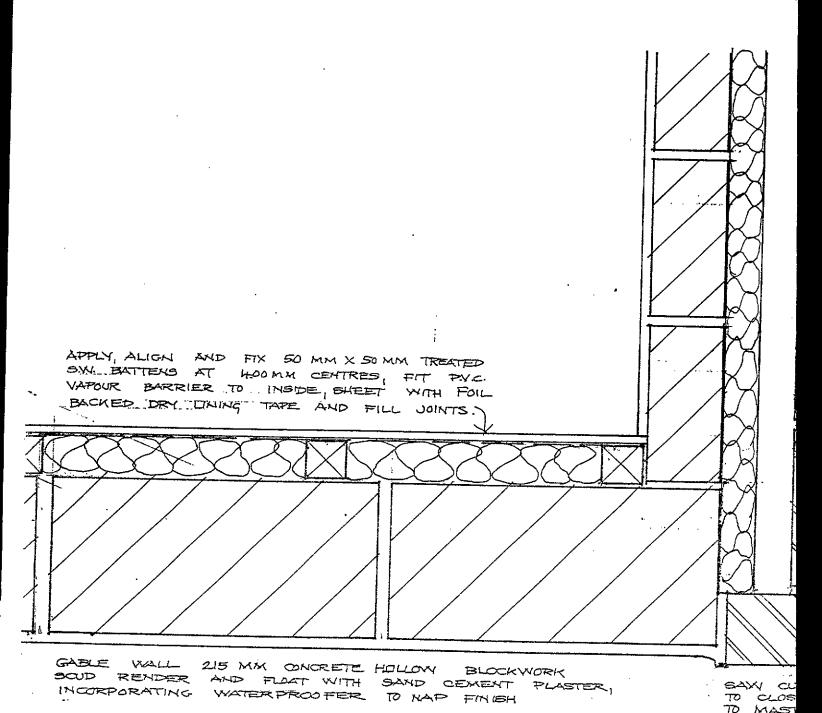

HOUSING AT SPR

DETAIL OF Scale 1.5

FRONT ELEVATION 100 MM CLAY BRICK EXTERNAL
LEAF TO GROUND FLOOR 100 MM CONCRETE BLOCK
LEAF TO FIRST FLOOR.
100 MM CAVITY INCORPORATING 50 MM BOARD
INSULATION TO INSIDE FACE
INTERNAL 100 MM CONC BLOCK INTERNAL LEAF
WHE INTERNALLY WITH FOIL BACKED PLASTERBOARD

T BRICKS AND CONC BLOCKS E OWITY. BUILD OUT BRICKWORK ER PLASTER TO GABLE

INSVALE BALLYBODEN

CLOSURE OF CAVITY AT GABLE Date 2/9/91 DRG NO 579/44/4

CAREW ASSOCIATES

CONSULTING ENGINEERS.

22 CROFTON ROAD, DUN LAOGHAIRE, CO. DUBLIN.

TELEPHONE: (01)2809827, 2844334


MOBILE:

088-557302

FAX:

2809944

Ms Auveen Byrne,
Auveen Byrne & Associates,
Lioscarran House,
32 Dale Road,
Kilmacud,
Stillorgan,
Co.Dublin.

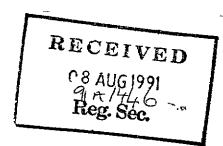

2nd August 1991.

RE: PROPOSED HOUSING AT SPRINGVALE, BALLYBODEN.

Dear Auveen,

With reference to the additional information requested by Dublin County Council in their letter dated 22nd May 1991, we would comment as follows to the individual items:

Item no.3.

Cross sections have been plotted across the site at three locations showing the bank to the rere of houses nos 1-21. These sections have been examined by Mr B.Morris, Dublin County Council and he is generally satisfied with the current profile of the bank, as shown on drawing no.91/047/107. The possibility of providing a line of land drainage directly behind the rere fencing was discussed, and this may be a condition of approval.

Mr Morris requested that an additional section be plotted across the site through house no.26. This section is shown on drawing no.91/047/109.

As can be seen from the various cross-sections, the gradient of the banks to the rere of houses nos.1-21 has been greatly reduced, thereby greatly increasing the stability of same. Formal certification may not be required now and this can be discussed with Mr Morris.

Item no.4 Bridgeworks.

The main bridgworks drawings have been amended in accordance with the requirements from Dublin County Council. These revised drawings have been examined by Mr B.Morris, and again he is generally satisfied with the current details. The possibility of providing eyes in the abutments was discussed and this may be another condition of approval. A standard structural design certificate is attached to cover the aforementioned bridgeworks.

Item no.5. A longitudinal section of the existing bed level was plotted from a distance of 30 metres upstream of the proposed development to a distance of 30 metres downstream. See drawing no.91/047/108.

Item no.7.

The floor levels of houses nos.1-21 have been raised by 1 metre. The lowest of these houses (nos.16,17,18,19,20 & 21) have a finished floor level of 86.20m. The flood plane has been taken at 85.60m. This gives a clearance of 600mm to the lowest houses along this line.

With regard to the stability of the house closest to the stream, foundation details will be subject to opening up works on site in this area and all details will be agreed with the Dublin County Council inspector for the area. If formal certification is required at that stage, we will issue same.

Item no.9.

The pipe was moved to the outside of the bridge for the re-submission of drawings. However in discussion with Mr B.Morris, it was decided to leave this pipe within the bridge deck and that the final details could be submitted as a further condition of approval.

We trust that the above comments, together with the revised drawings, will meet the requirements of Dublin County Council.

Yours faithfully,

CAREW ASSOCIATES.

CAREW ASSOCIATES CONSULTING ENGINEERS

22 CROFTON ROAD, DUN LAOGHAIRE, CO. DUBLIN.

TELEPHONE: (Q1) 2809827, 2844334

MOBILE:

088-557302

FAX:

2809944

DATE: 2/8/91 ___

STRUCTURAL CERTIFICATE

PROJECT: Bridgeworks For Proposed Housing

Development At Springvale Ballyboden.

The structural design of the above project is in accordance with the relevant Irish and British Codes of pratice and has been carried out under the supervision of a Chartered Structural Engineer.

CAREW ASSOCIATES.

M.J. CAREW, C. Eng., M.I.E.I., M.I.Struct, E., M.A. C.E.I.

CAREW ASSOCIATES

CONSULTING ENGINEERS

22 CROFTON ROAD, DUN LAOGHAIRE, CO. DUBLIN.

TELEPHONE: (01) 2809827, 2844334

MOBILE: FAX:

-- 088-557302 2809944

DATE: 2/8/91

STRUCTURAL CERTIFICATE

PROJECT: Bridgeworks For Proposed Housing Development At Springvale Ballyboden.



The structural design of the above project is in accordance with the relevant Irish and British Codes of pratice and has been carried out under the supervision of a Chartered Structural Engineer.

CAREW ASSOCIATES.

9:46AM ;

*;*17- 7-91

Ø4564478->

01889747;# 2


BALLYMORE HOMES LIMITED, BALLYMORE EUSTACE, CO. KILDARE, IRELAND. TELEPHONE: (045)64164, 64445. TELEFAX: (045)64478.



15th July 1991.

P. Rafferty Esq., Dunboden Estates, C/O Crowley Millar, Solicitors, Tr. Mount Street, Dublin 2.

Re: Springdale

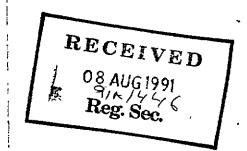

Dear Sir.

Further to your letter of 11th July 1991, I wish to confirm that it is our intention to grant a way leave to re-route the drain at the boundary between our land and Springdale through our land, approximately 5 - 6 metres south of the boundary as shown on drawings prepared by Gerard Cantan.

The gize of pipe and design of outfall to be to the satisfaction of Dublin County Council. This way leave will be granted whether or not permission is achieved by us for development of our lands.

Yours faithfully, BALLYMORE HOMES LTD.

c.c. Auveen Byrne

CAREW ASSOCIATES

CONSULTING ENGINEERS

22 CROFTON ROAD, DUN LAOGHAIRE, CO. DUBLIN.

TELEPHONE: (01) 2809827, 2844334

MOBILE:

088-557302

FAX:

2809944

DATE: 2/8/91

STRUCTURAL CERTIFICATE

PROJECT: Bridgeworks For Proposed Housing

Development At Springvale Ballyboden.

RECEIVED


08 AUG 1991 91 A / 4 76 **Reg. Sec.**

The structural design of the above project is in accordance with the relevant Irish and British Codes of pratice and has been carried out under the supervision of a Chartered Structural Engineer.

Canondoyle

CAREW ASSOCIATES.

RESEVOIR PROPOSED HOUSING DEVELOPMENT AT SPRINGVALE BALLYBODEN SITE LOCATION MAP SCALE 1:2500 DATE 28/6/91 **11111** RECEIVED _ .ORCHARD SPRINGVALE EUMONSTOWN DOM MOY VILLE HOUSING **EDMONSTOWN** ESTATE

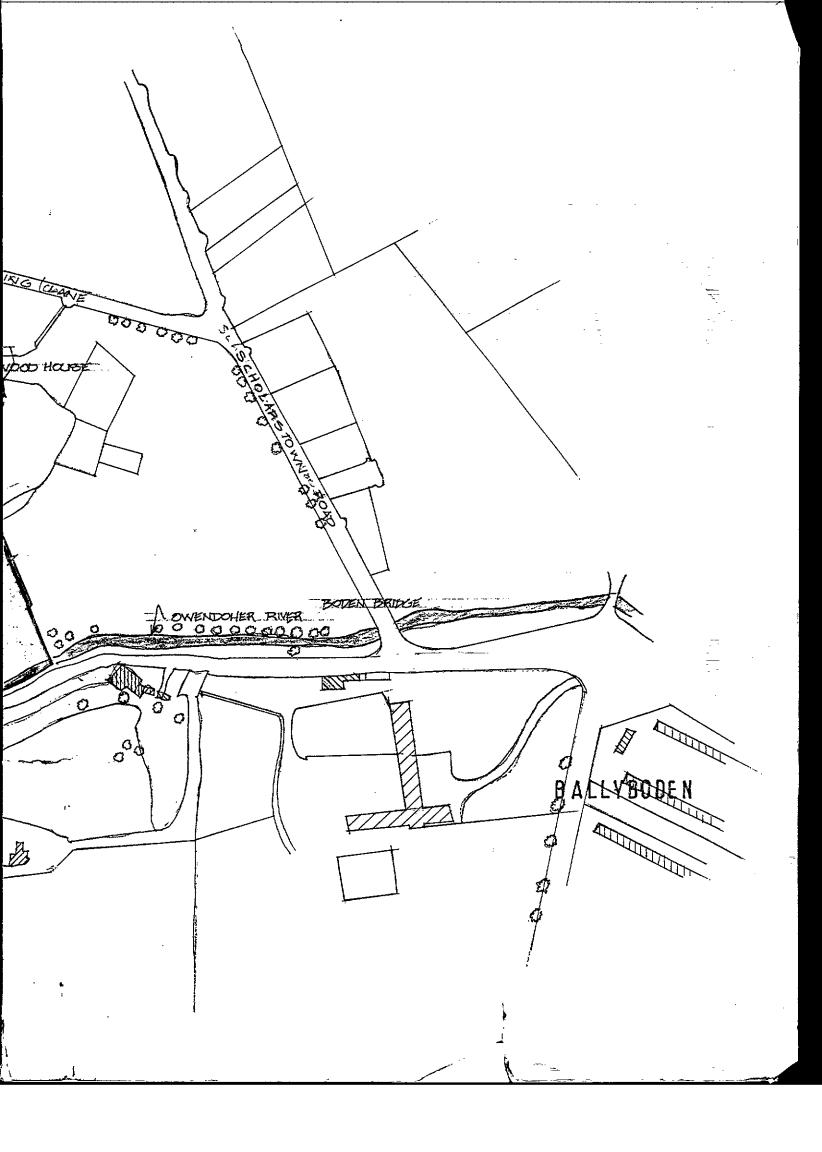




AUVEEN BYRNE & ASSOCIATES.

Consultant Town Planners.

Lioscarran House, 32 Dale Road, Kilmacud, Stillorgan, Co.Dublin.

> Telephone: (01) 831611, Facsimile: (01) 889747.

The Principal Officer, Planning Department, Dublin County Council, Block II, Irish Life Centre, Lower Abbey Street, Dublin 1

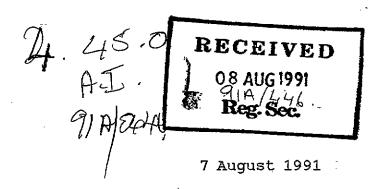

ADDITIONAL INFORMATION

DUBLIN COUNTY COUNCIL REFERENCE NUMBER 91A/0446 RE: APPLICATION FOR PERMISSION FOR 41 HOUSES AND RELOCATION OF ENTRANCE TO EXISTING HOUSE ON SITE AT SPRINGVALE, BALLYBODEN CO. DUBLIN.

Dear Sir,

I refer to the above application and in particular to your request for additional information dated 22.05.1991. I wish to respond on behalf of my clients, the applicants Dunboden Estates Limited.

The following drawings are enclosed;

- Revised site location map.
- Gerald Cantan & Associates, Architects, Drawing No. 579/41a.
- Revised site plan.
- The following drawings of Carew & Associates, Consultant Engineers;
 - 91/047/101 Roads and Drainage: Sheet 1 (Revised July 1991)
 - 102 Roads and Drainage: Sheet 2 (Revised July 1991)
 - 103 Roads and Drainage: Sheet 3 (Revised July 1991)
 - 104 Drainage: Sheet 4
 - 105 Bridgeworks: Sheet 1
 - 106 General Arrangement Bridgeworks (Revised July 1991)

 - 107 Sections AA, BB, CC. 108 Longitudinal Sections along riverbed.
 - 109 Section DD.
- Cover letter of Carew & Associates, Consultant Engineers.

The points raised in your letter are dealt with as follows, the paragraphs numbers corresponding to yours;

RE: Item 1:

The revised site layout in Gerald Cantan & Associates drawing 579/41a shows provision of 41 semi-detached houses as opposed to the terraced ones shown on the lodged drawings.

The revised house type shown in this site layout now corresponds with the house plans lodged with the application originally, and no discrepancy in this regard now exists.

RE: Item 2:

Gerald Cantan & Associates revised site location map shows the site boundary at the northern end of the site adjusted to match that shown on the revised site layout drawing.

I wish to confirm that the small projection of the site boundary in the north eastern corner of the site included in the original site location map, but not in the original site layout map, is not in the applicant's ownership and is not now shown as part of the development.

RE: Item 3:

This is dealt with under a similar heading in Carew & Associates letter of 2/8/1991 attached.

RE: Item 4:

See Carew & Associates letter of 2/8/1991. No retaining wall is proposed behind houses 1 to 21 as same is unnecessary as the Consulting Engineer's letter demonstrates.

RE: Item 5:

See Carew & Associate's letter.

RE: Item 6:

I attach copy of a letter from Ballymore Homes Limited, owners of the adjoining site to the south of the subject site. The letter confirms that the culverted stream currently running along the southern boundary of Springvale will be diverted into the Ballymore Homes Limited site when Dunboden Estates Limited are ready to commence development. The letter confirms that the said works will be carried out whether or not Ballymore Homes Limited carry out development of their site.

This diversion of the stream in question enables my client to retain house number 1 in it's currently proposed position.

RE: Item 7:

See Carew & Associates letter of 2/8/1991.

RE: Item 8:

Discussions are currently underway between Dunboden Estates Limited and Dublin Corporation in relation to routing of the water main and scour water main through my client's site. However, per reference numbers 88a/14 (OP) and 89a/367 (Approval) Dunboden Estates Limited have permission to develop for housing that portion of the site currently proposed to take the revised housing layout. Dublin Corporation's proposals for provision of water mains to serve the general area should not affect any decision on this application.

RE: Item 9:

See Carew & Associates letter of 2/8/1991.

I trust the above consitutes a full and satisfactory reply to your request for additional information and look forward to an early decision in the matter.

Yours faithfully,

AUVEEN BYRNE

Dul

County Council Comhairle Chontae Atha Cliath

Planning Department

Building Control Department, Liffey House, Tara Street, Dublin 1. Telephone:773066



Bloc 2, Ionad Bheatha na hEireann, Block 2, Irish Life Centre, Sraid na Mainistreach Iacht, Lower Abbey Street, Baile Atha Cliath 1. Dublin 1. Telephone. (01)724755 Fax. (01)724896

Register Reference: 91A/0446

Date: 12th August 1991

LOCAL GOVERNMENT (PLANNING AND DEVELOPMENT) ACTS, 1963 TO 1990

Dear Sir/Madam,

DEVELOPMENT: Revised development of 44 houses on 5.6 acre site of

previously approved developments (O.P.ref.no. 88A/0014, appro.ref no.89A/0367) and relocation of entrance to

existing house on adjoining site

LOCATION : "Springvale" Edmondstown Rd. Ballyboden

APPLICANT : Dunboden Estates Ltd.

APP. TYPE : Additional Information

With reference to the above, I acknowledge receipt of your application received on 8th August 1991.

Yours faithfully,

for PRINCIPAL OFFICER

Auveen Byrne & Assoc., Lioscarran House 32 Dale Rd. Kilmacud Co.Dublin Auveen Byrne & Associates, Lioscarran House, 32, Dale Road, Kilmacud, Stillorgan, Co. Dublin.

Reg. Ref. 91A-0446

22 May 1991

Re:

Proposed revised development of 41 houses on 5.6 acre site of previously approved developments (0. P. Ref. No. 88A-0014, appro. Ref. No. 89A-0367) and for relocation of entrance to existing house on adjoining site at Springvale, Edmondstown Road, Ballyboden for Dunboden Estates Ltd.

Dear Sir/Madam,

With reference to your planning application, received here on 26th March, 1991, in connection with the above, I wish to inform you, that before the application can be considered under the Local Government (Planning and Development) Acts, 1963-1983, the following additional information must be submitted in quadruplicate:-

1. The applicant is requested to indicate if he is willing to modify the proposed layout drawing to show the provision of semi-detached houses as per lodged house plans instead of terraced housing, and if so to submit a revised site layout showing this change.

It should be noted that there is a discrepancy between the size of the proposed houses as shown on the floor plans and the size of the houses as shown on the site layout. This discrepancy should be rectified and the applicant should demonstrate that Development Plan Standard with regard to space around dwellings can be met.

It is noted that the site as shown on the site location map differs from that shown on the site plan. In particular the applicant is requested to clarify its interest in that portion of the site (i.e. the north east corner of the site) shown as part of the site on the site location map and excluded from the site on the site plan.

(Continued)

(Continued)

- 3. The applicant is requested to submit a letter from a chartered structural engineer certifying the stability of the bank to the rear of houses nos. 1-23.
- 4. The applicant is requested to submit structural details (including scaled drawings) of the proposed bridge, river training wall, proposed new boundary wall and any proposed retaining walls behind houses nos. 1-23, together with a letter of certification for the structural design of these structures from a Chartered Engineer.
- 5. The applicant is requested to submit a longitudinal section of the existing bed level of the river upstream and downstream of the proposed development.
- 6. The applicant is requested to show the provision of a 5 metre distance between the culverted stream on the south boundary of the site and the nearest house.
- 7. The application is requested to confirm that the finished floor levels of houses nos. 1-23 to be at least 0.3 m above the highest recorded flood levels of the stream. The applicant is also requested to submit a letter of certification from a Chartered Engineer demonstrating the stability of the proposed house closest to the stream.
- 8. Dublin Corporation have scheduled improvement works to the watermain infrastructure in the area. These works include the laying of a 1,000 mm. diameter watermain from Ballyboden Reservoir to Stillorgan Reservoir and the laying of a 600 mm. diameter scour watermain from Ballyboden Reservoir to the Owendoher River. Both of these mains are scheduled to traverse this site.

The Applicant is requested to submit information indicating how these works can be accommodated within the proposed housing layout. The applicant should note that both mains will require ready access and carry with them a sterilized wayleave of 20 metres total width each. The applicant is advised to consult with the Sanitary Services Department Water Division prior to submitting this information.

9. The applicant is requested to submit an acceptable detail for the sewer crossing of the Owendoher River.

Please mark your reply "ADDITIONAL INFORMATION" and quote the Reg. Ref. No. given above.

Yours faithfully,

for Principal Officer.

Auveen Byrne & Associates, Consultant Town Planner, Lioscarran House, 32 Dale Road, Kilmacud, Stillorgan, Co. Dublin. 91A/0446

16 April 1991

RE:

Application for permission for revised housing development on 5.6 acre site of previously approved development (O.P. Ref. No. 88A/0014, Approval Ref. No. 89A/0367) and relocation of entrance to existing house on adjoining site at Springvale, Edmondstown Road, Ballyboden.

Dear Madam,

I refer to your letter of 11th April, 1991, in connection with Planning Application Register Reference Number 91A/0446, and wish to inform you that it is noted that the documentation submitted with 25th April, 1991, has been withdrawn. No further consideration will be given to this documentation.

Yours faithfully,

for Principal Officer.

. 5

COMPANY:

FAX NO: 724896 PAGE /

MULLEN BY RICE DATE: 10/4/91

Ref No: 7588

3YRNE & ASSOCIATES,

Consultant Town Planners,



lotes from 3M

FROM

COMÍ

Post-it

Lioscarren House, 32 Dale Road, Kilmacud, Stiliongan, Co.Dublin.

> Telephone: (01) 631611. Facsimile: (01) 639747.

The Principal Officer, Planning Department, Dublin County Council, Block II, Irish Life Centre, Lower Abbey Street, Dublin 1

11 April 1991

Re: Dublin County Council Ref. No. 91A/0446
Application for permission for revised housing development on 5.6 acre site of previously approved development (O.P. Ref. No. 88A/0014, Appro. Ref. No. 89A/0367) and relocation of entrance to existing house on adjoining site at Springvale, Edmondstown Road, Ballyboden.

Dear Sir,

I refer to correspondence of 05.04.91 lodged by this office with your Department and enclosing corrected drawings in relation to the above.

Following discussions with your good selves, I now wish to withdraw the said submission. I await your communication.

Yours faithfully,

AUVEEN BYRNE

RECEIVED

O9 APR 1991

QUA OCCUPA

CAMBRIDA IN WAS AN OF




AUVEEN BYRNE & ASSOCIATES,

Consultant Town Planners,

Lioscarran House, 32 Dale Road, Kilmacud, Stillorgan, Co.Dublin.

Telephone: (01)2831611, Facsimile: (01) 889747.

The Principal Officer, Planning Department, Dublin County Council, Block II, Irish Life Centre, Lower Abbey Street, Dublin 1

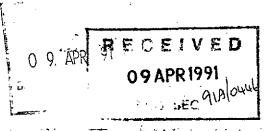

.5 April 1991

Re: Dublin County Council Ref. No. 91a/0446
Application for permission for revised housing development on 5.6 acre site of previously approved developments (O.P. Ref. No. 88a/0014, Appro. Ref. No. 89A/0367) and relocation of entrance to existing house on adjoining site at Springvale, Ballyboden for Dunboden Estates Ltd.

Dear Sir,

I refer to the above planning application lodged with you on 26.03.91.

Unfortunately, the wrong site layout map was inadvertently lodged with the application. I enclose 4 copies of the correct drawing - Gerald Cantan & Associates, Architects, Drawing No. 579/41.

The layout shows 41 semi-detached dwellings proposed, not 44 terraced and semi-detached as shown in the previously lodged drawing. I enclose a revised newspaper notice displaying this change. As far as the cover letter from this office lodged with the application is concerned, only 3 small points require changing;

In paragraph 2.1, the final sentence should read

"It is proposed to build 41 units comprising 32 x 89 sq metre 3-bed units and 9 x 101,sq metre 4-bed units."

At Paragraph 2.3, the density of development is 7.3 units per acre not 7.8 as previously stated.

CO. DUBLIN — Full permission is sought from Dublin Counfy Council for revised development of 41 houses on 5.6 ac. site of previously approved developments (O.P. Ref. No. 88a/14. appro. Ref. No. 89a/367) and for relocation of entrance to existing house on adjoining site at Springvale, Edmondstown Rd., Ballyboden for Dunboden Estates Ltd.

13.0 + Nouselle AND J. Tunes 5/4/91 Otherwise the information contained in the letter remains unchanged despite the error, as does its overall thrust and sense.

To conform with the corrected site layout, Carew & Associates, Consulting Engineers, Drawing No. 89/006/01 - Roads And Drainage General Arrangement Sheet 1, required a small adjustment. The rear gardens of Units 22-29 are slightly shorter than shown in the originally lodged drawing. Their length still complies with the County Council's minimum standard of 10.7 metres. Note that the rest of Carew & Associates drawing and all of their remaining documentation remain unaffected by this change.

I apologise for any inconvenience the lodgement of this revised information may cause.

Yours faithfully,

AUVEEN BYRNE

09 APR 1991 9/A (04 Ub)

Dublin County Council Comhairle Chontae Atha Cliath

Planning Department

Building Control Department, Liffey House, Tara Street, Dublin 1. Telephone:773066



Bloc 2, Ionad Bheatha na hEireann, Block 2, Irish Life Centre, Sraid na Mainistreach lacht, Lower Abbey Street. Baile Atha Cliath 1. Dublin 1, Telephone. (01)724755 Fax. (01)724896

Register Reference : 91A/0446

Date: 27th March 1991

LOCAL GOVERNMENT (PLANNING AND DEVELOPMENT) ACTS, 1963 TO 1990

Dear Sir/Madam.

DEVELOPMENT: Revised development of 44 houses on 5.6 acre site of

previously approved developments(O.P.ref.no. 88A/0014, appro.ref no.89A/0367) and relocation of entrance to

existing house on adjoining site

LOCATION : "Springvale" Edmondstown Rd. Ballyboden

: Dunboden Estates Ltd. APPLICANT

APP. TYPE : PERMISSION/BUILDING BYE-LAW APPROVAL

With reference to above, I acknowledge receipt of your application received

Yours faithfully,

PRINCIPAL OFFICER

Auveen Byrne & Assoc., Lioscarran House 32 Dale Rd. Kilmacud Co.Dublin

Dublin County Council Comhairle Chontae Atha Cliath



Planning Application Form/ Bye - Law Application Form

PLEASE READ INSTRUCT	TIONS AT BACK BEFORE COMPLETING FORM	. ALL QUESTIONS MUST BE ANSWERED.
 Application for Permission Approval should be sought only retention of structures or cont 	Outline Permission Approval Place in approval Place in approvement of uses,	ropriate box. ed. Outline permission may not be sought for the
(If none, give description	ng "Springvale", Edmondstown	
. Name of applicant (Principal n	ot Agent). Dunboden Estates Ltd	Water State Commission of the
Address		Tel. No.
Name and address of	Gerald Cantan Architect	7.420
person or firm responsible for preparation of drawings		Tel. NoTel. No
Name and address to which	Auveen Byrne & Assocs., Cons.	Town Planners, Lioscarran House
notifications should be sent	32 Dale Road, Kilmacud, Still	organ, Co. Dublin.
Brief description ofproposed development	44 Houses	***************************************
Method of drainage Publi	.c Mains 8. Source of Water	Supply Public Mains
. In the case of any building or	buildings to be retained on site, please state:-	
(a) Present use of each floor or use when last used	N/A	J. 1 was
(h) Proposed use of each floor	Residential	22181
or change of use of any habitat	olition, partial demolition No No S.6 acres	
	restate in site Freehold Owner	
Are you now applying also for a	n approval under the Building Bye Laws?	
Pico. DUBLIN — Full permi is sought from Dublin Co Council for revised develop	ssion St Building Regulations have been taken in sounty	account in your proposal:
of 44 houses on 5.6 ac. sill previously approved developments (O.P. ref. No. 88	E UL L'Assessed nateurs sesses es regionales accesses es regionales accesses accesse	***************************************
appro. ref. No. 89a/367) and relocation of entrance to exi	for #- Can Cahadula abbaaba	d
house on adjoining site at Sp vale. Edmondstown Rd	ring- tally-	
boden for Dunboden Estates	Ltd. JA	
	evelopment (See back)	
No of dwellings proposed (if any	()	1 planning application and £55/nou
Fee Payable £ 3828.00 If a reduced fee is tendered deta	Basis of Calculation	re Bye-Law application.
Signature of Applicant (or his A	gent) (Lissel Africa	Date 26 03 d/.
Application Type	FOR OFFICE US	
Register Reference9	2-48.	20.4 "ECEIVE
Amount Received E	988994444-4004269444444444	RECEIVED 26 MAR 1991 REG. SEC
Date	>>>>>Page Page Page	REG. SE

COMHAIRLE	CHONTAE A'	THA CLIAT	H	CEIPT CODE
CASR Cyleonie	46/49 UPPER O'CC DUBLII	ONNELL STREET	ewiedsement to die in the diesesting	Poi Gralication
Received this	- :	08.00 26th	yot Marc	L 19.91
from Dissolition		12) 1	ினாள் இன்று இரு வறு சிறுவின் பிறுவும் ஆவரும் ஆவரும் படியாம் விறுவின் இருவின் இருவின் இருவின் இருவின் இருவின் இருவின் இருவின் இருவின	
the sum of	Mestand (jour hun	Olved C	1917 Pounds
danning Edwin	star Rd	cu at	Spring Carey	16281-1411
Fine Rocke	Doans	Cashier	Principal Offic	er

			RECEIPT	CODE
IN COUNTY COUNCIL	1.5			The state of the s
46/49 UPPER O'CONNELL DUBLIN 1.	STREETBYE LAW	APP	ICATION.	
	REC. No.	N	34657	· 思·思尔克·福德· ··································
71#	er essemedayof	ارية. مصور سي		<u></u>
Ct. 1.)	itaniana da	er (Ta ^Q enaVannannangannan) er (Taking Takan angangan)	ter Marriage .
and the same and t	man fin a man sama ang sandhalang a sa s	an daga paga paga paga paga paga paga paga		
16, 11, 12	2) Jalan ¥rr	1 reven	Pounds
Merchanis and a grant of the standard of the analysis and	Pence he			/ Carounus
application,	al Don	ifina	6"	in a Tea de a caign gar : 1 1167 pa , − 1166 1177 april
Time Rolling	The same of the sa		Laber . But The But	o ne l igens de T.C.
DOCashie	er <i>Pr</i>	S. CAR incipal C	EY Officer	17.7
	E ZUZO Z	# ACC PER O'CONNELL STREETBYE LAW DUBLIN 1. REC. No. # ZU2000 # day of Pence, be Pe	ACAD COUNTY COUNCIL 46/49 UPPER O'CONNELL STREETBYE LAW APPL DUBLIN 1. REC. No. No.	E ZUZOOO Aday of Pence, being Rec. No. Rec. No. Rec. No. Rec. No. Pence, being



AUVEEN BYRNE & ASSOCIATES,

Consultant Town Planners,

A DIE WAS THE BEGINNERS TO SEE STATE

26 MAR 1991.

... AlA IDIEGE

Lioscarran House, 32 Dale Road, Kilmacud, Stillorgan, Co.Dublin. Telaphone: (01) 831611, Facsimile: (01) 889747.

The Principal Officer, Planning Department, Dublin County Council, Block II, Irish Life Centre, Lower Abbey Street, Dublin 1

25 March 1991

Re: Application for full permission for revised development of 44 houses and relocation of entrance to existing house adjoining to the west at Springvale, Edmondstown Road, Ballyboden.

Dear Sir,

On behalf of my client, Dunboden Estates Ltd, I wish to make an application for planning permission as set out above.

I enclose;

- Planning Application Form.

Newspaper Notice.

- 4 x Copies Drawings as set out in the attached schedule.

Planning Application Fee.

In support of the application, some background information and comment would be helpful.

- 1.0 PLANNING HISTORY OF THE SITE.
- 1.1 The 5.6 acre site at Springvale, Ballyboden is zoned agricultural under the current County Development Plan 1983.
- 1.2 Per Ref. No 88A/14, outline permission was achieved in respect of an application for 32 houses on the site. Material contravention procedures were adopted to enable Dublin County Council to decide to grant permission. The County Council's decision was confirmed by An Bord Pleanala following a Third Party appeal on 30.11.88. This outline permission is valid until November 1983.
- 1.3 On the 18.01.90, An Bord Pleanala, again pursuant to a Third Party appeal of a favourable decision of Dublin County Council, issued a grant of approval based on this outline permission. This was Dublin County Council Ref. No. 89A/367.

Permission was sought for 32 houses. The Bord's decision required the elimination of house No. 1 on grounds that it interfered with access to a culverted surface water stream on the southern boundary of the site. Thus permission was confirmed for a residential density of 5.5 houses per acre.

1.4 A high quality layout was approved. 42% of the site area was dedicated to public open space, well in excess of the County Council's requirement of 20%. The open space was designed to focus on a stream which runs along the eastern boundary of the site. Houses were designed to face the public open space where possible. There are many mature trees on the site and as many as possible of these were proposed to be retained in the layout. A landscaping scheme was proposed to augment existing planting.

Access to the proposed development was via a new bridge over the stream. The existing front boundary wall was to be set back. This was to provide adequate sight lines for cars accessing the site. However it would also effect a necessary improvement in a bad bend on the Edmondstown Road. The Planning Authority have no plans to carry outwent improvements on this stretch of the Edmondstown Road and are thus dependent on the proposed development to effect the improvement.

26 MAR 1991

2.0 THE PROPOSED DEVELOPMENT.

GIALOUGE.

2.1 The average floor area of the houses approved per 89A/367 was 133 sq metres including a garage. Dumboden Estates Ltd feel that the market has changed since this permission was granted over a year ago. They now wish to provide a smaller house type on the site. They proposed to build 44 units comprising 34 x 89 sq metres 3 hed units and 10 x 101 sq metre 4 bed units.

2.2 The layout is very similar to that previously approved. Precisely the same access design is proposed, and a very similar bridge arrangement across the Owendoher stream. The same road layout is proposed.

Precisely the same area of land is to be reserved as open space. The same trees to be preserved and the same landscaping proposals to be implemented.

All conditions of the approval on Ref. No. 89A/367 are met in the proposed scheme.

2.3 The increase in density proposed is justified. The proposed density is 7.8 houses per acre, still well below the County Council's maximum permissible 10 houses per acre. 42% of site area will still be public open space, over double the normal requirement of the County Council. While the number of houses has increased, their size has decreased. The overall floor space to be provided will actually decrease if this revised development is approved.

As the site is serviced and has the benefit of permission for development, it is reasonable to expect that it will be re-zoned residential in the forthcoming review of Dublin County Council's Development Plan. If so the proposed density will appear modest and the level of open space to be provided generous.

Note that since the County Council's decision to grant outline permission on the client's site, a decision to grant permission has issued in respect of 163 houses on a site adjoining my client's to the south and west. This is Dublin County Council Ref. No. 90A/543, confirming the contention that it would be appropriate to consider re-zoning of my clients and adjoining lands.

- 2.4 On this occasion, the problem of the proximity of a proposed dwelling to the culverted stream on the southern boundary of the site has been solved. The southwestermost point of the nearest dwelling is 4 metres from the piped stream and the southeasternmost end 5 metres from it. This value be UNCIL of sufficient setback to meet the County Council's needs for access.
- 2.5 As on the previous occasion, permission is also 25 MARITH the relocation of the existing access to the residents to quality the west of the development site. Its access currently cuts through the site and needs to be coordinated with the proposed development.

3.0 SEWERAGE FACILITIES.

3.1 The upgrading of a particular substandard length of the sewer in the Ballyboden Road will be required to facilitate the proposed development. In the course of consideration of Ref. No. 89A/367 by both Dublin County Council and An Bord Pleanala, considerable attention focused on the appropriate level of contribution to be charged in respect of this facility. It is noted that the Bord in its wisdom imposed Condition 12 in respect of Ref. No. 89A/367 which states

"The developer shall pay a financial contribution to Dublin County Council towards the cost of upgrading the existing foul sewer in the Ballyboden Road which will facilitate the proposed development. The amount of the contribution and the time and method of payment shall be agreed with the County Council or in default of such agreement shall be determined by An Bord Pleanala. This contribution shall be levied on this development on a proportionate basis (per house), relative to approved new development in the catchment area which would utilise the increased system capacity and allowing for the degree to which the sewer may already be overloaded."

I trust the Planning Authority will reflect the principles of this condition should a decision to grant in the instant case be contemplated.

4.0 CONCLUSION.

- 4.1 The proposed development is for a higher number of houses but a lesser floor area than that of a development already approved on the site.
- 4.2 The density of the proposed development is still well below the County Council's permitted maximum and the amount of open space well above same.
- 4.3 The development in all other respects is similar to that approved and accords with the conditions of the Bord's approval decision.

On the above bases, I trust that a decision to grant permission can issue in respect of the enclosed.

Figure 1985 Control Section

26 MAR 1991

QIA OULL

Yours faithfully,

AUVEEN BYRNE

Application for full permission for revised development of 44 houses and relocation of entrance to existing house adjoining to the west at Springvale, Edmondstown Road, Ballyboden.

DRAWINGS SCHEDULE

Drawings of Gerald Cantan & Associates, Architects;


Site Location Map 579/42A Site Layout 579/43 4 Bedroomed House Plans 579/42 3 Bedroomed House Plans Outline Specifications

Drawings of Carew Associates, Civil Engineers;

Roads & Drainage Sheet 1 89/006-01 89/006-02 2 11 17 ** 89/006-03 3 ** * * • 89/006-04 SV/891/05 Bridgeworks Sheet 1 General Arrangement Bridgeworks. 89/006-06A Drainage Specification Notes Concrete Specification Notes Blockwork Specification Notes Structural Design Calculation

Drawings of P.C. Roche & Associates, Landscape Architects;

Tree Survey (Southern Tree Surgeons)
E 104/204 Tree Survey Evaluation.
E 104/205 Landscaping Proposals.
Specification for landscaping and planting.

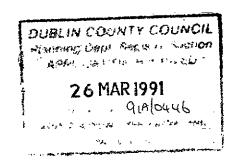

SITE LOCATION MAP FOR PROPOSED HOUSING DEVELOPMENT AT SPRINGVALE, BALLYBODEN FOR THE DUNBODEN DEVELOPMENT


 \bigcirc 0 \cdot

EXTRACT FROM 05. DUBLIN

SHEETS 22/14

SCALE 1-2500

RESERVOIR

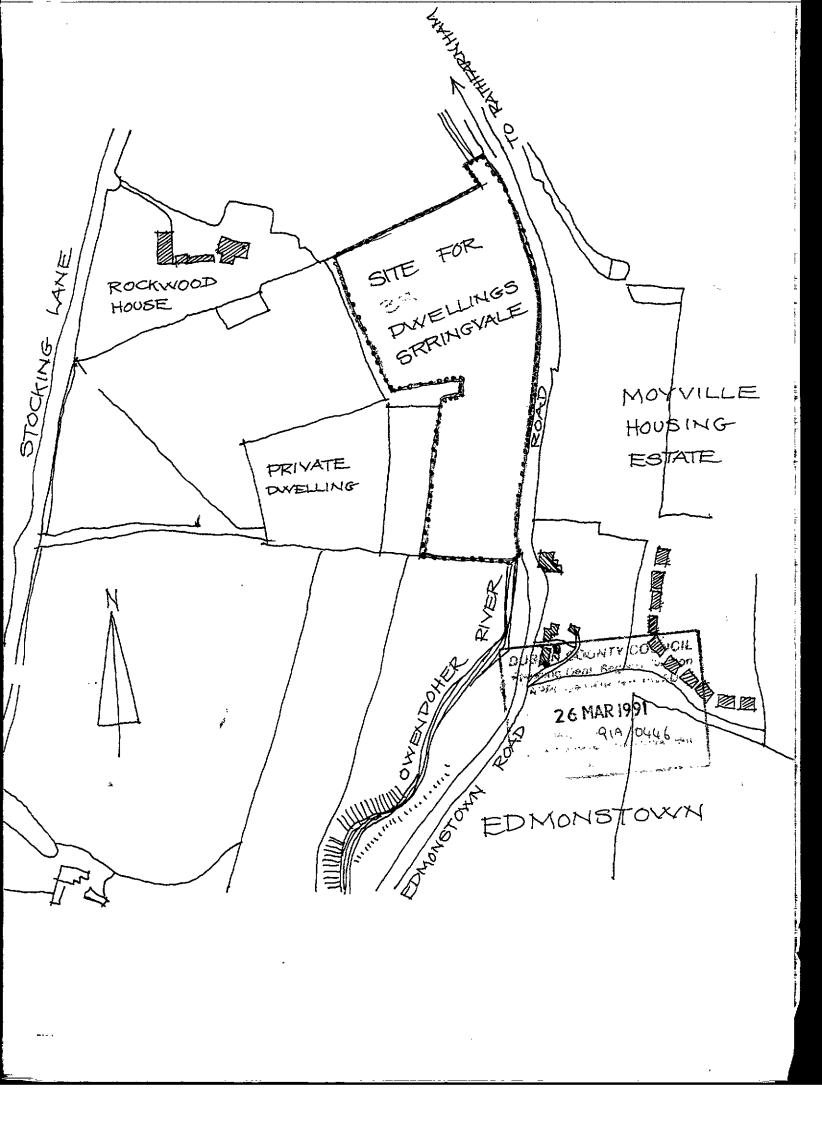

OUTLINE SPECIFICATION

<u>O</u>F

MATERIALS AND LABOUR TO BE USED IN THE CONSTRUCTION OF DWELLINGS

AΤ

SPRINGVALE, BALLYBODEN, CO.DUBLIN

Architects:

Gerald Cantan Dip.Arch. M.R.I.A.I., Owenstown House, Fosters Avenue, Blackrock, Co.Dublin

DUBLIN CONINTY COUNCIL MARING CALL MARINE SACRON 26 MAR 1991 91A 0446

Structural Engineer:

Carew Associates, 22 Crofton Road, Dun Laoghaire, Co.Dublin

THE WORKS IN GENERAL

The works in general are to consist of the construction of 3 and 4 bedroomed two storey houses at Springvale, Ballyboden. roads, drains and other site development works will be constructed in accordance with detailed specification of Carew Associates, Consultant Engineers.

FOUNDATIONS

Foundations shall be constructed in concrete reinforced as directed by structural engineer. foundations are to extend on either side of the wall they support for a width equal to the width of the wall. Foundations are to be a minimum of 300mm deep. Foundations are to be placed at formation levels approved by structural engineer and Building Control Department of Dublin County Council before placing of concrete. Foundations are to be formed level with maximum steps of 225mm unless specifically directed by engineer. Any excess excavation is to be backfilled with lean mix concrete. Foundations shall be placed below all drains and adjacent underground services.

RISING WALLS

Rising walls shall be constructed in solid concrete blockwork using sand cement mortar only. Rising walls shall be fully bonded within themselves and to each other. All cavities below the ground shall be filled with concrete to within 250mm of ground level where they shall be drained to ground by leaving perpends open. Rising walls shall be bridged over all drains and other underground services using precast concrete lintels.

GROUND FLOOR

Ground floor shall be formed with a 150mm (30N) concrete slab laid on a damp proof membrane of Visqueen 1000 on a 50mm sand blinding on compacted graded hardcore. Hardcore to be graded 50mm-100mm and compacted in 250mm layers. Ground floor to be finished with 50mm sand cement screed.

GROUND FLOOR CONTD/...

Visqueen damp-proof membrane to be turned up at edge of slab and turned over rising walls to unite with horizontal d.p.c. A 1 metre deep strip of 50mm board insulation shall be placed on the internal surface of the external rising wall before back filling.

EXTERNAL WALLS

External wall to front elevation shall be formed with a 100mm clay brick outer leaf, a 50mm cavity and a 100mm solid concrete block inner leaf. Leaves of masonry to be tied together with stainless steel bar ties at 900mm centres horizontally and 450mm centres vertically. Cavity is to be sealed at top and around external opes.

Damp proof courses are to be laid under cills, over lintels stepped outwards and vertically where cavities are closed.A horizontal damp proof course is to be laid over rising walls.

External walls to side and rear are to be 215mm hollow concrete blockwork fully bonded within itself and to internal walls. These walls are to be mudded, rendered and floated with 3:1 sand cement plaster to a nap finish. Plaster to contain a proprietary water proofing agent.

All internal surface of external walls are to be laid with insulation and dry lining fixed to treated timber grounds. A vapour barrier is to be placed over the inside surface of the insulation fixed to grounds.

PARTY WALL

Party wall is to be constructed in 215mm solid concrete blockwork from damp proof course over rising walls to underside of roof finish. Form to profile of roof finish and pack max 18mm gap over wall with fibreglass quilt.

INTERNAL WALL

Internal cross wall is to be constructed in 100mm solid concrete blockwork on d.p.c. on rising wall.

PERMANENT VENTILATION OPES

From permanent ventilation openings as indicated and fit with galvanised steel grill to exterior and p.v.c. screen to interior seal cavity around ope.

CILLS

Cills to front of dwelling are to be proprietary clay brick specials bedded in mortar and laid on d.p.c. turned up at back and sides. Cills to side and rear are to be proprietary precast concrete cills laid on d.p.c. turned up to back and sides.

LINTELS

Lintels to concrete blockwork are to be proprietary precast concrete lintels. Lintels to have a min of 225mm solid concrete blockwork above and a min bearing of 150mm at each end. Prop lintels in centre of span until blockwork is set. Lintels to brickwork to be proprietary steel lintels catnic or similar to engineer's specification.

FIRST FLOOR STRUCTURE

The first floor structure is to consist of 200 x 50mm white deal joists at 400mm centres bearing on external and internal walls. ends of joists are to be treated. Fit row of herringbone bridging to centre of span. trim out for stairs with 200 x 75 trimmers.

Deck first floor with ex 25 x 150 T & G boarding tightly cramped and nailed to each joist.

ROOF STRUCTURE

Roof structure is to be formed with proprietary turned timber rafters fabricated and fitted in accordance with Irish Standard. A design certificate to be submitted to the structural engineer for approval before the trusses are fabricated and fitted. Trusses are to have horizontal and diagonal bracing in accordance with Irish Standard. Trusses are to be trimmed out for lightwells in accordance with engineer's instruction. Bearing timbers for water tanks are to be fitted to distribute weight over at least 5 trusses.

Projecting roof to front is to be formed with cut timbers bearing on trussed rafters. Carry out rafters and extensions of ceiling ties to carry bay window members. Fit lay board over trusses and nail cut rafters to lay board. All to detail.

BAY WINDOW_STRUCTURE

Lintel cast over bay window to engineer's design and detail. Carry out first floor joists and form stud frame to front face and sides of bay. Fix stud frame to structural walls.

ROOFING

the roof is to be covered with proprietary concrete tiles on treated timber battens on a layer of sarking felt. Sarking felt to be turned over ridge, out at eaves and barges. Form verge to barge with slate undercloak and pointing.

Form lead valley gutter to either side of bays. Form flashings and bay to chimney.

ROOFING CONTD/...

Fit flashing sets to rooflights and around P.V.C. soil vent pipes.

Supply and fit p.v.c. raingear to eaves with downpipes taken down to discharge over gulley traps. Fabricate roof over entrance and tile with small concrete plain tiles. tile hang front of bay at first floor level with heart shaped concrete tiles nailed to battens over a layer of sarking felt. fit lead flashing from under first floor windows to form apron over vertical tiles.

EXTERNAL FINISHES

Brick finishes to front of dwelling, from plaster plinth at base. Side and rear of dwelling plastered with sand cement painted with masonry paint to selected colours.

INTERNAL FINISHES

Dry line all internal surfaces of external walls and partitions with 9.5mm plasterboard. Tape and fill joints. Line ground floor ceilings with 9.5mm plasterboard, tape and fill joints and apply stipple finish. First floor ceiling to be sheeted with foil backed 12mm plasterboard, fill and tape joints and stipple.

WINDOWS

Fabricate and fit double glazed p.v.c. framed windows. Fix securely in opes. Seal between window frame and masonry with 2 part polysulphide.

ROOFLIGHTS

Supply and fit proprietary (Velux) rooflights over bathroom. Fix night ventilator to each rooflight to provide permanent ventilation to each bathroom (as w.c. compartment). Supply and fit cord sets to make rooflights openable.

DOORS

Fabricate and fit hardwood framed front door with glazed light as indicated. Fabricate and for p.v.c. framed patio door and incorporate into glazed conservatory.

Internal doors to be proprietary panelled doors fabricated from partition board. Fir doors into softwood frames. Fit with ironmongery.

Fabricate and fit 600 x 600 trap dcor to roof void.

WARDROBES

Fabricate and fit wardrobe fronts to bedroom as indicated.

KITCHEN FITTINGS

Fabricate, supply and fit kitchen fittings.

SUNDRY JOINERY

Supply and fit skirtings, Architraves, window-boards etc.,

WATER SUPPLY AND DISTRIBUTION

A 12mm diameter p.v.c. water main is to be taken from a tapping Main is to be a minimum of 400mm of the common water main. below the ground. Take water main into dwelling and bring to kitchen sink location. Control with gate valve and bring supply to cold water tap to sink. 12mm diameter mains supply to rise to 60 gallon actual cold water cistern in roof void. Rising main to be controlled by fate valve and by ballvalve at Cold water cistern to have 25mm diameter overflow to discharge at rear eaves. Fit cistern with plywood cover and fully insulate. Each house is to have a 30 gallon copper hot water cylinder located in hot press. Cylinder to be fabricated in accordance with Irish Standard. Fit 18mm diameter expansions pipe taken to over cold water cistern.

WATER SUPPLY AND DISTRIBUTION

Take 18mm copper supplies off cold water tank and take to bathroom and hot water cylinder.

Take 18mm diameter hot supply from expansion pipe and bring to bathroom and kitchen. 12mm brand supplies to ground floor toilet.

SANITARY WARE

Supply and fit vitreous china w.c., wash sown suites with external overflow to each. Supply and fit acrylic baths and non-slip shower tray. Plumb in and connect to wastes. Supply and fit vitreous china lavatory and wash hand basins as indicated complete with chromed wastes, traps and taps.

DRAINAGE

general drainage to site to design and detail of Carew Associates. Ground floor W.C.'s are to discharge into A.J. or drain. first floor toilets are to discharge into soil vent stacks either externally or internally at first floor level. Internal soil vent pipes are to be carried up through roof void and out to terminate 900mm along the rooflights.

Wastes are to be trapped at fitting and taken out to discharge over gulley in the core of ground floor fittings or into soil vent stacks in the case of first floor fittings. All soil pipes taken internally are to be insulated against sound transmission.

Drains around dwelling are to be laid as indicated on beams. All drains are to be cased in concrete.

SOLID FUEL BURNER AND CHIMNEY

Solid fuel burner is to be a class 1 appliance of approved manufacture to burn smokeless fuel only.

Gathering of flue is to be formed with a proprietary precast lintel. Flue is to be lined with interlocking fireclay liners surrounded by a minimum of 50mm sand/lime parging. A lead damp proof tray is to be incorporated into the chimney at roof level. Chimney is to be capped in corbelled brick, haunched with concrete on a damp proof course.

PAINTING AND DECORATING

Softwoods externally are to be properly primed and prepared before coating with 2 coats of a water based breather paint to a gloss finish.

Hardwoods externally are to be coated with 3 coats of varnish. Softwoods internally are to be prepared and primed and finished with 2 coats of oil paint to a gloss finish. Walls internally are to be prepared with a selected wallpaper.

INSULATION

Roof void is to be covered with a 100mm fibreglass quilt. Any pipework above the first floor ceiling will be insulated. Pipework below the ground floor slab will be insulated and isolated from concrete. External walls are to be lined internally with 50mm insulation.

SITE WORKS

Paths and car stands adjacent to dwelling is to be laid in concrete on beded hardcore.

CAREW ASSOCIATES CONSULTING ENGINEERS

22 CROFTON ROAD, DUN LAOGHAIRE, CO. DUBLIN.

TELEPHONE: (01) 809827

FAX: (01) 809944

STRUCTURAL DESIGN
CALCULATIONS

FOR

BRIDGE BEAMS AND HOUSING

FOR

HOUSING DEVELOPMENT

AT

DUBLIN COUNTY COUNCIL
TRANSMIR COOK REGISTRY RECTION
APPRIL AT THE HOUSE OF

26 MAR 1991

SPRINGVALE, BALLYBODEN.

ARCHITECT.
GERALD CANTAN,
OWENSTOWN HOUSE,
FOSTERS AVENUE,
BLACKROCK.

CAREW ASSOCIATES		Contract: SPONGVANTE HOUSING.	i	99 006	Sheet No:
Sulf	ting Engineers	Part of Structure: BICIOAU		BY:	Oate: APÒL 90 '
Member Ref:		CALCULATIONS		<u>.</u>	OUTPUT
		11700 .			
	Jan 1800	7800.	1800,0	50	
				1	
		, burthinh		· 18	
		8.540		-l ·	
		CONCRETE DECK.			
	SPAN = 70.	~ ~ ~ ~ ~ ~ ~ ~ ~ ~ ~ ~ ~ ~ ~ ~ ~ ~ ~		4 1	
	,	HOTE (3.2.9.1) = 7.2			
		LOTTO-SL LATE 2.		Ī-	
	P .	40H LANT = 7.0/2 =	3. Cm		
		\$6001850 GPAN < 20.			
	TEMPS LATIOR	E RA-GE .	*:	-	٠.
	Mushman	DHAVE AIR TEMP $(Fig. 7) = -$ " $(Fig. 8) = 1$			
	HINDWINE THE	BODGE TEUP (1610) =	_7°	C.	
	CO-EFFICIET OF EXPANDION = 12×10-6/°C. ANTICIPATED BODOW FEWP AT WETTING = 15°C. NOMINAL EXPANDION = (32-15) 12×10-6×7=1 dm. NOMINAL UNTRACTION = (15+7) 12×10-6×7=19 m.				
	+ 103 + 2	13°C 6.5°C 15°C 7			

			_	
CAREW	ASSOCIATES	Contract: BPENGULT HOUSING	Job No: 89 006	Sheet No:
Sult	ling Engineers	Part of Structure:	By:	Date:
Member Ref:		CALCUL AT IONS		<u>OUTPUT</u>
	FROM DE STENDER TO SELECTION TO	= d kn/m2.	Po con	Σ Ψ Ο.

.

	ASSOCIATES ing Engineers	Part of Structure	LE HOURS	30b No: 80 006 8y:	Sheet No: 3. Date:
Member		Beioas	LOW ATIONS	L.	APPL 50.
Ref;		<u>C</u> A	ALCULATIONS	·	OUTPUT
	LOSDING: STIMATE DOOR HORS		· · · - ·		
		, ,	buinal Degici	1.	
	SWTCONG 1.	15 1.2 .15 1.75	12.96 W/m 17.90 3.60 W/m 7.25	o realm?	
	HA. (va.)	.10 1.50	8.33 WW 13.75	s kyllu?	
	HA (KEL). 1	.10 1.100	38.3 WHU 55.0	o kallua.	
	HB	1.10 1.30	450 KN/1845 640	L RY/AME.	
	to party	1.10 1.50		6 will.	


	1000014750	Contract:	Jab Na:	Sheet No:
	ASSOCIATES .	SPEINGHALT HOUSINGH.	800	4.
ensult	ing Engineers	Part of Structure; - Baiout .	8¥: U√.	Date: ARÁU 90
Member Ref:		CALCULATIONS		OUTPUT
	DEPOIGH CHE	IOC FOR TI BRIDATO BEAUL.		
	+ 1	HECTION PROFESTIFIO!		
	380	7+ = 5.18×106 mm3		
	+	Zb = 8.89 x 10b um ³		
		Sut = 2.31 kNm.	•	
<u> </u> 	KERNUE G	Tabbo:		
	but Beau.	. P.31 xx/m.	•	
	и.	= 0.31×7.58/8 = 16:05 Wm.		
	NETU SUT.	= 195x5100-9800 = 1.06 vall.		
	М	= 4.06×7.62/8= 28.57 KH	J .	
	Socracing:	= 1.12 × 3.6×7.6°/8=30.38×N	huda	
	Haved =	$1.2 \times 8.33 \times 7.5^{9} = 70.28 \text{ cm}$ $m = 70.28 \times \frac{8}{1/2} = 35.14 \text{ cm}$	، مب	
	HA VIEL =	1.0 × 33.3×7.5 = 75 KM	•	
	Pte 1	3EDW = 75× 1/2 = 37.5×Nu.		
	}			1


.

CAREW ASSOCIATES	Contract: LAPOININATE HOUSING	99 (006	Sheet No:
Consulting Engineers	Part of Structure:	<u>8</u> ¥; ∪℃.	Date: APOL 90
Member Ref:	CALCULATIONS		OUTPUT
STREBETS INJITIAL: b.WT: WET CON	$f_{b} = \frac{1}{7} = \frac{16.75}{5.18} = 3.14$ $f_{b} = \frac{1}{7} = \frac{16.75}{8.89} = -1.8$ $f_{b} = \frac{28.57}{5.18} = 5.5$ $f_{b} = \frac{28.57}{5.18} = -3.6$ $f_{b} = \frac{28.57}{5.18} = -3.6$ $f_{c} = \frac{28.57}{5.18} = -3.6$ $f_{c} = \frac{24.3}{5}$	3 Hlum? 21 Hlum? 20 Hlum? 1.00 Hlum? 2.99 Hlum?	1.7.79

	ASSOCIATES	Contract: BPANGNAUE + ESTAWA.	Job No: 89 006	Sheet No:
o nsulti	ng Engineers	Part of Structure: BUIDEF	8 <u>v:</u> U	Date: NOZIU 90.
<u>Member</u> Ref:		<u>CALCUL ATIONS</u>	•	OUTPUT
Member	FEWINGOIBLE FLEXURAL (1) (2) TELLINA THAL 1.83 ALLOW FEWINGOIBLE 1.83 ALLOW FOR 1.80 FEWINGOIBLE 1.80 FEWINGOIBLE	EDIVITE CALCULATIONS CALCULATIONS COMPRESSIONAL. CAMPRESSIONAL. CAMPRESSIO	1/www.	OUTPUT OUTPUT
	98	P = 0.672×106 N (672×N) 2 = 67.9 mm. = 140-67.9 = 70.1 mm)	-

CAREW ASSOCIATES Seculting Engineers		Contract: GRENWALE HOSAIG.	100 NO: 89(006	Sheet No:
		Part of Structure:	<u>8y:</u> ∪√.	Date: XPÁU SO '
<u>Member</u> Ref:		CALCULATIONS	•	<u>OUTPUT</u>
H.G.I.	LE TO THE OF THE STAND CALCULATED TO THE OF	FELLOWSO: STRANDOS. = 165 N/mm. [70] ALLOWER = 0.7×165 = 115.5 KN. ATRINOS = 670/6 = 112 KN. HE ECCENTRICTY TOTO NOT CO EXHOLOGY AD XPRANTEUCTY. + 89 × 6 = 67 Y = 80.67. EN 1000 = 140-80.67 = 57 P = 0.690 × 10° = 690 D = 5.97 ie 6 N° ST OK. OK. OSTRAND = 690 = 116 KN.	LE STEADS.	

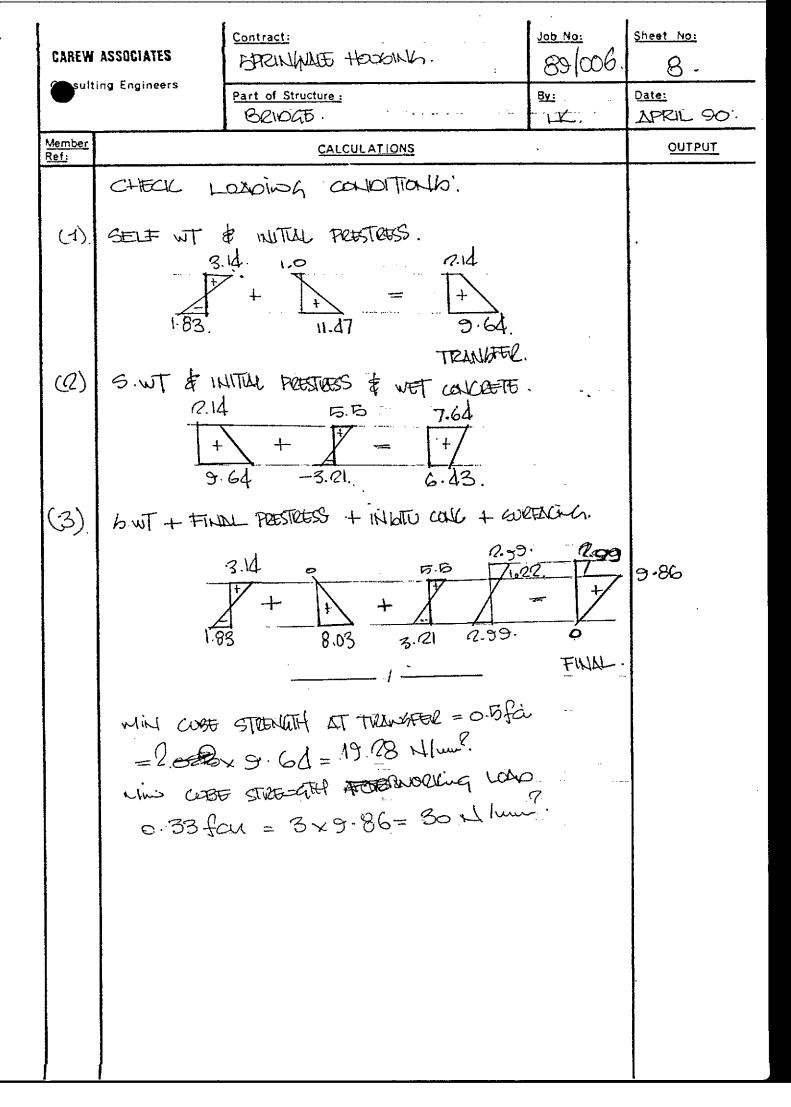

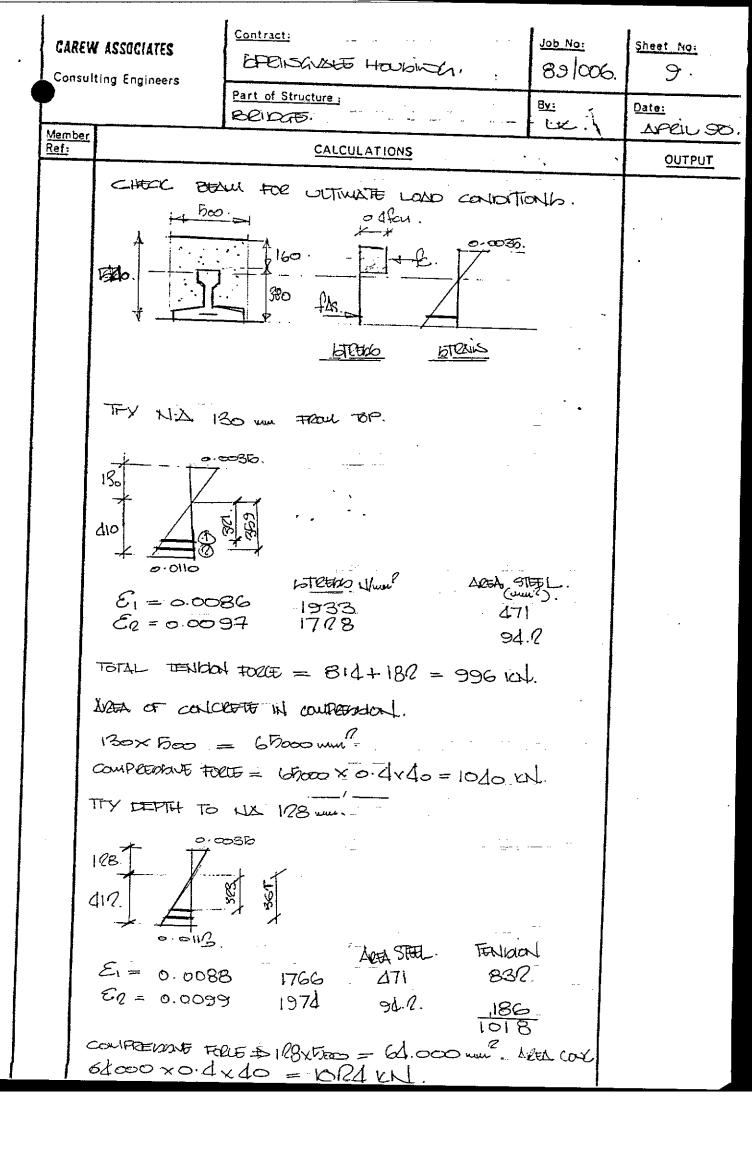

	ASSOCIATES	Contract: BPEINWARD HOURING.,	100 No: 87 006	Sheet No:
Consult	ing Engineers	Part of Structure:	By:	Oate: ARAU 90
Member Ref:		CALCULATIONS		<u> </u>
Member Ref:	361 331 1-0 8 2-0 1 3-0 10	CALCULATIONS ENTR ABOUT NIA FOR BATE ARM. MONEYT. 337. 0.323 = 768.7 86 0.361 67.1 0.058 59.0 TOTAL = 395 KAN OUTST OF REDWINDLEST.		

•

f			1	Sheet No:
. CAREW ASSOCIATES		Contract:	Job No: 89/006	11
Caulti	ing Engineers	BARINGULT HOUBING. Part of Structure:	By:	Date:
		ABJIMEN.	UK.	LIXY 90.
Member Ref:		CALCULATIONS	<u>.</u>	<u>OUTPUT</u>
	CHECK NOT	LENT FER OVERTORING!		
		1.0.50		
	o.Tix	1 0.55. Jan.		
	Î.	7 0.56. Jan.		
	, k	, 3. Mo x	~-	
	DEGKN LOW	ven:		
	HI WRCHARGE	= 10 kg/m².		,
		= 30 KN/W WITH OF ABJUST.	' *	
	EARTH PREUM			
	Yeoic = 18	3 collus.		
	Ya = 4	o.A. ,	_	
	DECK:	·		
	hwt = 0	68× 24 = 16.56 xx/lm?		
	• • • • • • • • • • • • • • • • • • •	м.	·	
	: LOND = 10	.06x7/1= 08 W/m.		
	1.25 BRAVENG.	WECK & 1.0.		And principal pr
	1.5 WOLLHARDE	9 5 400 6016.	· .	
	7.	1.5 x Fiu.		
	ACTIVE PRESHU	vit soil		
		19h? = 12x0.07x18x4? = 39xx		
	PORCHACT	4	'	
	+= 10x	4 = do w.		
	ULTIMATE U	WIT LOADS!		
		a moutate 2)	WH.	
	ACTIVE PREC	160E = 39×1.90 × 1.95/3= -	88.73	
	brecharge		136.50	
	BRAKEG	$= 30 \times 1.00 \times 4.50 = -$	309.86.	
			J.4.00.	
í	1			

		Contract:	_	Job No:	Sheet No:
•	ASSOCIATES	SPRINGIALE HOUSE	4 ,	89/006	1/2
Coult	ting Engineers	Part of Structure :		8 <u>y:</u> .	Date:
		DECTHANT.		U	- MY 90.
<u>Member</u> Ref:		CALCULAT	IONS	t ′	QUTPUT
	RESTORING MO	MENTO.			
	LITEM = 0	V5 24 × 4 × 1.00	0x1.0=5d10		
		155 14 × 3.75 × 3.			
		15x 18 x 4 x 25			
	} '	18× @ 1.025 x 1.6	_	*	
		40× 1.0 × 1.1			
			752.7		
	FOD AGAINST ON	15001-4 = 750.7	9	` `	
		395	86 = 1.30.		
	· FON LOTEG	• •	·	_	
	(F TACK 47+	HX LAVE LOADING THE	VOOR WHI COULY).	
		~			
	EARTH PRE	bhuetes:		÷	
	1.0 824	11.0 Hz sue.			
土	110H4 < > H	1.0 htm1.0 but.			
		14.0 FILL 1.0 AGI	ਜੋ ⋅		
		TIO BICE.			
	Nochpath	=			
	1. VERTICAL FO	ecth.			
	1	×0.50x24×4	- 50.80.		
	B .	1 0.05x 2dx3.75			
	FIL = 1.	0x 2595x 18x4	= 181.80.		
	DECK = 1.		= 58.00.		
	H4502 = 1.	•	= 40.00.		
		1	382.10 KN.		
	of although.	50 女.			
		D×39×456/3	=-59.15		
	EVECHALITE = 1.				
	Hi thing = 1	.0×30 ×4.70 1.0×50.80×0.85	=-136.50	TOTAL= 236	
	BUSE =	TA SAUN OTA	= 000	• • • • • • • • • • • • • • • • • • • •	
	1	1.0×181.8×0.65	ニナルといん	•	
	I.Fill =	1.0×101.8×0.60	ニナルといん		

CAREW	ASSOCIATES	contract:	100 No:	Sheet No:
sulti	ng Engineers	Part of Structure:	By: UK-	Date:
Member Ref:		CALCULATIONS	` .	OUTPUT
	= 101.9 = 202.1	$ \frac{\pm 236}{3.707} \times 6. $ $ \pm 100.7. $ $ 6 02 0.7. $ $ = 200 \text{ N/u}. $		
	如好日	ENUTS THE MUTSTHATE WE ASSOCIATE ON INVESTIGATIONS		
			·	

CAREW ASSOCIATES Sulting Engineers		Contract:	÷	89/006 100 NO:	Sheet No:
		Part of Structure:		By:	Date:
Member		CALCULATIONS			OUTPUT
Ref:	b-av.l -		*****		
		TOOL JOHOTHO.			
	LOSSOM-GIS:	Boarding; pustferboard & b.wt Joutl	b =	6.55	
	-Tupos#D	· · · ·		1.50	
	Joistb AT.	300 cebi.		7.05)	
	Allow = 0.0	003L=0.003x Floo = 15.3.		••	
	mon mon 1	HUTH OF 15 mm.			
	= 150x224 J	5× 1.05×0.3× 50004 384× 8000 × 15 45.16×106 mmd.		-	
	I= vox	2253/2= 27.46×106 m. 4.			ŕ
	INTERNATH:	,		_	
	LOAD/m em	JONOT:	-		
	•	x0.3=0.615.			
	3	$0.615 \times 5.1^{2} = 0.00 \text{ kNm.}$ $= \frac{0 \times 10^{6}}{40.19 \times 10^{4}}$ $= 4.74 \text{ N/m}^{2}.$	<u> </u>	205° 40.00	11 3 . 3.
	GRAPE SCE Vunahu		3F) J	·lu [?]	
	· , , , , , , , , , , , , , , , , , , ,	VIOX 2/27) JOHNTO AT 300 CO GRADE SCB TIMBER.	1 60		

Gonsulti Member	ASSUCIATES ng Engineers	Contract: Plumble House Part of Structure: FLOOR TOWNS. CALCULATIONS	100 No: 89/006 By: UK.	Sheet No: IV). Date: WM 90.
Ref:	Lahoing! DEAO PACTITION 10 FLOOR DEFUTCTION	1.615 EVILLE 37 m. 384 V 8000 × AF: 46×106 TO VILLE TO VILLE BY TOWN TO VILLE	Jouot.	

CAREW ASSOCIATES Consulting Engineers		Contract: howhat Hooking Part of Structure: + contraction 100.		Job No: 89/006 By:	Sheet No: 16. Date: WAY 90:
Member Ref:	CALCULATIONS				OUTPUT
	LODDING DEAD: ROOF HOOR MAJOHRY: 100 HOUD BLOCK	& FWHH	= 1.00 KN - 0.55 KN = 12.76 KN	lue?	
	100 Bleck		= 2.40 m	lui.	
	Imposed.				
	200F		= 0.75 KM = 1.50 KM	1-2	
	Flool.	2.45 7.45.	= 1.00 EN		
	Lohois:	To.80.			
(OEC)	1				
(2.544)	FLEOR = (2	2.1 (1.75) = - 2.56 (2.06) =	5.23 Wh.		
	wholey_ [5.7(5.16) =	29.41 ENlw. 39.10 ENlw	lins.	

7 ₄

CAREW ASSOCIATES CONSULTING ENGINEERS

22 CROFTON ROAD, DUN LAOGHAIRE, CO. DUBLIN.

TELEPHONE: (01) 809827

FAX: (01) 809944

PROPOSED HOUSING DEVELOPMENT

 \underline{AT}

SPRINGVALE, BALLYBODEN.

BLOCKWORK SPECIFICATION NOTES.

26 MAR 1991

AND LIFE

ARCHITECT.
GERALD CANTAN,
OWENSTOWN HOUSE,
FOSTERS AVENUE,
BLACKROCK.

BLOCKWORK.

1. GENERAL.

All blockwork shall be in accordance with the requirements of I.S.325: Part 1(The Structural Use of Unreinforced Masonry.)

MATERIALS & PROPERTIES.

2.1. CONCRETE BLOCKS.

All blocks shall be dense aggregate solid blocks of density not less than 1650kg/m³ & shall comply with the requirements of I.S. 20 :Part 1 1987 :(Concrete Building Blocks.), I.S. 325 : Part 1 1986 Structural Use of Unreinforced Masonry.) Blocks to have a co-ordinating size of 450mm x 225mm to suit various wall thicknesses. They shall be true to size with clean, sharp arrises. The drying shrinkage of the blocks shall not exceed 0.05%. Blocks to have a compressive strength, when tested on edge, as specified on Engineers drawings. A manufacturer's certificate of the quality of the blocks shall be produced for all batches delivered to site.

2.2. CEMENT.

Cement used shall be Ordinary Portland Cement to comply with requirements of I.S. 1: 1987(Portland Cement.)

2.3. LIME.

Lime used to be hydrated lime in accordance with the requirements of I.S. 8: 1973 (Hydrated Lime for Building Purposes.) or semi-hydraulic or non-hydraulic, class 'B', calcium lime to B.S.890(Building Lime.) Lime shall be premixed in the required proportion with sand & allowed to stand for 16 hours before use.

2.4. SAND FOR MORTAR.

Sand used in the preparation of mortar shall be clean, washed, sharp river or pit sand, free from deleterious matter. Sand shall comply with the requirements of B.S.1200(Sands for mortar for plain & unreinforced blockwork, block walling & masonry.)

2.5. <u>WATER</u>.

Water shall be free from impurities harmful to the mortar. Where the quality of supply is doubtful the water shall be tested in accordance with BS3148(Tests for water for making concrete.)

3. MIXING OF MORTARS.

All materials shall be accurately gauged by gauge boxes & throughly mixed. Re-tempering of mortar will not be permitted. The proportions of mortar mixes shall be nine parts sand & two parts lime to one part cement by volume, unless otherwise stated on the Structural Engineers' drawings. The lime & sand shall first be mixed & gauged immediately before use with the cement. The lime & sand may with the approval of the Architect be mixed in batches of a reasonable size & stored, provided it is not allowed to dry out. Cement Mortar shall be composed of three parts sand to one part cement by volume. Mortars containing cement shall be used within two hours of the addition of the cement. Ready mixed mortar obtained from an approved supplier shall be in accordance with B.S. 4721. Mortar for facework shall be coloured ready-mixed to suit the shade of the brickwork. If colouring agents are to be used, these shall comply with the requirements of B.S. 1014. Pigments shall not exceed 10% by mix of the cement in the mortar. All such pigments shall be used in strict accordance with the manufacturers' instructions.

4. DELIVERY & STORAGE OF MATERIALS.

- 4.1. Blocks shall be carefully transported, unloaded & stacked on a strong, reasonably laid, level surface clear of any material which might be likely to stain or damage the blocks. Blocks shall not be stored in contact with the ground, but shall be placed on a surface formed of clean planks or other approved surface which is not likely to become saturated. Alternatively, blocks shall be delivered & stored on timber pallets & protected with polythene coverings arranged to throw off water or melting snow while at the same time allowing air to circulate freely between the blocks.
- 4.2. Cements & limes shall be stored off the ground, under cover & away from the damp & in such a manner to enable them to be used in rotation in order of delivery. Sands shall be stored seperately according to to type, on clean, hard, drystanding & protected from contamination. Sands for pointing shall be stored seperately, away from all other sands & shall be obtained in sufficient quantity at one time to enable material of the approved colour to be used for the whole of the work.

5. WALL TIES.

5.1. Wall ties shall comply with B.S. 1243: 1964(Metal ties for cavity wall construction), stainless steel vertical twist type. The length of ties shall be 100mm greater than the width of the cavity for which they are to be used. Wall ties shall be placed at 900mm centres horizontally & 450mm centres vertically & staggered. Attitional ties shall be provided to jambs at openings every 225mm & at reinforced concrete columns & walls. The wall ties at concrete skins shall be slotted into stainless steel dovetail slots cast monolithically with the concrete. Ties in insulated cavity walls to be stainless steel combined, twist strip wall tie/board clip at 450mm vertical & 900mm horizontal staggered general spacings, unless stated otherwise on Engineer's structural drawings, to suit insulation board.

5.2. DOVETAIL MASONRY SLOTS & ANCHORS.

Masonry slots to be 18 gauge stainless steel cut to lengths & fixed to inside face of formwork before pouring concrete. Dovetail anchors to be 3mm thick stainless steel vertical twist & split, provided at 450mm vertical centres or as directed by the Engineer.

5.3. BED-JONT REINFORCEMENT.

Specialist bed-joint reinforcing to be used as specified on Engineer's drawings. Reinforcement to have an effective cover of not less than 20mm & shall be continuous except at control joints, or where otherwise indicated.

6. WORKMANSHIP.

6.1. LAYING BLOCKS.

All blockwork shall be set out & built to the respective dimensions, thickness & heights shown upon the drawings.

The blockwork shall be laid in accordance with C.P. 121: Part 1. Blocks to be fully bedded & the vertical joints completely filled to ensure a waterproof wall.

Blockwork shall be carried up in a uniform manner, no one portion being raised more than 1200mm above another at one time. All perpends, quoins, etc., shall be kept strictly true & square & the whole properly bonded together & levelled round at each floor.

6.2. LAYING BRICKS.

Bricks for laying should be random picked from a number of pallets to scatter possible shade veriations & a sufficient stock of bricks should be kept on site to permit blending bricks from different deliveries. Bricks should not be wetted before laying but the flosticity of the mortar should be adjusted to suit the bricks during dry & warm weather conditions. Bricks shall be fully bedded & the vertical joints completely filled to ensure a waterproofed wall. Before the mortar sets the joints shall be carefully dressed with a 12mm round steel bar. All joints shall be of uniform thickness throughout. Mortar chaffings on the face of the brickwork should be avoided & if it occurs the mortar should be removed immediatly with the edge of a trowel & the residue lightly wire-brushed when dry. Consistency in the mortar mix is essential to avoid variation in the finished appearance of the facework.

6.3. BOND.

The blockwork shall be laid in stretcher bond unless otherwise noted on the Engineer's drawings. Vertical & horizontal joints shall be 10mm wide.

7. WALLING.

Walls & partitions to be to the thickness & heights as shown in the Drawings; built to an approved bond & all work well bonded together. Perform all cutting, toothing for bonding as may be required & set & joint all blockwork in lime gauged mortar as described.

Cavity wall shall be of the various thicknesses shown. The leafs of the cavity walls shall be tied together with approved ties three per square metre with additional ties where required at openings. All cavity walls shall be tied together with approved ties three per square metre with additional ties where required at openings. All cavity walls to be carefully executed in accordance with good building practice & the level of courses in adjacent leaves to be strictly maintained throughout construction.

8. DAMP-PROOF COURSE.

Sheet damp-proof courses shall be approved P.V.C. in accordance with I.S. 57. Damp-proof courses shall be laid with 150mm minimum laps in running lengths, passings & junctions, & shall be sealed where the damp-proof course is used to form cavity flashings.

Damp-proof courses shall be laid on a level bed formed at the required heights for the full width & length of all walls & partitions & quired in mortar. Damp-proof courses under sills to be similar well solutioned to underside, back & ends of sills before fixing.

Damp-proof courses under all floors to be 1,000 gauge polythene sheeting with welded joints; 100mm minimum width, at sides & ends. Sheeting to be carried up face of walls at abutments & lapped 50mm minimum over horizontal damp course on rising walls.

9. CAVITIES.

The wall cavity to be 50mm wide minimum using ties as described. The cavity should be clear of mortar droppings by means of battens drawn up as the work proceeds, leaving weep holes over cavity gutters as directed & cleaning out the cavity on completion by means of holes left at the base & filling holes & making good on completion.

10. INCLEMENT WEATHER / FROST.

No blockwork shall be carried out during rain, frost or snow. During inclement weather & overnight the work shall be protected & covered with felt or polythene. In cold weather the mortar shall be protected from freezing before it has set & for a few days afterwards. If work continues during cold weather the work shall be protected from freezing during the first week by covering the top with sacks of straw. None of the material shall be at a temperature below freezing point & the sand & lime shall be free from ice. The use of proprietry anti-freeze admixtures in the mortar may permit the work to be continued under frosty conditions subject to approval. All additives must be used strictly in accordance with the manufacturer's instructions & should be approved before use. Any blockwork damaged by frost shall be taken down & made good at the contractor's expense.

11. KEEPING THE WORK CLEAN.

Mortar boards should have two adjacent vertical sides about 150mm high; one of which should face the wall being built to minimise splashing. Scaffolding planks should be kept at least 225mm from the face of the blockwork & should be turned back at night & in rain to prevent splashing. Tops of all walls should be protected with felt or polythene on completion of the days work & during inclement weather.

Where cast in-situ concrete or plaster work has to be executed adjacent to facework; it is imperative that the blockwork should be covered down with felt or polythene as it is impossible to clean concrete facing blocks without damaging the surface or colour. Any facework damaged by want of sufficient protection shall be removed & made good at the Contractor's expense.

12. PLASTERED FINISHES.

Where the walls require to be plastered & the surface of the blocks is too smooth to provide a key, the joints shall be made flush as the work proceeds & subsequently raked out after the mortar has set to form a key for the plaster. When the wall face is not required to be plastered the joints shall be given a tool finish as required by the Architect. Unless otherwise specified the tooling shall be done with a 12mm diameter round tool before the mortar hardens, but not before it has begun to set.

13. JOINT SEALANTS.

Sealing compounds to exposed edges of control & expansion joints __ shall be approved polysulphide liquid polymer sealant. The sealant shall be applied in strict accordance with the manufacturers instructions & neatly tooled to joints from a pressure gun. Note that expansion joints shall be cleaned out to insure that mortar does not bridge the joint.

CAREW ASSOCIATES CONSULTING ENGINEERS

22 CROFTON ROAD, DUN LAOGHAIRE, CO. DUBLIN. TELEPHONE: (01) 809827

_FAX: (01) 809944

PROPOSED HOUSING DEVELOPMENT

<u>AT</u>

SPRINGVALE, BALLYBODEN.

CONCRETE SPECIFICATION NOTES.

DUBLIN EQUATY COUNCIL Franching Capit Assultation Saturbill APPARENTE TO THE TREET

26 MAR 1991 914/0446

ARCHITECT. GERALD CANTAN, OWENSTOWN HOUSE, FOSTERS AVENUE, BLACKROCK.

CONCRETE WORK:

Workmanship:

The materials, labour and workmanship in and connected with the execution of the reinforced concrete work shall be the best of their kinds without regard to any trade terms and the Contractor, employ a duly qualified Foreman, experienced in reinforced concrete construction, to supervise the work. The quality of materials and the standard of workmanship for the reinforced concrete shall comply with the relevant clauses of B.S. Codes of Practice 110, 115 and 2007 in regard to all requirements not otherwise described herein.

Cement:

The cement used on this Contract shall be manufactured in Ireland, and shall be normal Portland or Rapid Hardening to comply with the current Irish Standard 1. The cement shall be delivered in standard bags and stored under dry conditions in a shed of approved construction. Alternatively, cement may be delivered in bulk in a tanker and stored in a silo of approved design. Cements of different qualities shall be stored and used separately.

The Contractor shall obtain a test certificate from the manufacturer with each consignment giving the result and date of the tests.

Cement damaged in storage or handling shall not be used and shall be removed off the site. The cement on the site shall be re-tested from time to time as directed. Cement failing to pass the test shall be removed from the site.

Water:

The mixing water shall be of potable quality obtained from an approved source.

Aggregate:

The aggregate for concrete shall consist of naturally occurring material complying in all respects with B.S. 882, 1201, and T.S. No. 5 (Note: the use of 'all-in' aggregates shall not be permitted). All aggregates shall be free from laminated, and/or flaky particles, dust, silt, clay and other impurities.

The fine aggregate shall be a natural pit or river sand passing a 5mm screen and shall be thoroughly washed in a mechanical washing plant. It shall be graded from the largest to the smallest particle sizes in approved proportion.

The coarse aggregate shall be retained on a 5mm screen and shall be composed of clean washed gravel or crushed stone, or a combination of both, of approved quality and grading, free from laminated and flaky particles, dust and other impurities.

(Continued Over/...)

CONCRETE WORK (Continued):

Aggregate (Continued):

Aggregates having the following defects are specifically excluded:

- a. Fine aggregate containing organic material in excess of the standard tolerance.
- b. Fine aggregate containing silt or other material removable by decantation in excess of five per cent by weight.
- c. Fine or coarse aggregate containing particles coated with clay or clay lumps exceeding one per cent by weight.

The fine aggregate and the various kinds of coarse aggregate listed in the table below shall be delivered to the site separately and shall be stock piled separately with suitable divisions between adjacent stock-piles on clean impermeable concrete, macadam or other approved surface.

The following table gives the approximate grading to which the aggregates should conform:

	Nominal Size of Aggregate			
Sieve	38	19	13	Fine Aggregate
	Percentage passing each Sieve _			
38 19 13 10 5 No. 25 No. 100	100 0-5 - 0.5	100 - 20-50 0-10	100 40-85 0-10	100 90–100 30–55 0–5

Preliminary Tests:

Before concreting operations are commenced, samples of the aggregates shall be submitted for approval. The mass of the samples shall be about 15kg for each size of coarse aggregate and 5 kg for the fine aggregate.

The quality of all materials delivered to the site shall be equal or superior to that of the samples.

Control:

The grading and proportion of the aggregates shall be controlled on the site by means of routing sieve analyses and the Contractor shall keep on the site a set of standard sieves together with a direct reading weighing scales of approved design.

Trial Mixes:

Before commencing concreting work, the Contractor shall prepare batches of the various mixes as determined from the sieve analyses and from such batches shall prepare 150mm test cubes. The proportions of the aggregates for each mix shall be determined by the workability of the trial mixes and the test results thereof. The cubes shall be made in properly machined steel or cast-iron moulds, and the Contractor shall provide such moulds as required to maintain a testing programme in accordance with the CL. 6.8.2.2 of C.P. 110.

Test Cubes:

During progress of the concreting work, the strength of the concrete shall be verified by means of compressive tests carried out in 150mm cubes. An average of two cubes shall be made per 20 cubic metres of concrete placed per day or as may be instructed by the Engineer. The cubes shall be made under the supervision of the Clerk of Works and stored in the manner set out in the Code of Practice 110.

The samples of concrete for the test cubes shall be obtained at the place of deposition when the concrete is being placed in position. The test cubes shall be marked clearly with a serial and job number, together with a note stating the date of casting, the mix and the place of deposition of the corresponding concrete.

The expenditure as certified by the Architect on test cubes will be refunded to the Contractor. The Contractor shall keep daily progress charts and other records setting out the position and the amount of concrete placed each day.

Gauging:

The cement and aggregate shall be gauged by weight and the Contractor shall provide mechanical weight batching plant with direct reading dial gauge weighing apparatus, all of approved capacity and design.

Consistency:

The proportion of mixing water for the various parts of the work shall be adjusted to the satisfaction of the Engineer to ensure that the proportion of water shall not be greater than that required to obtain a fully compacted dense concrete, free from laitance and excess water. The Contractor shall carry out from time to time such tests as may be necessary to ascertain the proportion of water required to obtain consistency in the various mixes. Consistometers of the vibrating type and of approved design shall be used for controlling the workability of the concrete.

Mixing:

The concrete shall be mixed in power driven batch mixers of approved size and design and having a capacity of not less than that required for a one 'Bag' batch. Mixers with damaged or work blades shall not be used. The interior of the mixers shall be maintained in a clean condition and shall be thoroughly washed out at least once daily. Mixers shall be operated at the speed recommended by the makers.

An approved device shall be provided for adjusting and controlling the exact quantity of water in each mix. When commencing work with a clean mixer, the proportions of coarse aggregate in the initial batches shall ber educed until the blades have packed up the normal proportion of fine material. A mixing time of not less than two minutes shall be allowed after all materials and water have been placed in the drum.

Ready-Mixed Concrete:

Ready-mixed concrete may be used subject to the Engineers prior approval. The transport containers shall be such as to ensure continuous agitation of the concrete until deposited on site.

Preliminary trial mix requirements may at the discretion of the Engineer be waived. In every respect the concrete manufacturer, transport, agitation and period of time between manufacture and delivery to final position shall conform with B.S. 1926. Ready-mixed concrete shall otherwise comply with the requirements of this specification.

Mixes:

The following table sets out the approximate proportion of each mix for the guidance of the Contractor. The cement content of each mix may be reduced or increased at the Contractor's descretion provided that he can satisfy the Engineer that the minimum cube strength and required workability and surface finish shall be consistently obtained with the mix he proposes to adopt.

Mix	Minimum Cement Content	Maximum Aggregate size	Characteristic Cube Strength at 28 ₂ days N/mm ²
A	150	20	10
В.	300	20	20 -
С	370	20	30 =
	·		

Continued Over/...

Mixes (Continued):

Except where otherwise described in the Bills of Quantities or the Engineers' structural drawings, concrete mixes for various sections of the work shall be as follows:

Mix A: Sewer beds, haunching and casing to sewers and water mains and as elsewhere specified.

Mix B: Foundations, reinforced concrete walls, manholes, gully chambers and slabs where the thickness is 225mm or more.

Mix C: Foundations, reinforced concrete beams and columns, and slabs having a thickness less than 225mm; infilling and manufactured precast concrete floor and roof units.

The approval of aggregates, grading, water content, etc. shall not relieve the Contractor of responsibility in regard to the strength and finish of the concrete, and the Contractor shall remove and reconstruct at his own expense, any part of the work which the Architect and Engineer deem to be below standard.

Concrete Binding:

The surface of the ground or hardcore under foundations, and under other concrete in contact with the ground or with hardcore shall be sealed with a layer of concrete Mix A average 50mm thick.

Transporting and Placing Concrete:

The concrete shall be transported from the mixer to the place of deposition as rapidly as possible and due precaution shall be taken to prevent segregation. The concrete shall be evenly placed in it's final position and shall not be worked or allowed to flow in horizontal direction. As far as possible all concrete in one unit of construction shall be placed in one continuous operation.

No concrete shall be dropped into moulds in such a manner as to cause segregation of the larger aggregate from the mass, such concrete shall be forthwith removed from the mass and wheeled to spoil. The concrete shall be placed in it's final position before setting has commenced, and shall not subsequently be disturbed. Concrete shall be thoroughly compacted and worked by means of immersion vibrators of approved design in order to produce a dense uniform concrete free from segregation, honeycombing and surface defects. The number and method of use of the vibrators shall be such as to ensure uniform compaction. The heads of the vibrators shall be sufficiently small to pass freely between the reinforcing bars. Approved hand compaction tools shall be used where necessary in conjunction with the vibrators. Vibrating tables and surface vibrators of approved design shall be used to compact the concrete in precast concrete slabs and other precast members and units. Surface vibrators of approved design shall be used to compact in-situ ground floor slabs, road slabs and pavement slabs and immersion vibrators shall be used in conjunction with the surface vibrators where directed. Where non-vibrated concrete is specified, e.g. Mix A approved hand compaction tools shall be used unless otherwise directed.

Jointing New Concrete:

Before depositing concrete against any temporarily stopped work or at approved joints, the procedure shall be as follows:

Bonding to concrete of any age: between 2 to 4 hours after casting, wet the surface of the completed work with a fine spray (not a jet) and at the same time brush the surface gently with a soft brush and thus remove the cement film from superficial coarse aggregate without dislodging any of the aggregate or smaller particles between the coarse aggregate. The surface thus prepared shall be coated lightly with neat grout immediately before any subsequent concrete is cast and care should be taken that the first or second batch out of a clean mixer are not used against existing work.

In the event of the above procedure not being carried out, the following procedures may be adopted:

- a). Bonding to concrete which is not more than 4 hours in position; strike off the surface layer including laitance and immediately pour concrete.
- b);. Bonding to concrete which has been in position more than 4 hours but not longer than 3 days; remove laitance as in (a), brush with a steel brush and thoroughly wash with clean water. The concrete must not be hacked unless very hard. Plaster the face of the concrete with a layer of mortar 13mm thick as herein after specified. Immediately pour concrete and thoroughly work same towards mortar grout.
- c). Bonding to concrete which is more than 3 days in position; chip away the hardened surface, brush and thoroughly wash with clean water to remove all loose particles. Brush a neat cement slurry of thick creamy consistency over the concrete and work well in. Plaster the face of the concrete (over the slurry) with a layer of mortar 13mm thick and immediately pour the concrete and work in as before.

Note:

The mortar shall contain the same, proportion of cement and sand as used in corresponding concrete mix. Forms shall be re-tightened in all cases before concrete is poured.

Construction Joints:

All vertical construction joints shall be formed with well braced timber stop ends holed or slotted where necessary to allow the reinforcement to pass through the joints. The concrete shall be compacted against the stop end for the full height of the lift.

All construction joints shall be located in such positions as shall be approved by the Engineer. The vertical joints shall be stepped and staggered in approved positions and such joints shall not be located at or adjacent to quoins. The joints in floors shall be located in such positions as will minimise the number of joints required. In beams and suspended slabs an approved splayed joint shall be provided. In all other cases a tongued and grooved key shall be formed at horizontal and vertical joints. The width of the groove shall be about one third the thickness of the concrete and shall be formed with prepared timber battens having slightly splayed edges.

Additional reinforcement shall be provided at joints where so directed by the Engineer.

Shrinkage Gaps:

The work shall be carried out in such a manner as the Engineer shall direct to minimise the shrinkage of the concrete and shrinkage gaps shall be left at the discretion of the Engineer.

Concreting in Cold Weather:

All concreting work shall be entirely suspended when the temperature in the shade is below 2°C, and the concrete shall not be mixed when the temperature is below 4°C.

The Contractor shall provide a maximum and minimum thermometer of approved design for the purpose of measuring the shade temperature of the outside air. The temperature of concrete measured at the surface at the most unfavourable position shall not be less than 5°C at the time of placing. Any batch of concrete whose temperature as measured above falls below 5°C shall be removed from the site.

Subsequent to or during cold weather the water and aggregates used in the mix shall be free from snow, ice and frost. Formwork reinforcement and any other surface against which fresh concrete is to be poured shall be free from snow, ice and frost and have a temperature within 2°C of the temperature of the fresh concrete. Concrete placed in cold weather shall be protected from damage by frost with a covering of suitable insulating material. All concrete damaged by frost or other weather conditions shall be cut out and replaced by fresh concrete at the Contractor's expense.

Concrete in Warm Weather:

During warm weather the Contractor shall ensure that the constituent materials are sufficiently cool to prevent the concrete from stiffening prematurely. The temperature of mixing water shall be less than 60°C.

When placed the concrete shall not have a temperature greater than 32°C. Any batch of concrete whose temperature measured in the most unfavourable position is greater than 32°C shall be removed from the site and replaced by fresh concrete at the Contractor's expense.

Curing:

Horizontal and vertical slabs and other large areas of concrete shall be prevented from drying out for at least seven days after the concrete has been placed. Precautions shall be taken during the initial period of at least 7 days, to protect all reinforced work from exposure to sun, wind or rain.

Preparation for Plastering:

Where a rendered or plastered finish is specified, the concrete surfaces shall be treated to provide an adequate key.

Alternatively, the formwork may be coated with an approved retarding compound, which shall be removed with water and wire brushed as soon as possible after concreting. Precautions shall be taken to ensure that the retarding compound does not come in contact with the reinforcement.

Traffic over Concrete:

No traffic or temporary load of any kind will be allowed over any concrete until the following minimum times after casting unless approved protective methods are adopted to the satisfaction of the Engineer:

1.	Foundations, ground floor slabs and other concrete in contact with the ground 28 days
2.	Columns 10 days
3.	Suspended Slabs 10 days
4.	Suspended Beams

These times are given for quidance only and do not relieve the Contractor of any responsibility for protecting the concrete work against damage from any cause whatsoever.

Protection of Concrete Foundations:

Reinforced concrete foundations, in general, shall not require formwork, the concrete being cast against the sides of the excavations. The Contractor shall ensure that the footing be kept clear of loose materials from the sides of the excavations. Particular care shall be taken to keep footing clean during the operation of fixing reinforcement and pouring concrete.

Horsing:

The Contractor shall submit dimensioned drawings of the systems of false work which he proposes to adopt the various sections of the work. This falsework shall be suitable proportioned and braced to withstand the weight of the freshly placed concrete, together with the weight of the workmen and materials.

Where supported on the ground, the sole pieces carrying the vertical supports shall be bedded on a solid base and shall have an area sufficiently large to ensure that there shall be no settlement under full load. Adjustable screws or hardwood folding wedges shall be used for adjusting and striking the vertical supports. All shuttering shall be removed without shock or vibration. Before the shuttering is stripped, the concrete shall be exposed in order to ascertain that the concrete has sufficiently hardened.

Shuttering to vertical surfaces may be removed whenever the concrete will not be damaged by so doing. Shuttering and supports under slabs, beams, girders, arches and structures or parts of structures carrying loads shall not be removed without the approval of the Engineer. The striking of the horsing shall be carried out in an approved sequence of operations so that no undue shock or other damage is caused to the permanent work.

The Contractor shall be responsible for any injury to work and any consequential damage caused or arising from the removal and striking of formwork, centering and supports, and any advice, permission or approval given relative to their removal shall not relieve the Contractor from the responsibility here defined.

Formwork:

All formwork materials shall be in good condition and shall be arranged in a uniform pattern. Minor defects shall be rectified as directed by the Architect. All joints shall be carefully aligned and shall be located as directed by the Engineer. The formwork shall be so braced so that no ties appear in the finished surfaces. Narrow width wrought timber slips shall be provided at all daywork joints to ensure straight line construction joints. The formwork and bracing to the sides of beams and columns shall be sufficiently strong to resist distortion during vibration. The use of internal timber spacers or wire ties will not be permitted. Suitable camber shall be provided in formwork to beams and floors as directed by the Engineer to compensate subsequent deflections. The formwork shall be thoroughly cleaned out before concreting and shall be provided with temporary opes to facilitate the removal of cleanings.

Formwork Generally;

The formwork for surface which are not exposed or which are subsequently to be plastered shall consist of sawn boards or sheet metal closely jointed to prevent loss of grout. The surfaces of the concrete shall be free from excessive honeycombing, voids or lippings.

Formwork Fair Finish:

The formwork for exposed surfaces where the finish is of special importance shall consist of plywood or similar material in large sheets in new condition, having smooth non-ferrous surfaces and close fitting joints tongued and grooved where required. Junctions of the formwork with the completed work shall be carefully sealed in with mastic or foam rubber strip and closely butted to ensure that there is no leakage of water. The surfaces of the concrete shall be entirely free of honeycombing, voids, fins, lippings, projections and virtually free of air holes. Such surfaces shall not be touched up in any way.

Mould Oil and Greases:

All formwork shall be treated with approved mould oil or grease before use and shall be carefully cleaned down and further oiled or greased before re-use.

The type of mould oil or grease and it's method of application to be used for shuttering for exposed surfaces shall be as recommended by the manufacturer for this kind of work and shall be subject to the Architect's approval. The use of specially faced boards or plywood shall not be permitted except with the approval of the Architect.

Additives:

Additives may be used for the following purposes but the amount and type of such additives shall be subject to the approval of the Engineer:

- a. Waterproofing: An approved proprietary waterproofing agent may be used when specified in strict accordance with the manufacturer's instructions.
- b. Damp-Proofing: All approved additives for damp-proofing in work such as concrete rising walls, ducts and ground floor slabs shall be provided where specified and shall be used in proportions and manner recommended by the manufacturer.
- Hardening: Approved hardeners for integral or superficial use shall be provided where specified and used in the proportions and manner recommended by the manufacturer.

(Continued Over).

Additives (Continued):

d. Workability Aids and Accelerators: Approved Additives of these kinds may be used subject to the Engineer's approval of the circumstances and location of the work for which the Contractorproposes to use the additive. All workability aids and accelerations shall be provided at the Contractors expense.

Control of Additives:

All additives shall be mixed into the concrete in such a manner as will ensure to the Engineer's satisfaction that the recommended amount of additive is incorporated and thoroughly mixed in each batch of concrete.

Holes and Chases in Concrete:

Holes, chases and other openings required for the passage ofpipes, conduits, etc. shall be formed by inserting suitable sleeves, cores and sinkings before placing the concrete. The sub-contractors shall be required to furnish full information in regard to the position and size of such opes and chase, and the position ofbolts, clips and other fastenings. The cutting of chases, holes or other openings in the finished work shall not be permitted without the sanction of the Engineer. Such holes and chases shall be made only in approved locations and shall be cut with approved tools.

Reinforcement:

Rolled mild steel bars, cold twisted bars and high tensile fabric reinforcement shall comply with the requirements of British Standards 4449, 4461 and 4483 respectively. The Contractor shall deliver free of charge, samples of the various reinforcements for testing as directed. Any consignment of reinforcement failing to comply with the tests shall be removed from the site. In the measurement of the weight, the net lengths as shown on the drawings and schedules shall be taken in conjunction with the net weight per metre on the nominal diameter or size of the reinforcement.

The sizes and other dimensions of the reinforcement shall be checked against the drawings and site dimensions before the material is ordered. The reinforcement shall be cut, cold bent and hooked to the dimensions shown on the drawings and schedules or to such other dimensions as may be directed.

Alternative Bar Sizes:

No alteration or substitution shall be made in the lengths, sizes or arrangement of the reinforcement without the prior written approval of the Engineer.

Compared to the contract of the property of the last o

Fixing Reinforcement:

Reinforcement shall be provided as indicated on the drawings and maintained in it's correct position by means of suitable clips, soft tying wire or welding, supplied by the Contractor at his own expense. The correct cover shall be maintained by means of suitable metal or plastic spacers or small concrete blocks, concrete washers or purpose made steel stools wired to the reinforcement. Such spacers and stools shall be supplied at the Contractor's expense. The Contractor shall not commence concreting on any section of the work until the formwork and reinforcement has been approved by the Engineer.

Reinforcement in slabs shall be supported at points sufficiently close to ensure that the correct cover is accurately maintained. Each corner bar in beam and column reinforcement shall be similarly supported, at such intervals as will ensure that the correct cover is accurately maintained.

Rough Precast Concrete:

Rough precast concrete shall be composed of Concrete Mix 'D' as described hereinbefore and prices shall include for moulds, packing around reinforcement, hoisting, setting, jointing and pointing.

Faced Precast Concrete:

Faced precast concrete shall be composed of Concrete Mix 'D' as described hereinbefore, finished fine on exposed faces and waterproofed with an approved waterproofing compound. Castings shall have perfect arrises. Prices shall include for moulds, packing around reinforcement, hoisting, setting, jointing and pointing.

Manufactured Precast Structural Units:

The precast structural units shall be supplied by a Specialist in the design, manufacture and erection of precast concrete structural units.

The manufacturer shall be responsible for the design of the precast structural units. The design of the units shall comply with the latest edition (including amendments) of CP 110: 1972 "The Structural Use of Concrete: design, materials and workmanship."

The Architect shall be informed when the units are to be manufactured and shall have access to the manufacturer's work to inspect the unit during and after manufacture.

The manufacturer of the precast units shall include in the design calculations he submits to the Engineer for approval, details of the mix proportions, water cement ratio and characteristic strength for each concrete mix he proposes to use.

The supports provided to the precast units for the purpose of lifting, handling, storage, transport and erection shall in number, type and location be such as will ensure safety and minimise the resulting stresses induced by the units. Packings and other necessary means shall be employed to protect the units from chaffing and discolouration arising from these operations.

All necessary temporary connections and supports to the precast units required to ensure the stability of the structure in the interim between the erection of the units and the completion of the permanent structural connections of the units to be in-situ portion of the structure shall be provided immediately on erection of the units and shall be maintained operative until the permanent connections have reached their full design strengths. The arrangement and design of the temporary connections and supports shall be such that in the event of an accident causing the local collapse of one or more units, the temporary connections and supports to the units not immediately affected will be sufficient to prevent the local collapse becoming progressive. The permanent connections shall be completed as soon as is practicable after the erection of the units.

CAREW ASSOCIATES

CONSULTING ENGINEERS

22 CROFTON ROAD, DUN LAOGHAIRE, CO. DUBLIN.

TELEPHONE: (01) 809827


FAX: (01) 809944

PROPOSED HOUSING DEVELOPMENT

<u>AT</u>

SPRINGVALE, BALLYBODEN.

DRAINAGE SPECIFICATION NOTES.

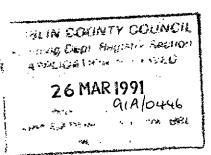

ARCHITECT. GERALD CANTAN, OWENSTOWN HOUSE, FOSTERS AVENUE, BLACKROCK.

SPECIFICATION NOTES

1. Drainage

- 1.1. Concrete pipes shall be spigot and socket type with flexible joints and shall comply with I.S. 6, 1974.
- 1.2. Clayware pipes and fittings shall comply with I.S. 6, 1974.
- 1.3. U P.V.C. drains and fittings shall comply with the requirements of ISO/DIS 4435 1978, BS 4660 and BS 5481 and shall be constructed strictly in accordance with the manufacturer's instructions.
- 1.4. Manhole covers and frames shall comply with I.S. 261, 1984 and shall be Grade A quality in ductile cast iron and with 600 mm clear opening. Covers must incorporate a triangular point suspension without Neoprene sealing ring.
- 1.5. Gratings and frames for unsealed gullies shall be in grey cast iron to I.S. 261, 1984 and shall be dished with slots normal to kerb lines and hinged to close in traffic direction.
- 1.6. All covers, gratings and frames shall have clearly cast marking

"I.S. 261 Grade A

I.S. mark or equivalent


Manufacturer's Name

1.7. Manholes shall have minimum clear internal dimension of 1200 mm square for up to 2.5 m depth. Roof slabs shall be of reinforced concrete 150 mm thick 1.8. to support standard HA loading. 1.9. Base slabs shall be 250 mm thick unreinforced in Grade 30N/40 concrete. 1.10. Roof slab shall be set 550 clear of finished road surface. 1.11. Surface water manholes shall be constructed in Type A solid concrete block 10.5 N/mm² in cement mortar. Beds and vertical joints shall be completely filled with mortar as the blocks are laid and flush pointed. 1.12. Manholes up to 2.5 m depth shall be constructed in 225 mm block: Thereafter in 350 mm thickness as directed. 1.13. Manhole shafts shall have internal dimension 900 mm by width of manhole. 1.14. Galvanised rungs to approved type shall be built in line vertically at 300 mm centres. 1.15. Foul sewer manholes shall be cast insitu concrete 30 N with 225 mm thick walls, fair faced internally. Base slab and roof slab shall be as 1.8, 1.9, 1.10 above. Galvanised rungs shall be provided as Clause 1.14. 1.16. All benchings shall be finished smooth in 1 : 3 cement sand mortar with cross fall of 1: 30. 1.17. Road gully pits shall be constructed in solid blockwork or insitu concrete with clear internal size 450 mm X 380 mm - 2 -

and outlet as described on the drawings.

1.18. Road gully connection shall be in 150 mm spigot and socket concrete pipe with full 100 mm thick concrete bed and surround as described and not exceeding 10 m length. PROPOSED HOUSING AT SPRINGVALE BALLYBODEN, CO. DUBLIN

SPECIFICATION FOR LANDSCAPING AND PLANTING.

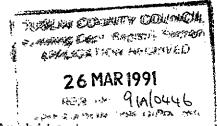

Landscape Architects:

P.C. Roche Associates,
120 St. Lawrences Road,
Clontarf,
Dublin 3

1.0 PREPARATORY OPERATIONS

Such operations are to conform to B.S. 4428 1969 and to Local Authorities requirements.

1.1 Existing Services

It shall be the responsibility of the landscape contractor to satisfy himself as to the location of service runs, in so far as it affects his contract area.

He shall make good, at his own expense, any damage he may cause to such services. The Landscape Architect to be informed immediately if any such damage has occurred.

1.2 Temporary Works

The Landscape Contractor shall provide, maintain and remove on completion of the works, all temporary works necessary for carrying out the contract. To the satisfaction of the Landscape Architect. He shall make them safe and suitable in every respect to carry all plant required for the work and secure adequate protection of the public in their legal use of the adjacent paths, roads, pavements and buildings and comply with the applicable Bye-Laws and regulations of the Local Authority.

1.3 General Protection

The Landscape Contractor shall allow for safeguarding and protection against damage due to the carrying out of the contract all existing and completed works by others, including kerbs, paths and ground.

Should any damage or loss be caused to any existing or completed works due to or, arising from the performance of the contract. Then the Landscape Contractor will be required to reinstate and make good any damage at his own expense, to the satisfaction of the Landscape Architect.

2.0 PROTECTION

2.1 Existing Vegetation

No existing trees, shrubs, or other plants shall be removed or cut without specific instruction. The Contractor shall protect, in the course of his work, all plants to be retained, from malicious or accidental damage.

2.2 Existing Soil

No soil, spoil, constructional materials or rubbish shall be stored or tipped within the spread of the existing trees, shrubs or hedges. No bonfires shall be lit in any situation where they can cause damage to existing trees, shrubs or hedges.

2.3 Existing Trees

If any tree which it is intended to preserve, be uprooted, destroyed, or in the opinion of the Landscape Architect, be damaged beyond reasonable chance of survival in its original shape due to the Contractor's negligence, then the Contractor shall without charge to the employer plant suitable replacement trees and shrubs of a similar type and age.

Removal of existing trees or shrubs shall include grubbing out to specific depth, and chemical killing of any stump or roots which require such treatment to the satisfaction of the Landscape Architect.

3.0 SOIL

3.1 Soil Stacking

All topsoil and subsoil cleared from building operations should be stored in separate heaps.

Topsoil shall be stacked in spoil heaps not more than 1.25m high and shall not remain unused for more than 12 months unless work is undertaken to turn the soil over to prevent it becoming stale. Weed growth on topsoil heaps shall be controlled by mechanical or approved chemical means to prevent soil becoming polluted with weed seeds.

3.2 Imported Soil

Imported topsoil to be from an approved source and conform to B.S. 3882, obtained from top 150mm of ground. It shall be fertile with a humus and fibre content, be of medium texture and approved before use. Imported topsoild is to be spread in layers not exceeding 150mm consolidated.

3.2

Continued

The topsoil shall be clean and the Contractor must allow for removing all stones and alien materials.

Any topsoil brought on to site without approval will be deemed to have been brought in at the Contractor's risk.

The pH reaction of the imported topsoil shall be the same as the existing topsoil unless otherwise stated by the Landscape Architect.

All rubbish to be carted off site by the Landscape Contractor.

4.0. GRADING

The Contractor shall grade the site to smooth flowing gradients, eliminating all abrupt angles and changes of levels. All earth sloping works to be carried out in consultation with the Landscape Architect and Local Authorities.representative on site.

4.1 Finished Levels

Topsoil levels shall be finished 25mm above adjoining pavings and 150mm below the damp course level of buildings after reasonable consolidation.

Final grading of the top 150mm is to be carried out to ensure a true specified level and slope ant to avoid dishing or other depressions where water may collect.

4.2 Rollers

The use of heavy rollers to roll out lumps will not be permitted and any area that becomes unduly compacted during the grading operation shall be loosened by forking and harrowing.

5.0 CULTIVATION

Ground unaffected by building operations can be cultivated by plough, rotovator or digging to a minimum depth of 150mm. It should be brought to a fine tilt and regulated to evenly running levels. All weeds, large stones, building rubbish should be cleared out and carted off site.

5.1 Planting Areas

All planting areas are to be cultivated by hand digging or where approved by mechanical rotovator to a minimum depth of 300 and cleaned free of weeds and rubbish to the satisfaction of the Landscape Architect.

All stones with one dimension greater than 38mm are to be cleared from surface and removed from site.

The Contractor to allow for destorying all weeds if owing to the time of year or other causes, there is a period of waiting between completion of the top-soiling and actual seeding or planting operations.

5.2 Peat

Peat used as an additive to the soil or as a mulch shall conform to BS 4156: 1967. It shall be procurred from an approved source, free from rubbish and when requested, the Contractor shall retain for the Landscape Architect's inspection a marked package or bale container.

5.3 Manure or Compost

Manure or compost used as an additive to the soil or as a mulch shall be procurred from an approved source and the Landscape Architect shall be informed of the material content before carting to the site. No compost to be used which has a grass clipping content exceeding 25%.

5.4 Chemical Fertilizers

Chemical fertilizers and sprays are to be used only where specified and measured and shall be applied strictly in accordance with the manufacturer's instructions. Only chemicals on the Agricultural Chemicals Approval Scheme current list of approved products may be used.

Apply Chemical fertilizer at the rate recommended by manufacturer.

5.5 Fertilizer

Fertilizer to be applied at the rate of 70g/M2 and incorporated into the soil by roughly raking.

5.6 Mole Draining

Where required the Landscape Contractor is to mole plough all areas to a depth of 600mm in parallel runs at 1,200 c/c using a 75 dia.mole.

6.0 GRASSING

The tilth shall be maintained free from weeds during any fallow period prior to sowing seed. Protect seed from damp and vermins until required.

6.1 Preparation

In preparation for sowing, the surfaces should be lightly and uniformly firmed and reduced to a fine tilth up to 25mm in depth by raking or harrowing. All large stones should be removed, and maintained weed free during any fallow period.

Preseeding fertilizer to be applied four days before seeding at the rate of 70 $\rm g/m^2$, applied in transverse directions and worked into the final tilth.

6.2 Germination

The germination capacity of each constituent of the mixture should be not less than 80% and the purity of mixture not less than 90%. Total weed seed content should be not more than 0.5%

Grass areas will only be accepted as reaching practical completion when germination has proved satisfactory and all weed will have been removed.

Damage, failure or dying back of grass due to neglect of watering shall be the responsibility of the Contractor.

No payment shall be made to the Contractor if the seed ails due to any cause whatsoever. He shall be required to make good the soiling and repeat the seeding until a good sward is obtained.

Seed Mixtures

Species Percentage of mix Restuca rubra (chewings fescue) Agrostis tennis (browntop bent) Lolium perenne (perennial ryegrass) Cynosurus cristatus (crested dogstail) Poa trivialis (rough stalked meadow grass) Percentage of mix 10%

6.4 Sowing

Sow grass seed at the rate of 45 g/m^2 during suitable calm weather.

After sowing the ground shall be raked or chain harrowed. The operation should be carried out in equal sowing in transverse directions.

6.5 Cutting

Large stones more than 38mm in diameter shall be removed before initial cutting and all areas rolled with a light roller to firm grass and press in remaining stones.

Grass to be cut with a roto-system so as to leave from 25 to 50 of growth. Grass cut during wet or dull weather should be spread evenly to prevent damage to the growing grass beneath.

6.6 Maintenance

Maintenance to consist of watering, weeding, cutting repair of all erosion, settlement and reseeding as necessary to establish a uniform and healthy stand of the specified grassed and shall continue for a minimum period of . 18 months after practical completion and until itiis accepted by the Landscape Architect.

Pernicious weeds to be treated with selective weedkiller applied twelve weeks after seeding if the grass was sown in the Spring.

Autums sown grasses to be treated in May/April the following year.

Weedkiller to be I.C.I. "weedkiller for New Grass Areas".

6.7 Defects

The contractor shall reseed any areas which fail to germinate, make up and seed over any depressions which develop after seeding and make good any areas not of the specified quality.

7.0 SPECIES

7.1 Origin

Trees and shrubs shall be true to name. Those which are normally propogated vegatively shall, if grown from seed, be stated to have been so produced. If subjects have been budded or grafted, this shall be stated and the name of the root supplied on request.

7.2 Conditions

Trees and shrubs shall be substantially free from pest and disease and shall be materially undamaged. Torn or lacerated roots shall be pruned before dispatch. No roots shall be subjected to adverse conditions, such as prolonged exposure to drying winds or subjected to water logging between lifting and delivery.

7.3 Rootball

The rootball shall be free from perennial weeds and conducive to successful transplantation. No variations from the plant schedules will be allowed except on written instruction from the Landscaping Architect.

8.0 TREES

Trees are to be best nursery stock and to B.S. 3936 Part 1. 1965 and 4, 1966.

Minimum tree sizes are indicated on the planting drawing. The Landscape Contractor is responsible for complying with three sizes. Notice shall be given to the Landscape Architect if the trees are not to this standard.

8.1 Pruning

Planted trees to have all broken branches pruned, damaged areas of bark to be neatly pared back to sound tissues and all cuts and wounds over 25mm in diameter to be treated with approved tree wound paint.

8.2 Rootball

Trees to have a minimum rootball diameter of 10 times the diameter of the stem measured 450mm above the ground.

8.3 Positions

No tree pits shall be dug until final tree positions have been pegged out for approval.

All plants to be refirmed into the ground if lifted by frost during the landscape contract. period.

9.0 SHRUBS

Shrubs to be of best nursery stock and to B.S. 3936 Part 1.

9.1 Position and Beds

Position of shrubs in beds to be pegged out before planting. Polyther and other non-perishable containers to be removed and any badly damaged roots carefully pruned.

9.2 Watering

Before planting of containerised shrubs, the shrub is to be thoroughly soaked in water before removing from container.

9.3 Planting

Plants to be set in holes so that the soil level _ after settlement will be at the original soil mark on the stem of the shrub.

planting pits to be backfilled to half its depth and firmed by treading. The remainder of the soil can then be returned and again firmed by treading.

9.4 On Completion

On completion of plant bed the surface is to be lightly picked over with a fork.

10.0 Tree Planting

Tree planting to be carried out in accordance with B.S. 4428; 1969.

10.1 Planting

Trees to be planted to the original soil depth. Allow for settling of the soil after planting. All non-perishable containers to be removed before planting.

Bare roots to be spread evenly in planting pit.

10.2 Tree Pits

Tree pits to be excavated to allow adequate clearance between root ends, or the perimeter of the ball and the side of the pit.

The depth of the pit to be 100 greater than the depth of the root system.

The bottom of the pit to be forked over to break up the sub-soil for a depth of 150. Return 75 thick layer of prepared backfill to the bottom of planting pit.

10.3 Backfill

The size of the pit shall be such to allow for the provision of not less than 0.75 cubic metres of backfill with best quality top soil, 1.25 litres of general purpose fertilizer and 10 litres of moist moss peat, well mixed.

Backfill to be placed around the roots generally shaking the tree to allow soil particles to shift into the root system to ensure close contact with roots. Backfill to be firmed as filling proceeds, layer by layer, care being taken to avoid damaing the roots.

11.0 TREE STAKES

Secure trees to FNo 75 dia (min) stakes. The stakes are to be driven into the ground before the tree is planted to a min depth of 750. The lower 850 of the stake is to be coated with a non-injurious wood preservative.

The remainder of the stake is to be painted with a selected sadolius or equal wood preservative.

The stake should be cut off just below the first crotch after the tree has been planted and berrs removed.

12.00 TREE TIES

Each tree is to be secured just below its lowest branch. The ties are to be strapped around the trees and nailed to the stake with galvanised nails. Ties are to be replaced or adjusted to allow for growth. Tree ties are to be approved by Landscape Architect before delivery on site.

13.00 SHRUB PLANTING

Shrub planting to be carried out in accordance with B.S. 4428; 1969.

13.1 Planting

Planting of shrubs to be carried out as soon as possible after reaching site. Where planting must of necessity be delayed, care is to be taken to protect the paints from pilfering or damage from people or animals. The contractor is responsible for all plants and planting pits until they are accepted by the Landscape Architect.

All planting areas to be maintained weed and grass—free during the contract period.

Shrubs to be planted to the original soil depth to allow for settling of the soil after painting. All non-perishable containers to be removed before planting.

13.2 Shrub Beds

All beds to be marked out and approved by Landscape Architect before planting. Planting hales to be 150 wider then the root system. The depth of the hole to be minimum 150 deeper then root system with the bottom of the pit forked over for a depth of 75.

13.3 Backfill

All shrubs to receive 6 litres of moist moss peat and 0.5 litres of general purposes fertilizer well mixed with good quality top soil. Return 50 thick layer of backfill to bottom of shrub pit before planting.

14.0 WEATHER CONDITIONS

Planting shall not be carried out during periods of frost, persistent winds, when the site is waterlogged and when the ground is frozen.

15.0 WATERING

The contractor is to water throughly all planting areas on completion of plantingm to the satisfaction of the Landscape Architect. The contractor is responsible for the supply.

16.0 PROTECTION ·

Contractor shall allow for the repair of all fencing erected during the contract and maintenance period.

17.0 MULCH

Mulch all shrub beds with 50mm deep moist peat, leaf mould grass mowings or other suitable organic material.

18.0 FORMING PLANTER AREAS

The landscape contractor to form planting beds where shown on layout drawings.

Planters to upper yard and to areas for wall climbing plants to be formed with precast conc. kerbs on conc. footings, as edging. Imported soil to be spread into pits to a min. depth of 600 for shrubs and 1000 for trees. Soil to be spread over backfill (to engineers detail).

Planting beds to river edge to be set into planting pits dug so as not to disturb existing soil or surrounding plants. Backfill soil to be as before to be set in and around the proposed plants.

Planting to area east of the proposed industrial units to be into imported top quality soil to a min. depth of 750.

I9.0 Herbicides

The landscape contractor is responsible for supplying and applying approved herbicides, which shall be on approved list or approved by the Dept. of Agriculture for use in such locations.

Paraquat

Paraquat based product, Gramoxone by ICI Plant Protection Ltd. Spray in accordance with manufactures instructions and protect all foliage of ptansplants and shrubs.

Simazine

Simazine based product, Groundhog by ICI Plant Protection Ltd. Spray in accordance with manufactures instructions.

20.0 Planting Season

Plant clean root decidious material between November and March inclusive.

Evergreen and conifer trees to be moved when ground is warm enough to encourage root development between September and October and between April and Mid-May.

Herbaceous plants shall be planted between September and October and between March and April.

Container grown plants can be planted all year round, all subjects to be moved only in warm weather. Water spraying, mulching, shading and anti-desiccant to be used when necessary.

No planting when ground is water-logged, or at times of excessive drought or frost.

22.0 MAINTENANCE .

All planted areas to be maintained for a period of I8 months, after practical completion. All defects, at the end of this period, due to materials or workmanship shall be replaced by the contractor.

After this period the maintenance contract to be revaluated and a maintenance contract to be agreed with a landscape contractor for inclusion in the maintenance companys works.

22.I GENERAL

Maintenance to include watering, weeding, cultivation, control of insects, fungus and other diseases by means of spraying with approved insecticide or fungicide and other horticultural operations necessary for the propoer growth of the plants and for keeping the planted and grassed areas neat in appearance.

22.2 Weeding

Shrub and tree areas to be hand forked and weeded at regular intervals throughout the I8 months.

22.3 Pruning and refirming

Trees and shrubs to be firmed up, restaked, tied or adjusted where necessary or directed by Landscape Architect. Dead or broken twigs are to be removed and pruning carried out according to species.

Large wounds to be treated with approved treatment.

22.4 Watering


Contractor to allow for thorough watering of all plants as necessary or when directed by Landscape Architect.

22.5 Replacement


Contractor is responsible for replacement at his own expense for all trees or shrubs which die from inadequate root preparations, lack of water or any cause over which the contractor has control, for a period of I8 months after practical completion

Tree Survey

Southern Tree Surgeons (Ireland) Ltd.

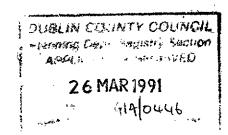

Springhow.

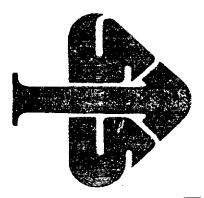

CATEGORY SYSTEM

- Indicates an outstanding tree which should be retained at all costs.
- Indicates the best of B category or a tree which would be worthy of A classification if it were given remedial treatment.
- Indicates an average for the site, i.e. those trees which should be kept unless there is a specific reason for their removal.

ಥ

- B/C decay in the near future. Indicates the worst of the B category or a tree which although healthy now may succumb to disease or
- Indicates a tree which is dead, dying or dangerous and which should be removed

a

Tree No.	Species	Age	Condition	Treatment Required	Category
					÷
		·		The first section of the survey commences in the extreme north-east corner of the site, close to the weir, and proceeds along the Edmondstown Rd. boundary along the Owendoher river.	
3457	Sycamore	Middle- aged	Poor	A multi-stemmed specimen, growing on a narrow bank. Its close proximity to river may indicate soil erosion and potential, future instability problems. Cut ivy and monitor in the future.B/C	.B/C
3458	E1m	Semi-mature	o =	Misshapen and leaning heavily. Little future potential. Remove.	C
	Willow	Mature	: =- -:	Collapsed across the river and is now partially "hung-up" in trees on opposite bank. Remove.	℃ _
3460	ä	2	=	-ditto-	C
3461	Group of Ash	Semi-matur	0 =	Misshapen. Little future potential. Remove.	
3462	Alder	Mature	Fa:	Heavily covered in ivy preventing close inspection. Cut ivy at base of tree.	.
3463	E 1 m	=	Poor	Twin-stemmed. In the latter stages of Dutch Elm Disease. Remove immediately.	Ω
3464	Beech	:	Fair	Some die-back in upper crown system but otherwise in good condition. Thoroughly overhaul and thin by 20%. Monitor future progress.	œ
3465	Elm stump			A large stump which is infected with Polyporous squamosus. Stability is highly questionable. Remove immediately.	C
3466	0ak	=	Fair/poor	Severe lean towards centre of site, possibly due to "wind-blow" and a restricted rooting area. Plan for its removal.	в/с

Tree No.	Species	Age	Condition	Treatment Required	Category
3467	Ash	Mature	Fa a i	Tall, spindly specimen with sharply forked upper crown system. Thoroughly overhaul and lightly thin.	
3468	Laurel	3	Poor	Severe limb loss and heavy lean towards river. Little future contential. Plan for its removal.	- 1
3469	Elm stump		3	Little remains of this tree but it could still present some Chazard to road users. Remove.	
3470	Horse Chestnut	=	71 8 1. 7	, .	<u>-</u> —
3471	11	11	Fair/poor	lts in	<u>C</u>
3472	Elm	=	Fair/poor	In the initial stages of Dutch Elm Disease and has little future potential. Remove.	
3473	Sycamore	Mid-aged	=	s at base.	В
3474	E] m	Mature.	Dead	Heavily covered in ivy. Upper crown system appears to be extremely heavy and liable to imminent collapse. Fell immediately.	
3475	Willow	. =	Poor	Has collapsed in the past and is now lying along the bank. This tree is still alive and growing and I do not think it present. No work required at present.	B/C
3	•				

Tree No. Species	s Age	Condition	Hadillell indular
3476 Elm	Mature	Poor	In the middle stages of Dutch Elm Disease. Partial collapse C is likely. Remove in the immediate future.
3477 Willow	11	= ;	system otentia
3478 Elm	=	Fair/poor	Is only slightly infected with Dutch Elm Disease but its future is limited. Plan for its removal.
3479 Lime	11	Fair	od health but its origin is q has arisen as regrowth from orage may be questionable. T
			ced back. Larger IImps over live: 300000
3480 Elm	Midaged	=	mb to Dutch Elm Disease. Plan for rem
	Mature	Poor	Severely misshapen due to harsh pruning to clear wires. No B, practical means of repair. Remove.
3482 Beech	11	= -	A massive specimen, severely infected with Ganoderma applanatum, a severe butt rotting fungus which is common to Beech and renders the tree structurally unstable and liable to "wind-blow" or partial collapse. This tree is slightly unbalanced towards and is very close to, the roadway and I would suggest that it and is very close to, the roadway and sers. Fell immediately.
3483 "	Mid.—aged	=	Suppressed and badly misshapen with a severe cavity at 0.5 m. C
	=	Fair	Not yet affected by Dutch Elm Disease but it has limited B/C future potential. Plan for its removal.

Tree No.	Species	Age	Condition	Treatment Required
3485 '	Elm	Mature	Poor	In the advanced stages of Dutch Elm Disease and is liable to Collapse. Remove immediately.
3486	Beech	=	a	A massive specimen which is infected with both Ustulina deusta and Ganoderma applanatum. Both these fungi undermine a tree's structural stability, rendering it liable to "wind-blow" or partial collapse. Remove.
3487	Alder	Mid.—aged	Fi a 1:	Twin-stemmed with slight lean towards river. No work recommended at present.
34881	Horse Chestnut	Mature		No sign of any fungal activity. The crown system appears to be healthy. It is sharply forked at 3 m. and, for this reason, I would urge you to have the tree thinned by approx. 25%, paying particular attention to heavier limbs overhanging the road, the upper crown system, and two limbs growing towards the river.
3489	Alder	Midaged	=	
3490	=	. =	3	-ditto-
3491	Horse Chestnut	Mature	Poor	Has been severely lopped in the past leading to cavity formation and severe crown distortion. Little future potential Plan for its removal.
3492	Alder	=	Fair/poor	esent.
3493	Willow	=	Poor	Has suffered severe ground disturbance due to installation of drainage system. Little future potential. Remove.
•				

Tree No.	Species	Age	Condition	Treatment Required
	· .			At this point, we crossed over the river and proceeded in a northerly direction back towards the lodge.
3494	H.Chestnut	Mature	71 21. 7	A massive specimen with minor breakages throughout the crown system. Although this tree is in good health, I doubt if it would survive any developments. The upper crown system is supported by many large, heavy limbs which, in this species, can be somewhat brittle, leading to limb collapse. If this tree is to be retained, I would recommend that branch end thinning be carried out (approximately 30%) in an attempt to reduce weight and wind resistance. Please note that a close watch should be kept on this tree after any developments take place on this site.
3495	Alder	emi-matu	re Poor	Partially collapsed. No future potential. Remove.
3496	=	Mature	ਜ ਹ ਹ ਹ ਤ	A well balanced specimen but covered in ivy. Cut ivy at base. Fell adjacent suppressed Sycamore and leaning Alder, plus two dead Alders on riverside of tree.
3497	Willow	Mid.—aged	= 1	Slight lean towards river. Cut ivy at base.
3498	Alder		Dead	Fe11.
3499	= = = = = = = = = = = = = = = = = = = =	Semi-mature	re Fair/popr	Heavily covered in ivy and slight lean towards centre of site. Little future potential. Remove.
3500	=	id.ag	F 20	vy. Cut ivy at base.
3501	Sycamore	3	=	Slight ivy covering and rooted at base of bank. Erosion may cause problems in future years. Cut ivy at base.

Tree No.	Species	Age	Condition	Treatment Required
3502/3	2 Elms	Mid.—aged	Dead	Fell.
3504	Ž.	=	Fair	Heavily covered in ivy. Cut ivy at base. Reinspect when ivy has withered. $$B^{\circ}_{\circ}$
3505	E'a	Semi-mature	re	Dead. Fell.
3506	Sycamore	Midaged	Poor	Slightly suppressed and missshapen. Little future potential. B/C Remove.
	- 10-10-10-10-10-10-10-10-10-10-10-10-10-1			At this point, we reached the old lodge house and turned in a westerly direction and surveyed the northern boundary of the site.
3507	Cypress		-	Dead. Fell.
3508	E1 m	Mature	. =	In advanced stages of Dutch Elm Disease and is liable to partial or total collapse. Fell immediately.
3509	Cypress	· =	Good	
3510	Yew	2 -	=	Has previously been worked upon and is in good health. This tree is well worthy of retention.
				From this point, towards the next corner, is mostly taken up with Hawthorn, sapling Ash, and Elderberry and these have not been tagged.
3686	E1m	2	Dead	Liable to collapse in the near future. Fell immediately.
•				

Tree No.	Species	Age	Condition	Treatment Required
				At this point, we reached the upper corner of this field and turned and moved along the boundary in a line towards the old house.
3687	Elm	Mature	Dead	liable to partial or total collapse in the future. Fell immediately.
3688	Sycamore	Midaged	7F 90 1'1	Slightly misshapen by larger neighbour and has a slightly restricted root system on boundary wall bank. Medium future potential. Overhaul and cut ivy at base.
3689	Ash		re.Good	Good future potential. No work required at present.
3690	Elm	=	Dead	Remove.
3691	Sycamore	1 1 1 1 1 1 1 1 1 1 1 1 1 1 1 1 1 1 1		apen by
3692	Elm	Midaged	Dead	efore
3693	=	Mature	==	Fell in the immediate future.
3694	Sycamore	=	Fair	Thoroughly overhaul and lightly thin by 20%, paying particular attention to removal of deadwood and stumps from throughout the crown system.
3695	E]m	=	Dead	Remove in the immediate future.
				At this point, we crossed the new driveway and inspected a large Oak and Monkey Puzzle.
3696	Oak	2	T1 Q2 -1: T3	Severely damaged by recent storms. Numerous tears and stumps throughout the crown system. Thoroughly overhaul, paying particular attention to removal of deadwood, tears, rips and stumps from throughout the crown system.

Tree No.	Species	Age	Condition	Treatment Required
3704	Scots	Mature	Fair/poor	Upper crown system slightly unbalanced and major anchorage roots have been severed on driveside. Little future potential. Plan for its removal.
3705	Ti Ti	= -	e a r	Slight signs of decline throughout crown system. Remove deadwood and stumps. Reassess after development works.
3706	Douglas Fir	=	=	Slightly misshapen and suppressed by larger neighbours. Above average amount of deadwood within crown system. Thoroughly overhaul.
3707	· =	- =	. =	Large amount of ideadwood and stumps within crown system. Thoroughly overhaul.
3708	TI .	=	=	Seemingly in good health with only a small amount of deadwood throughout crown system. Thoroughly overhaul.
3709	Scots		Fair/good	Clean out deadwood and stumps from throughout crown system.
3770	Ho11y	Midaged	Good	No work required at present.
3711	Douglas	Mature	Fair	Clean out deadwood and broken branches from throughout crown system.
3712	7	=	=	Small crown area but appears to be in good health. Clean out deadwood and stumps from throughout crown system.
3713	Douglas Fir	=	=	Thoroughly overhaul, paying special attention to removal of deadwood, stumps and broken branches from throughout crown system.
•				

TREE SURVEY:

 3724	3723	3722	3721	3720			3719	3718	3/1/	3717	3716	3715	3714	Tree No.
=	Douglas Fir	=	3	Monkey Puzzle			=	Holly		=	Douglas Fir	Holly	Scots Pine	Species
Midage	Mature	=	=	Mid.—aged		** <u>*</u>	Semi-matu	Midaged		=	Mature	Semi-mature	Mature	Age
 c Fair/poor	=	=	Fair:	Fair/good			re Good	=		=	=	re Fair	Good	Condition
Suppressed by larger peighbours. Slightly misshapen after Future potential questionable. Overhaul. Reinspect after after	Thoroughly overhaul, removing deadwood, stumps, broken branches, and hanging branches from throughout crown system.			Remove low deadwood.	-		to-	at present.		t misshapen	s and	ed at present.	Thoroughly overhaul, paying special attention to removal of deadwood, stumps and broken branches from throughout the crown system.	Treatment Required
в/с	B		. .	р <u>х</u>	^ / R	17		A/B	B/C	-	8	-	A/B	Category

Tree No.	Species	Age	Condition	Treatment Required	Category
3795	Scots	Midaged	Poor	Suppressed by larger neighbours. Almost completely dead.	C
3706	Douglas	Mature	Fair	y misshapen by larger neighbours. Overhaul.	5 37
T C T C	Fir			Remove deadwood from	
3727	Fir	=	2	balanced and nicely shaped. Remove deadwood itom ughout crown system.	- Β
3728	Douglas	- =	= =	Slightly misshapen and sharply forked at 3.0 m. Thoroughly overhaul and install one mild steel flexible cable to support the sharply forked crown system and lighten one low lateral limb pointing away from driveway.	8 <u>=</u>
3729	3	3	Fair/poor	Severely misshapen and unbalanced. Little future potential. Plan for its removal.	B/C
3730	Scots	=	Fair	Remove deadwood from throughout crown system.	, , , ,
3731	Douglas Fir	- =	. =	Thoroughly overhaul.	, ,
3732	- =	=	=	=	,
3733		=	=	<	Ç
3734	Douglas Fir	=	z	Thoroughly overhaul and remove deadwood from throughout crown system. At the same time, inspect stump at 3 m. from ground.	8
3735	· =	=	Poor	Badly misshapen and suppressed by larger neighbour. Little future potential. Fell.	C
					

Badly misshapen and suppressed by larger neighbours. Little	Poor	Midaged Poor	Scots	3736
Treatment Required Category	Condition	Age	Species	Tree No.
DATE OF SURVEY:			EY:	TREE SURVEY:

B/C	Upper crown system severely unbalanced towards entrance gates. Overhaul, and remove deadwood and broken branches from throughout crown system. Reinspect on a regular basis.	Fair/poor	9	:	3/42	
	overhaul.		:	Fir		
7		11	Mature	Douglas	3741	
- S	-ditto-	=	Midaged	Scots Pine	3740	L
₽ -	-ditto-		11	11	3739	-
	Thoroughly overhaul and remove deadwood and broken branches from throughout crown system.	=	=	Douglas Fir	3738	
æ	Slightly unbalanced. Clean out deadwood from throughout crown system and install cable to support side fork.	Fair	Mature	Ti Ti		
C	Badly misshapen and suppressed by larger neighbours. Little future potential. Remove.	Poor	Midaged Poor	Scots Pine		
			·			
Catego	Treatment Required	Condition	Age	Species	Tiee NO.	

Elms in this area have already died and the remainder have limited future potential. This, together with evidence of trees which have collapsed in this area, in the recent past, leads me to believe that there is little here worthy of At this point, we looked at the small wooded area to the rear of the old_house. The majority of these trees are middleretention. severely pruned in the past and are now unstable. Numerous of the old house. The majority of these trees are middle-aged Ash, Elm and Sycamore. A large number of them have been